


BUILDING ADDITION:
BLOOMFIELD FARMS
BUILDING ADDITION
575 SPENCER-MATTINGLY LANE
BARDSTOWN, KY 40004

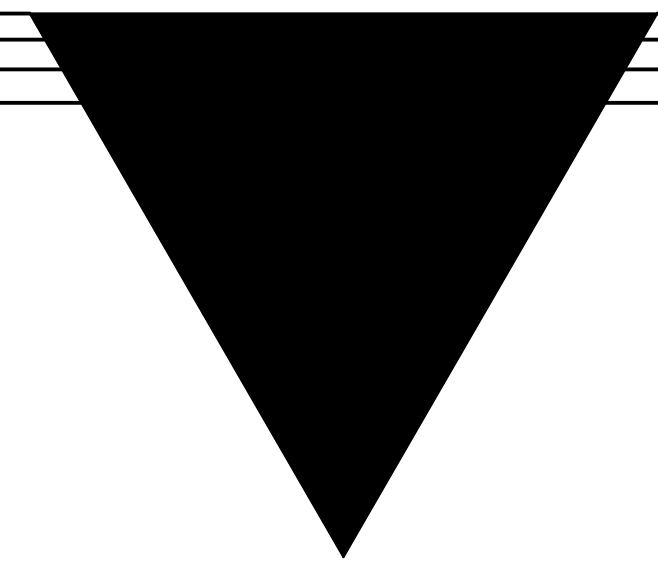

ARCHITECT:


KEYES ARCHITECTS AND ASSOCIATES
4717 PRESTON HIGHWAY
LOUISVILLE, KENTUCKY 40213
PH: (502) 636-5113
CONTACT:DEBBY BIRD
EMAIL:DBIRD@KEYESARCHITECTS.COM
ARCHITECT: CHARLES J. KEYES III

CONTRACTOR:

BCD CONSTRUCTION, INC.
1962 FILIATREAU LANE
BARDSTOWN, KY 40004
PH: (502) 348-2305
CONTACT: JASON HARROD
EMAIL: JHARROD@BARDSTOWN.COM

OWNER:

BLOOMFIELD FARMS INC.
575 SPENCER MATTINGLY LANE
BARDSTOWN, KY 40004
PH: (502) 348-1333
CONTACT:
EMAIL:

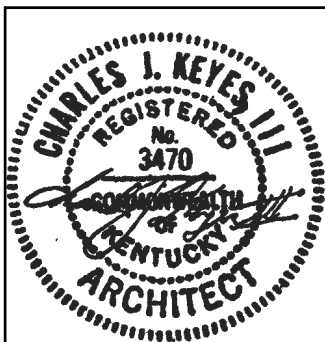

PROJECT INFORMATION

APPLICABLE BUILDING CODES
KENTUCKY BUILDING CODE 2018
ICC/ ANSI 117.1 2009
IECC 2012

USE AND OCCUPANCY: F-1

CONSTRUCTION TYPE: II-B

BUILDING INFORMATION

EXISTING BUILDING: 29,580 S.F.
BUILDING ADDITION: 18,105 S.F.
TOTAL BUILDING SIZE: 47,685 S.F.
FIRE SUPPRESSION: FULLY SPRINKLERED

OCCUPANCY ALLOWANCE

FUNCTION OF SPACE	ALLOWANCE	AREA	OCCUPANCY
EXISTING WAREHOUSE	500 GROSS	29,580	60
NEW WAREHOUSE	500 GROSS	18,105	37
TOTAL OCCUPANCY ALLOWANCE:			97

REVISIONS:

NOTE SYMBOL

Sheet List Table

Sheet Number	Sheet Title
T1.01	Title Sheet
Foundation Plans & Details	
F1.01	Foundation Plan
F2.01	Foundation Details
Life Safety Plans	
LS1.01	Life Safety Plan
Exterior Elevations	
A2.01	Exterior Elevations
A8.01	Stair Details
Specifications	
SP1.01	Specifications
SP1.02	Specifications




NOTE: GENERAL CONTRACTOR RESPONSIBLE FOR COORDINATION OF ALL SUB TRADES AND REQUIREMENTS BY OWNER


NOTE: ELECTRICAL, HVAC AND PLUMBING TO BE RELOCATED PER FEDERAL, STATE AND LOCAL CODES
GENERAL CONTRACTOR TO COORDINATE.

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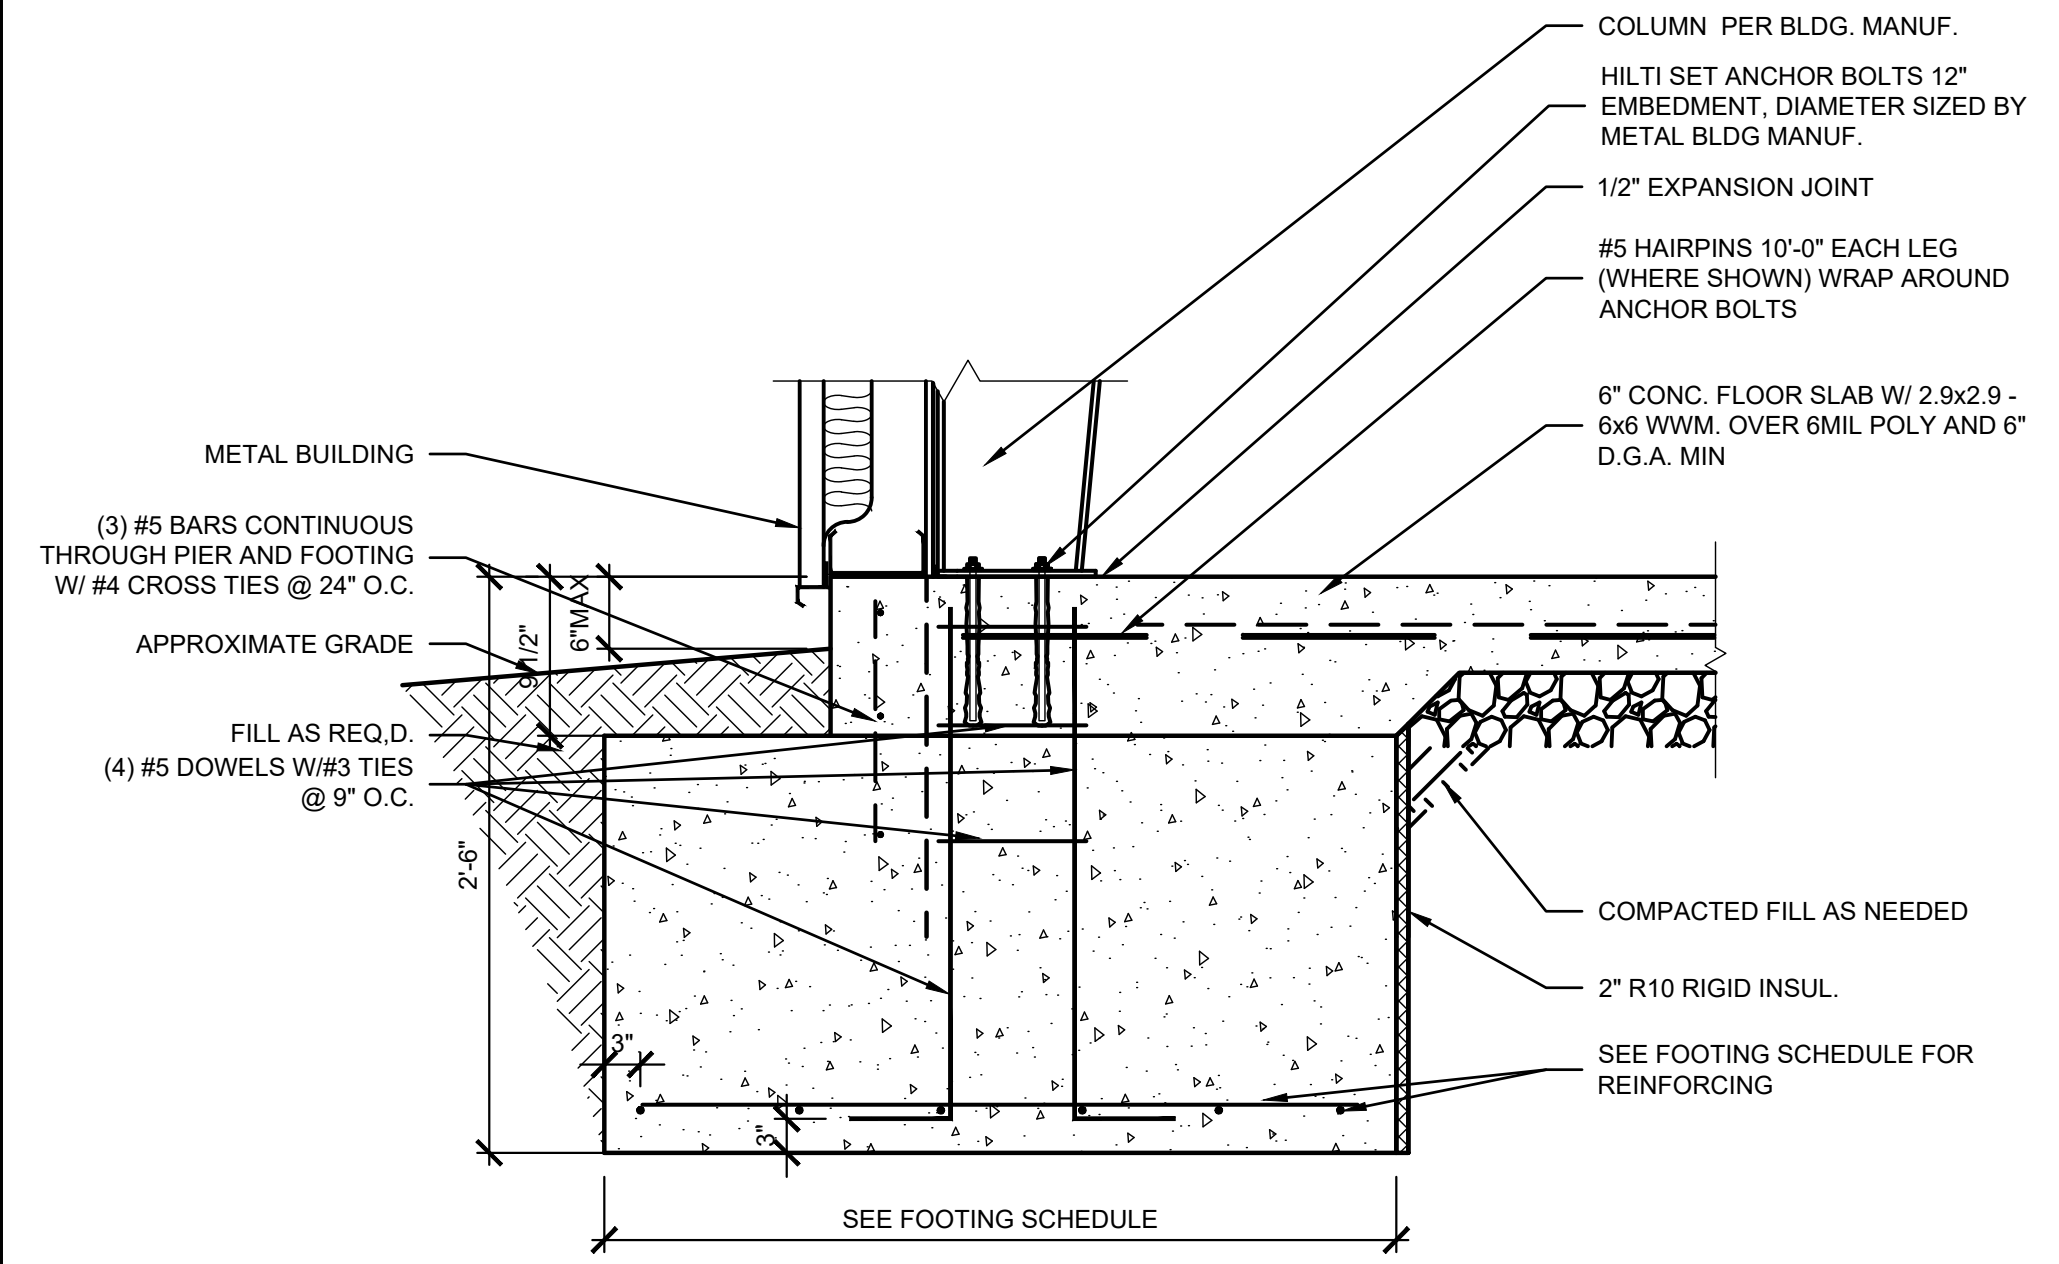
PROJECT: BLOOMFIELD FARMS BUILDING ADDITION - FILE: F2.01 Foundation Details.dwg - DATE: Nov 17, 2020 10:58AM - BY: DEBBY BIRD

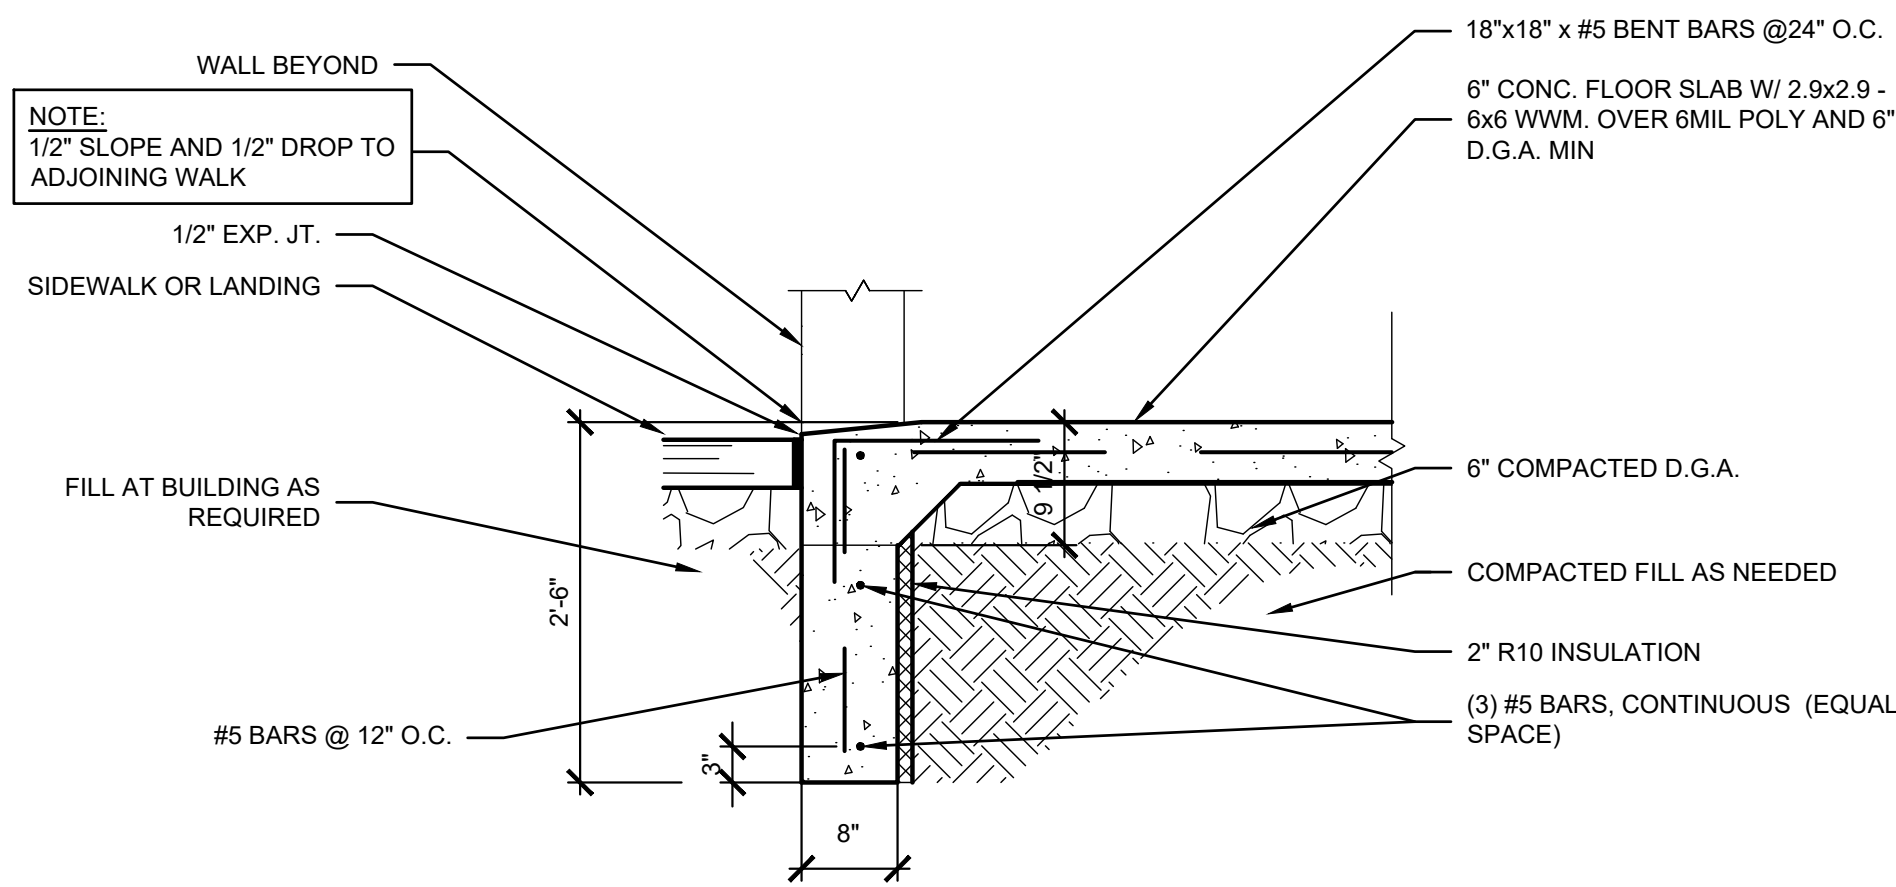


01 FOUNDATION THRU DOOR
SCALE: 3/4" = 1'-0"

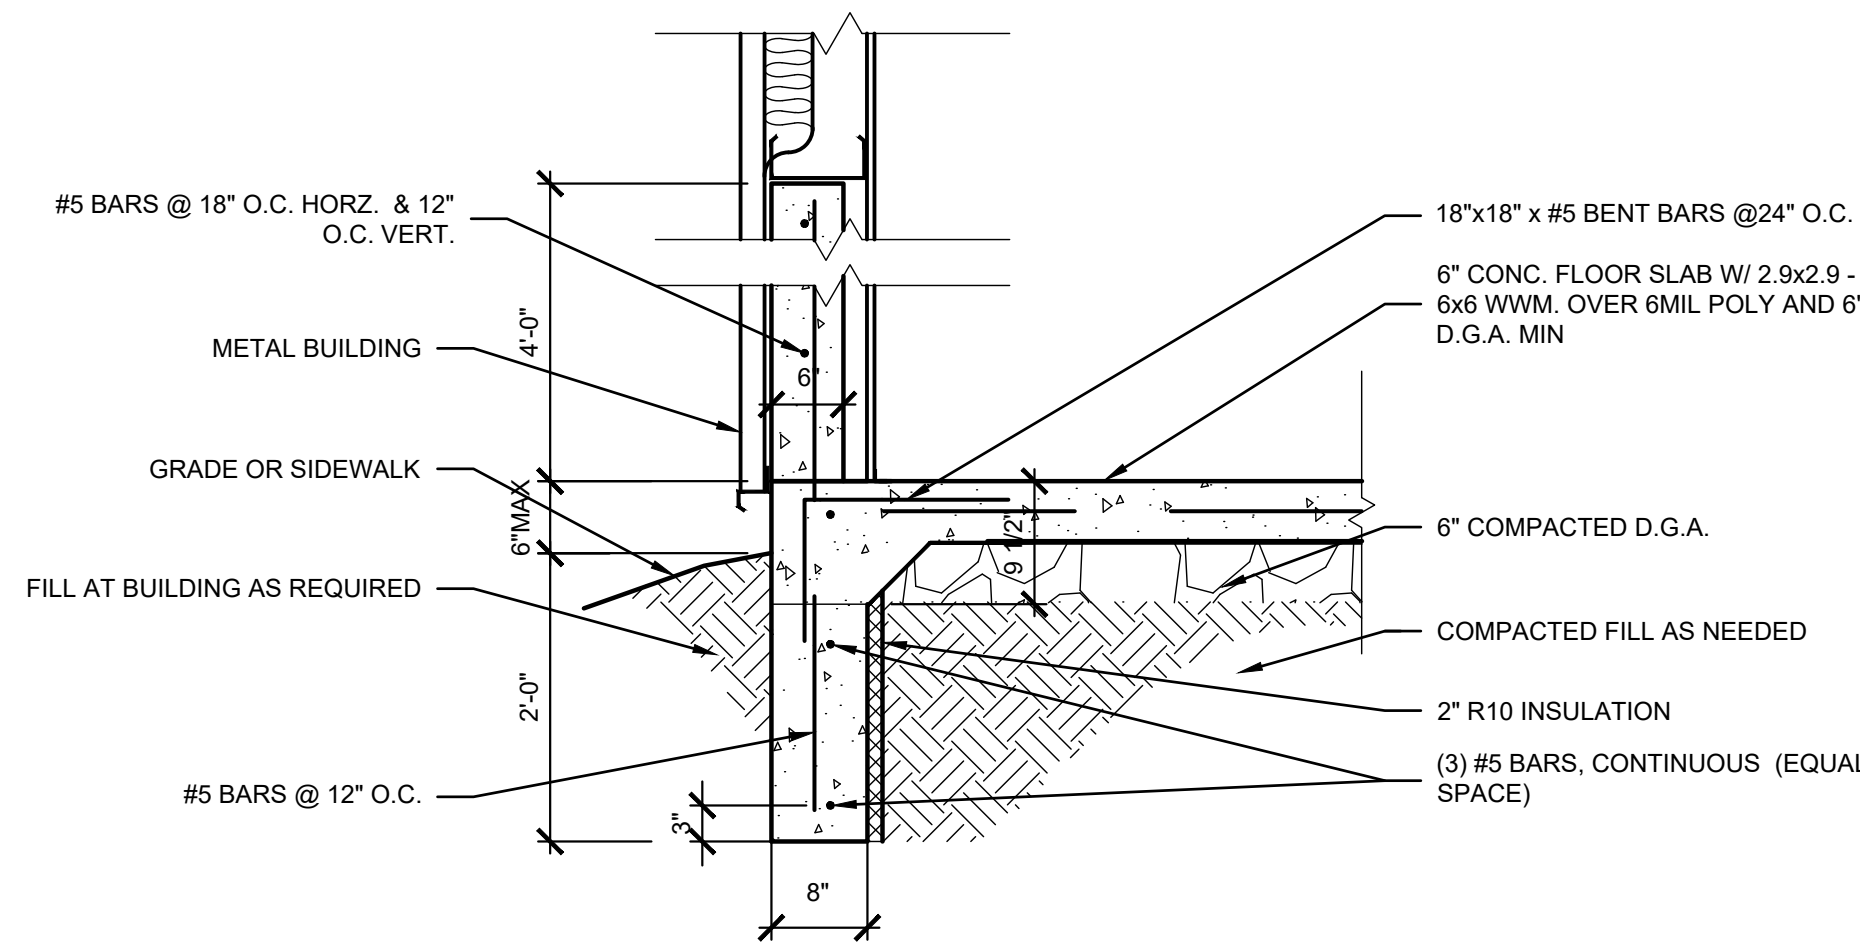


02 GRADE BEAM DETAIL
SCALE: 3/4" = 1'-0"



03 COLUMN FOUNDATION DETAIL
SCALE: 3/4" = 1'-0"

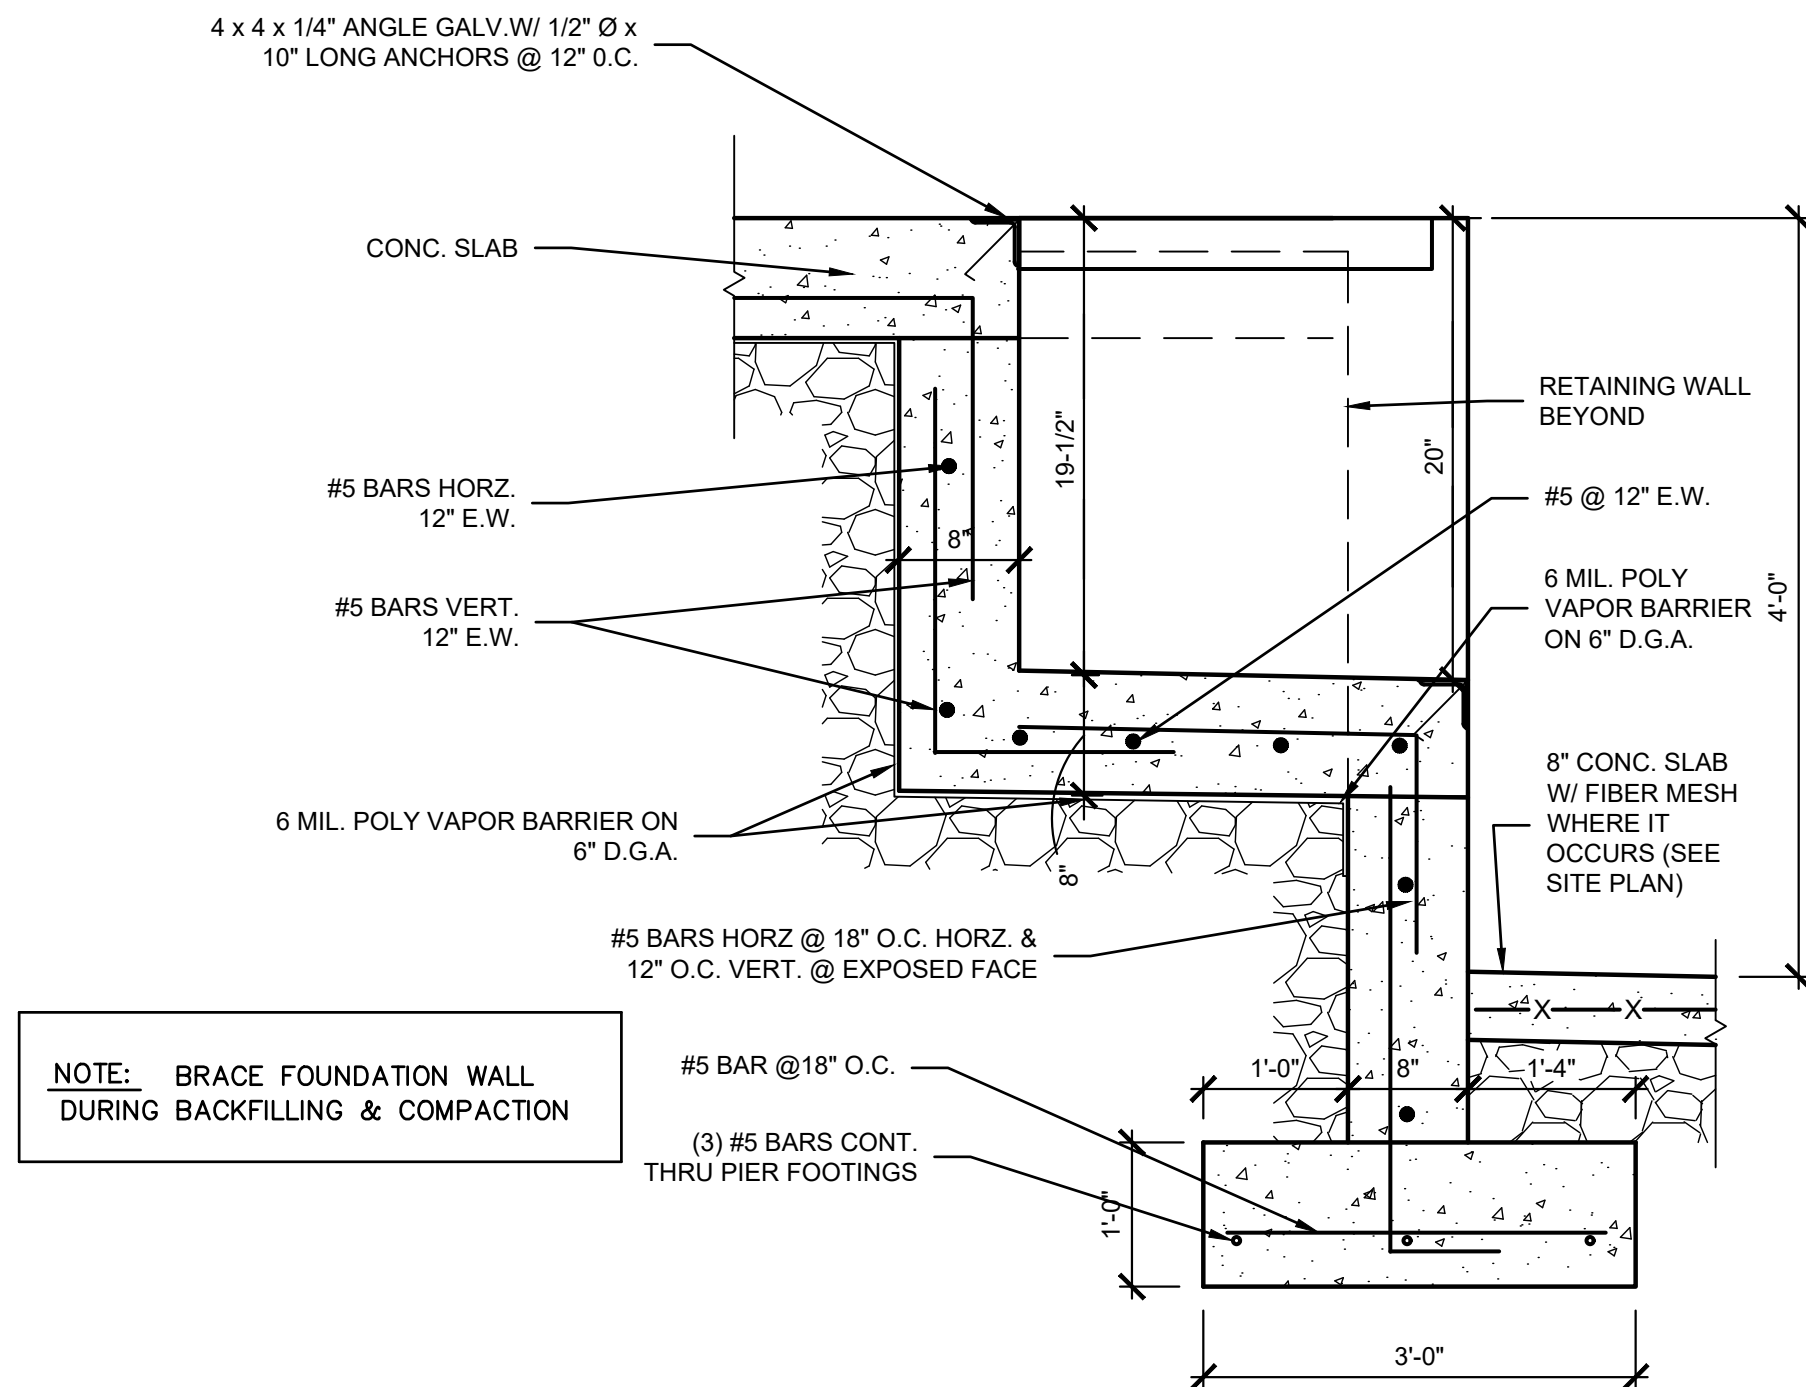


04 FOUNDATION AT DOCK LEVELER
SCALE: 3/4" = 1'-0"

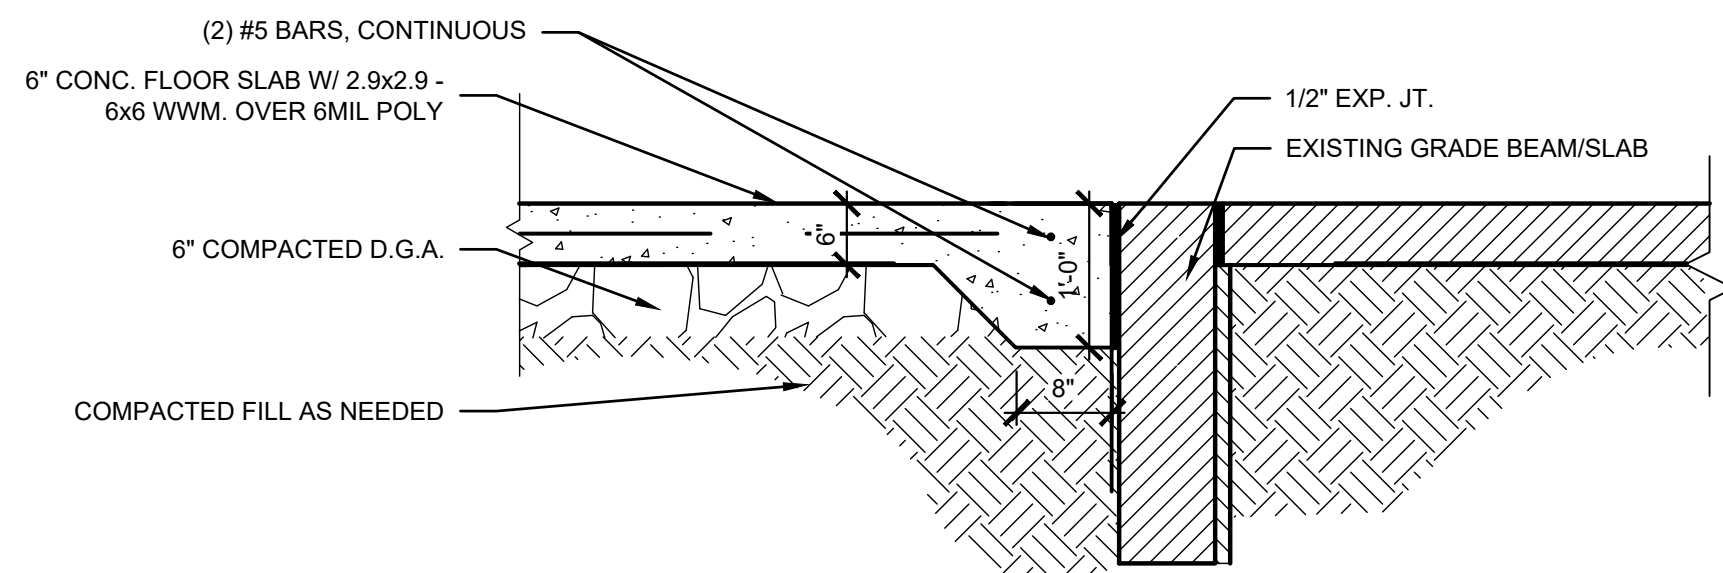


05 FOUNDATION AT EXISTING BUILDING
SCALE: 3/4" = 1'-0"

NOTE: BRACE FOUNDATION WALL DURING BACKFILLING & COMPACTION

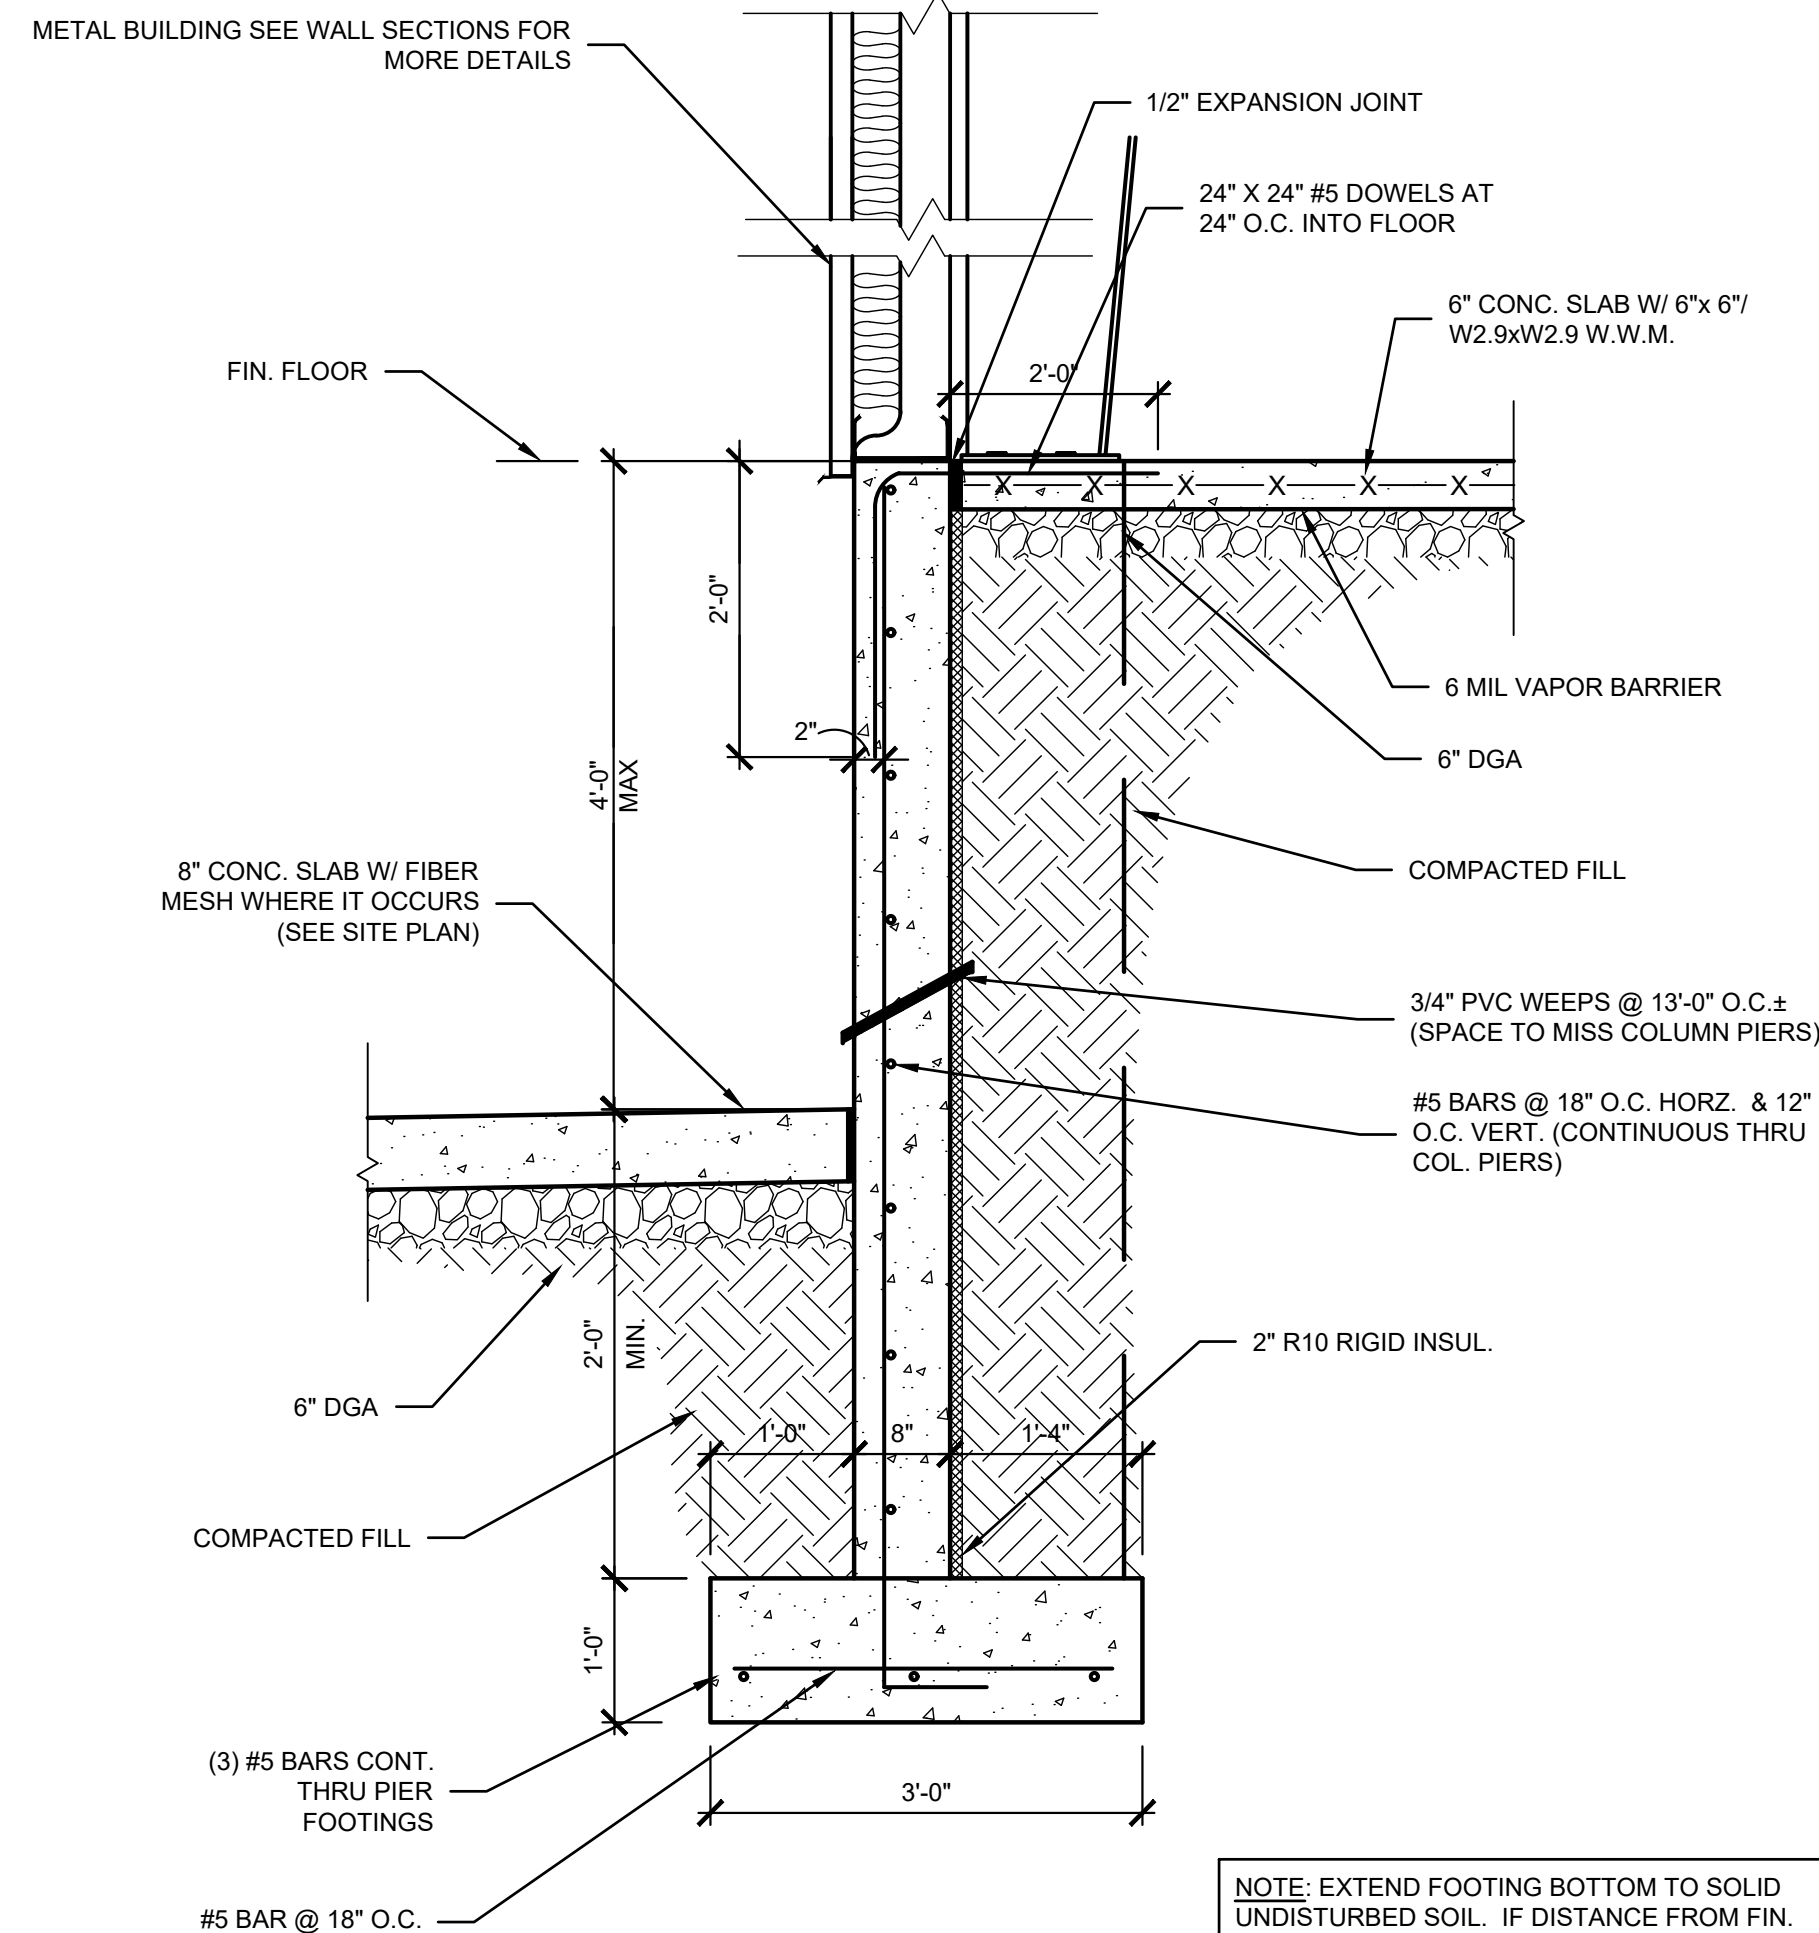

NOTE: EXTEND FOOTING BOTTOM TO SOLID UNDISTURBED SOIL. IF DISTANCE FROM FIN. GRADE TO BOTTOM OF FOOTING EXCEEDS 4'-0" NOTIFY ARCHITECT BEFORE PROCEEDING.

06 DOCK WALL FOUNDATION
SCALE: 3/4" = 1'-0"

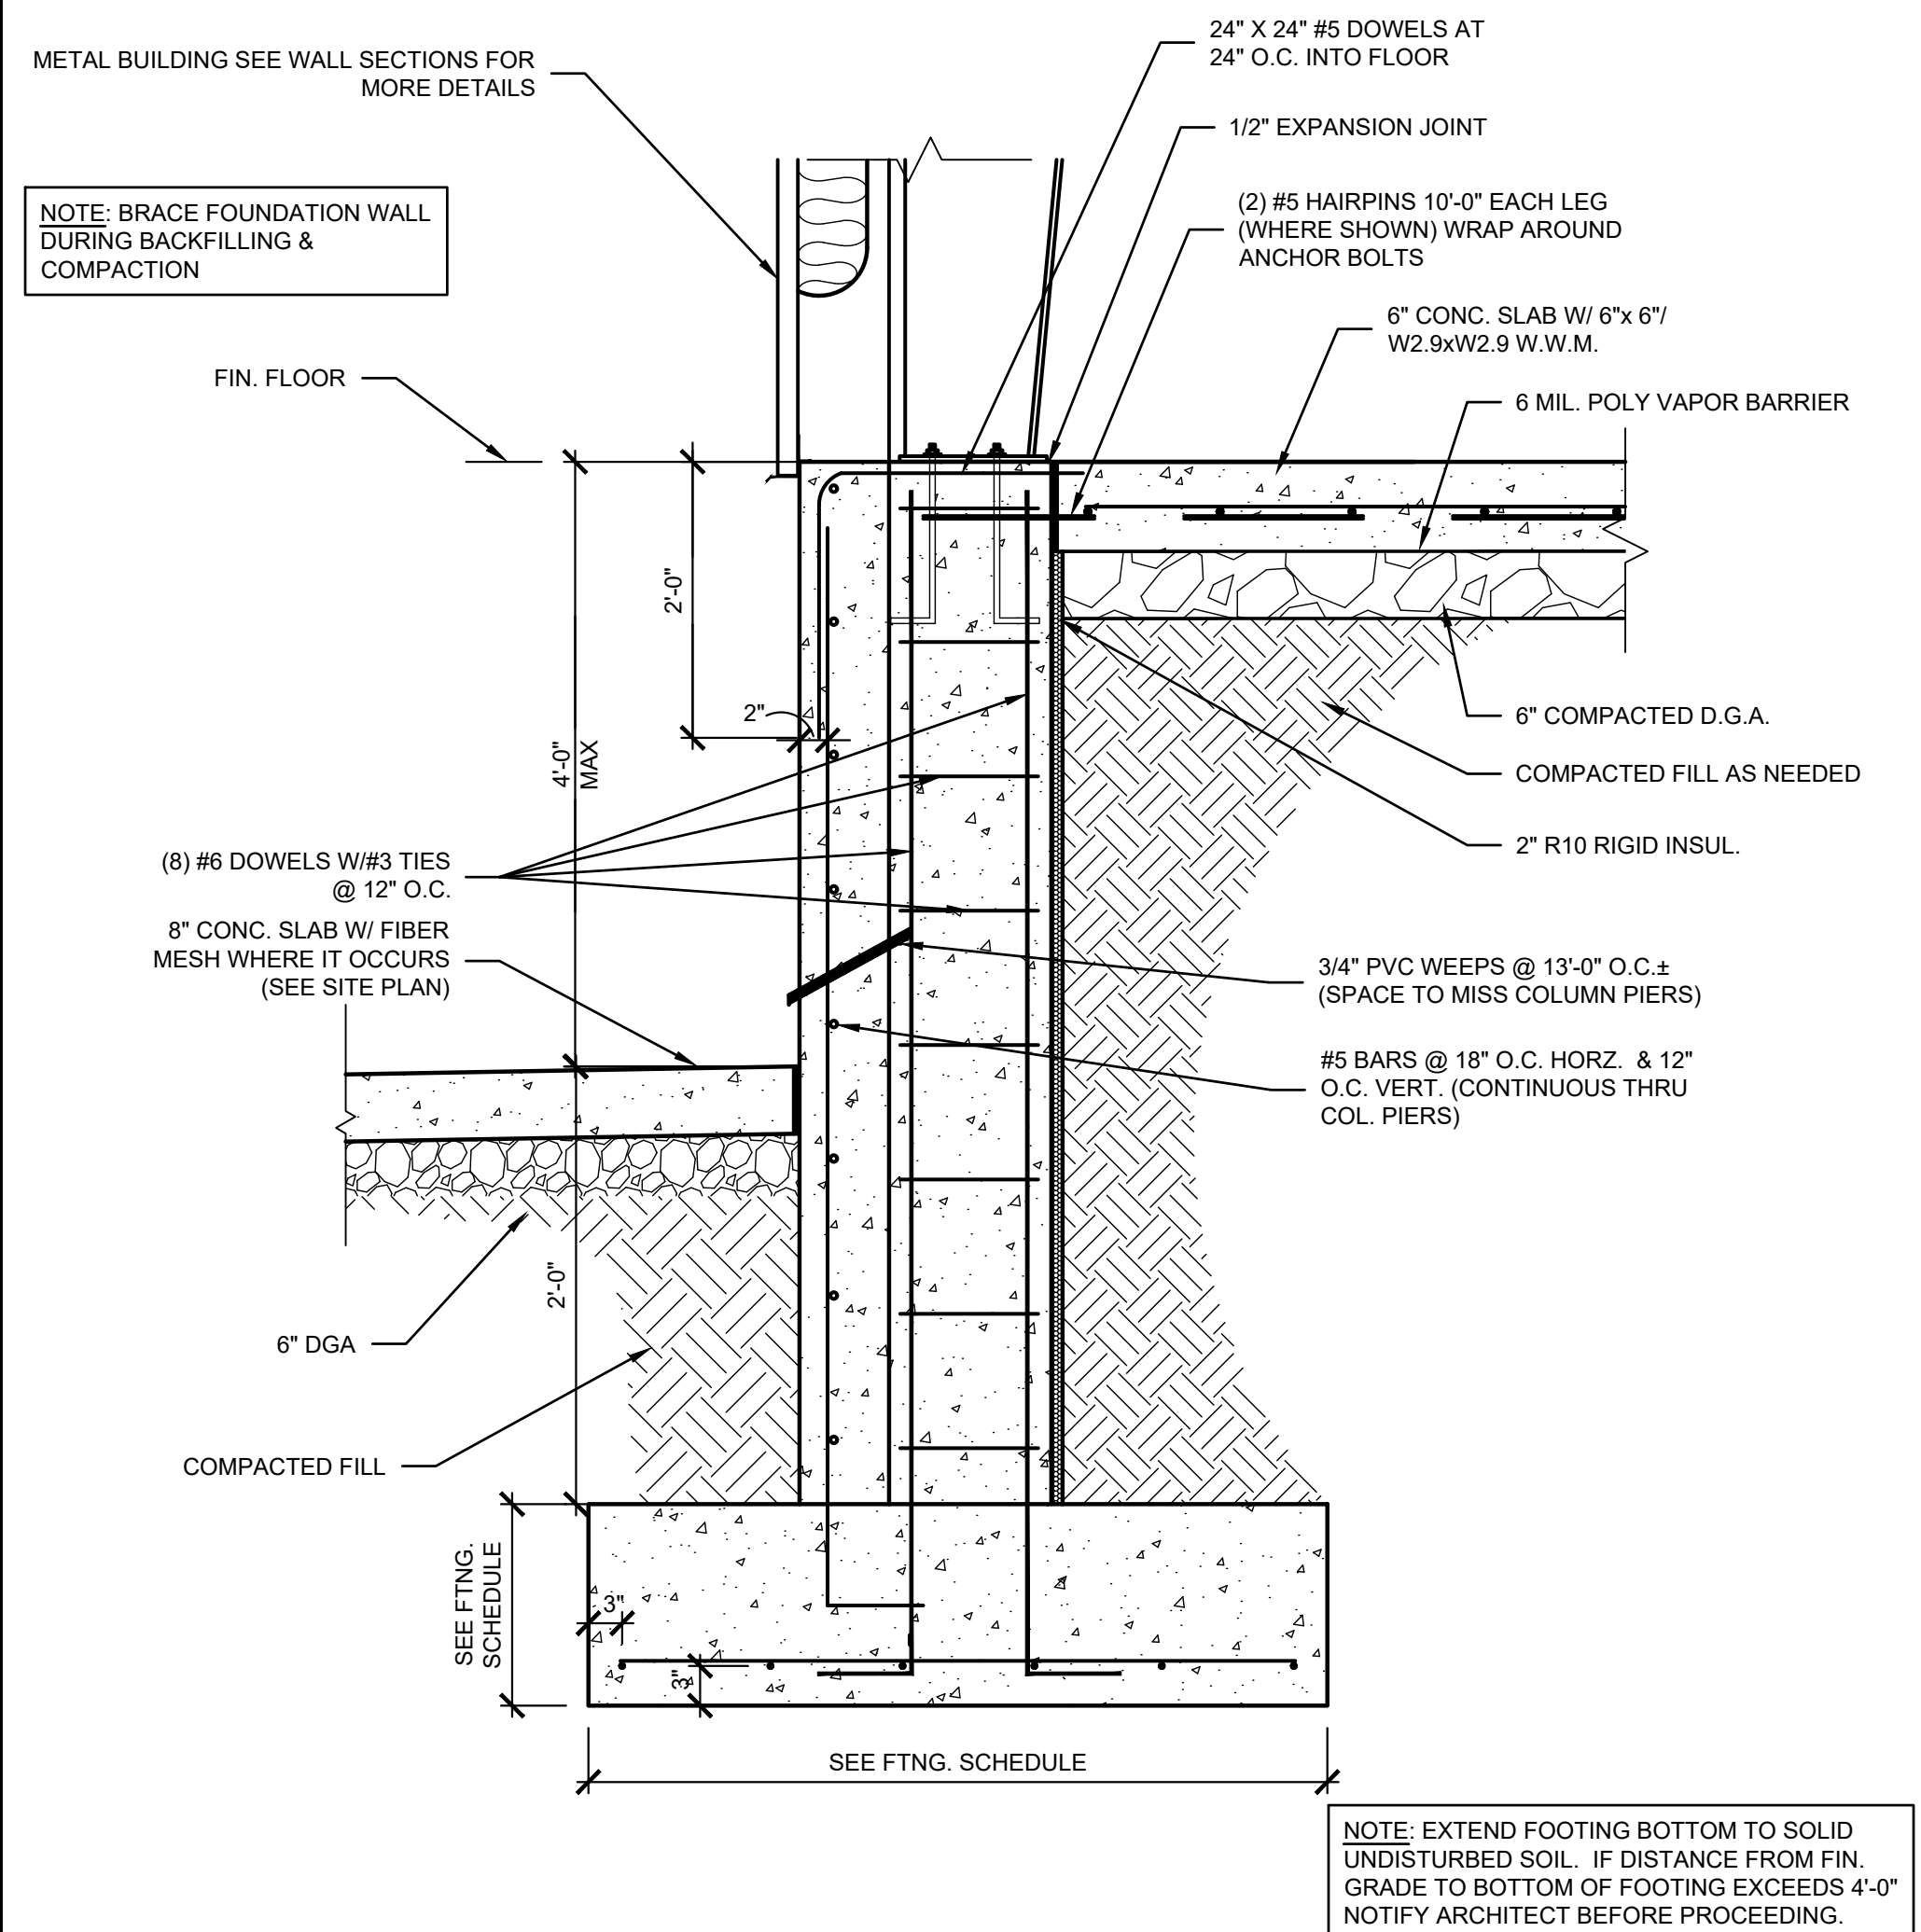

NOTE: EXTEND FOOTING BOTTOM TO SOLID UNDISTURBED SOIL. IF DISTANCE FROM FIN. GRADE TO BOTTOM OF FOOTING EXCEEDS 4'-0" NOTIFY ARCHITECT BEFORE PROCEEDING.

07 RETAINING WALL COLUMN FOUNDATION DETAIL
SCALE: 3/4" = 1'-0"

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DATE:
11-17-2020




KEYES ARCHITECTS & ASSOCIATES
4717 PRESTON HIGHWAY
LOUISVILLE, KENTUCKY 40213 (502) 636-5113

BUILDING ADDITION:
**BLOOMFIELD FARMS
BUILDING ADDITION**
575 SPENCER-MATTINGLY LANE
BARDSTOWN, KY 40004

FOUNDATION DETAILS

F2.01

PROJECT: BLOOMFIELD FARMS BUILDING ADDITION - FILE: LS1.01 Life Safety Plan.dwg - DATE: Nov 17, 2020 10:59AM - BY: DEBBY BIRD

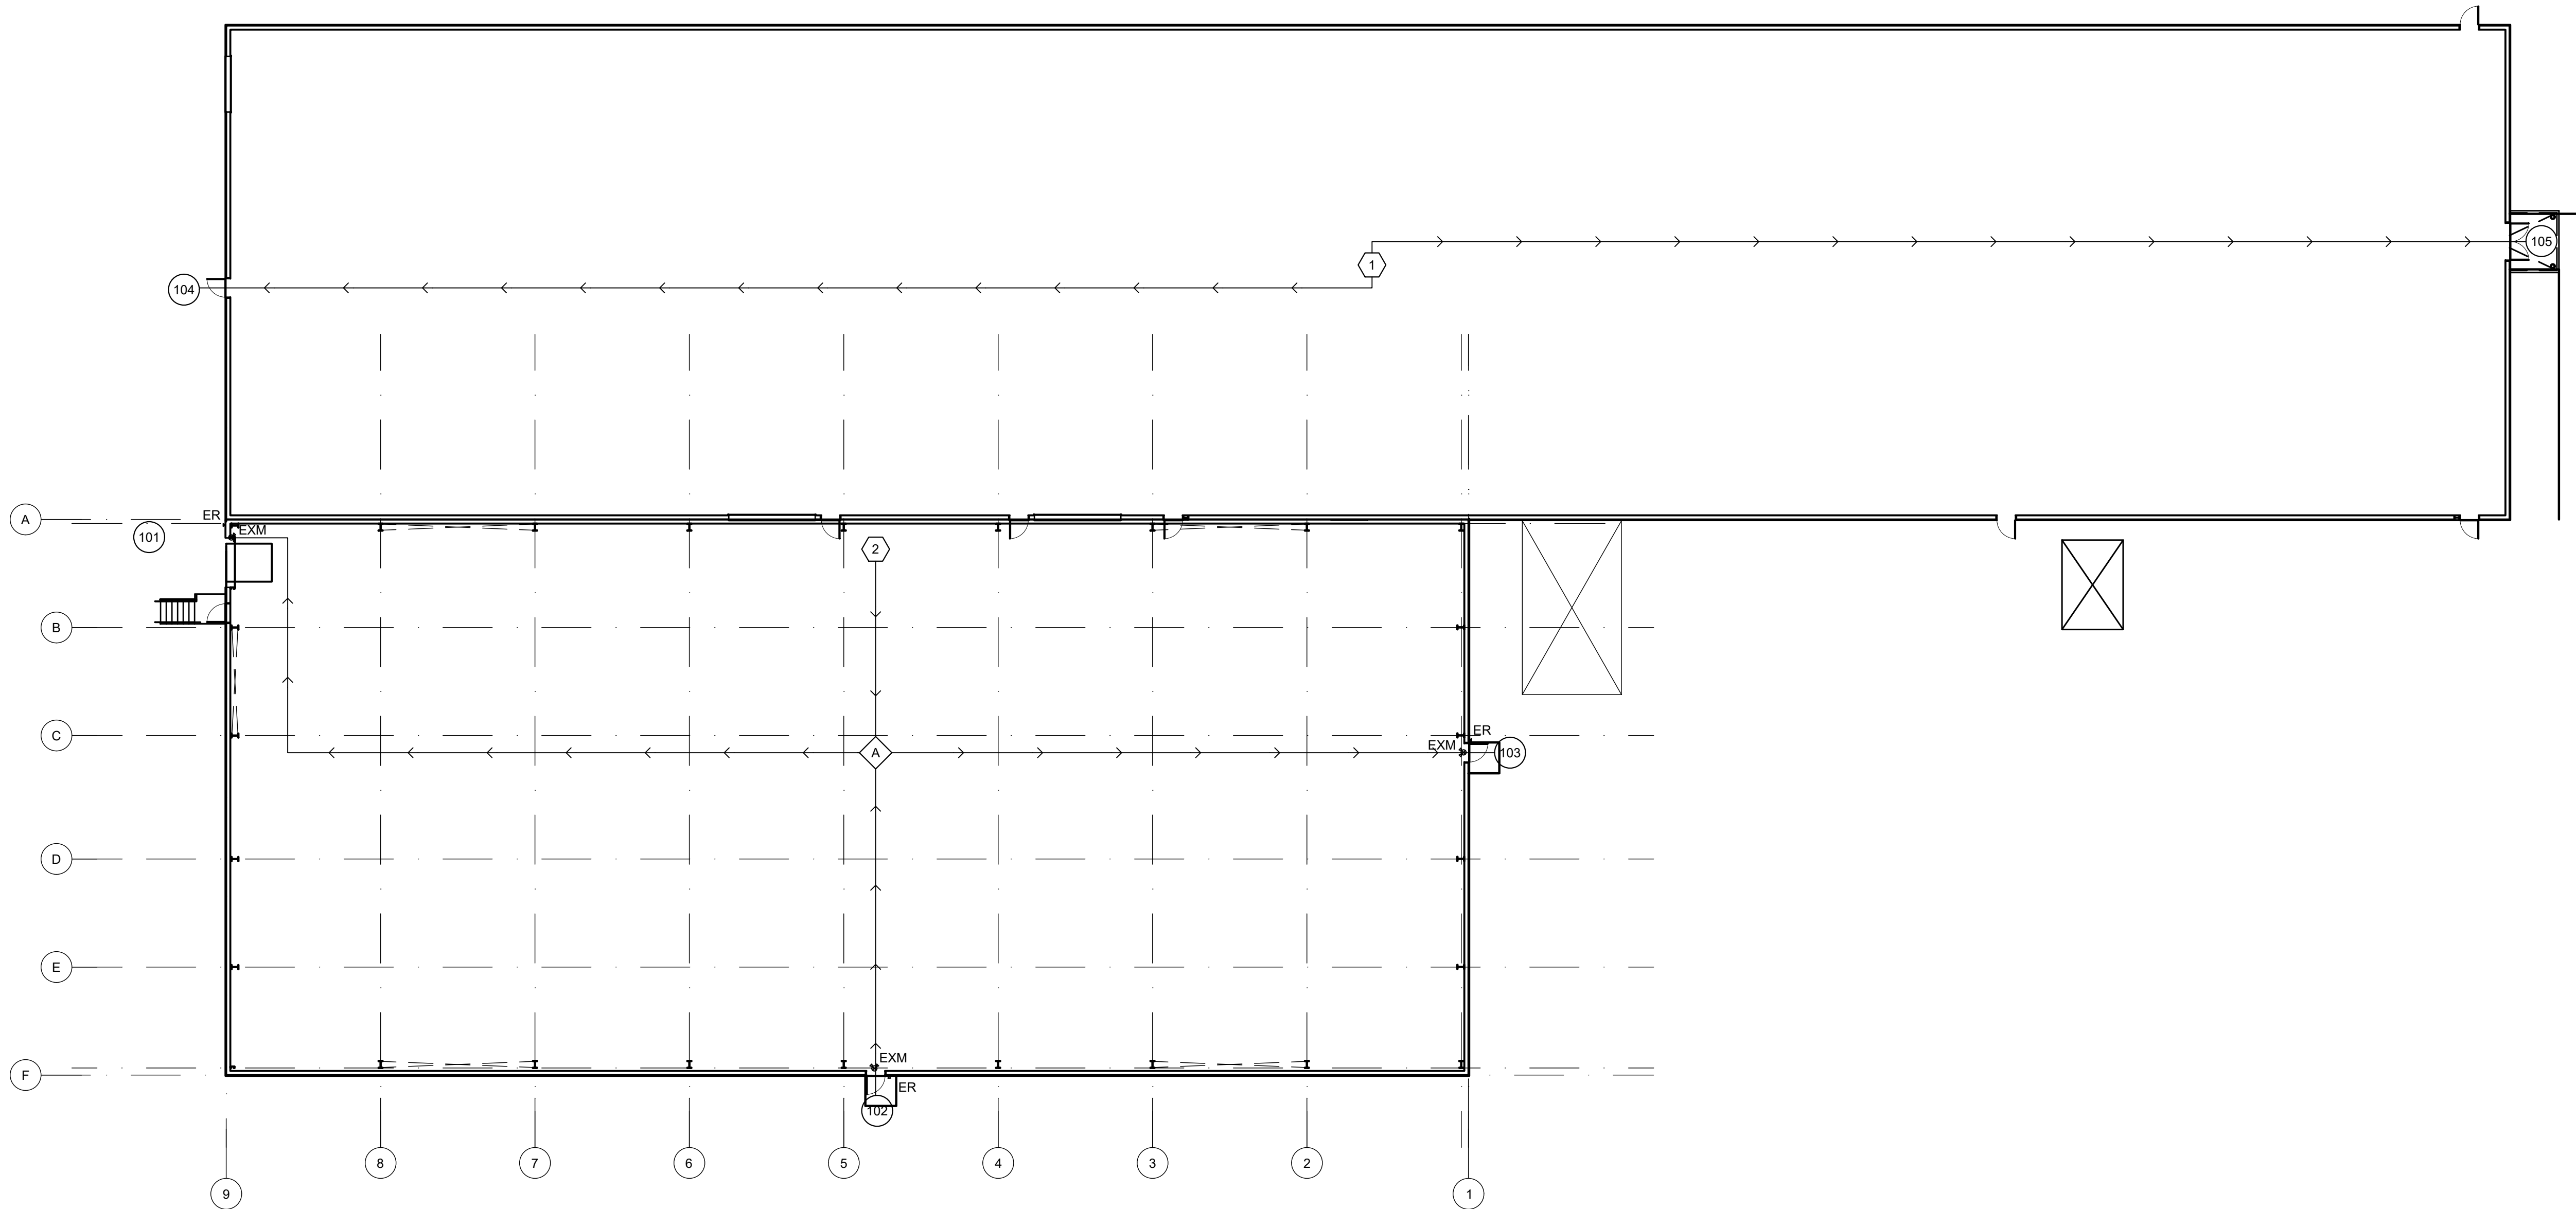

01

LIFE SAFETY PLAN

SCALE: 1/16" = 1'-0"



CODE ANALYSIS

CATEGORY	CODE REFERENCE	REQUIREMENT/DESIGNATION	PROVIDED
CONSTRUCTION TYPE	TABLE 503 / 602		II-B
OCCUPANCY GROUPS	304.10000		F-1
OCCUPANCY LOAD	TABLE 1004.1.1	WAREHOUSE 500 S.F. PER OCCUPANT	EXISTING BUILDING 60 OCCUPANTS BUILDING ADDITION 37 OCCUPANTS 97 TOTAL OCCUPANTS
ALLOWABLE AREA	TABLE 503	62,000 S.F.	47,685 S.F.
	SECTION 507		
EXIT CALCULATIONS	SECTION 1014.3	COMMON PATH OF EGRESS TRAVEL GROUP	250 FT
	SECTION 1016 TABLE 1016.2	EXIT ACCESS TRAVEL DISTANCE	100 FT

EMERGENCY LIGHT FIXTURE SCHEDULE

TYPE	DESCRIPTION	MODEL#	BULBS
ER ▽	EMERGENCY REMOTE HEAD	LITHONIA #ELA-NX-H0606	INCLUDED
EM ⬅	EMERGENCY LIGHT W/ BATTERY PACK REMOTE HEAD WHERE SHOWN	LITHONIA #6ELM2P	INCLUDED
EXM ⊗	COMBINATION EXIT/EMERGENCY FIXTURE W/ BATTERY PACK	LITHONIA #LHQM-S-W-1-R-120/277-HO	INCLUDED

NOTE: EXIT EMERGENCY LIGHTING IS ON AN "NL" CIRCUIT

LIFE SAFETY PATHWAYS

			TOTAL TRAVEL DISTANCE				
LOCATION	COMMON PATH		DOOR NUMBER				
			EXIT 101	EXIT 102	EXIT 103	EXIT 104	EXIT 105
1	-	-	-	-	-	189'-0"	189'-0"
2	A	30'-0"	172'-10"	98'-0"	137'-0"	-	-


PATHWAY KEY PLAN:

→	: TRAVEL PATH W/ DIRECTION OF FLOW
⬡#	: TRAVEL PATH STARTING LOCATION, WHERE "#" = LOCATION COLUMN IN THIS TABLE.
⬡#	: COMMON PATH LOCATION, WHERE "#" = LOCATION COLUMN IN THIS TABLE.
⬡#	: EXIT DOOR LOCATION, WHERE "#" = DOOR IN THIS TABLE AND IN DOOR FINISH SCHEDULE.


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LIFE SAFETY PLAN


BUILDING ADDITION:
BLOOMFIELD FARMS
BUILDING ADDITION
575 SPENCER-MATTINGLY LANE
BARDSTOWN, KY 40004

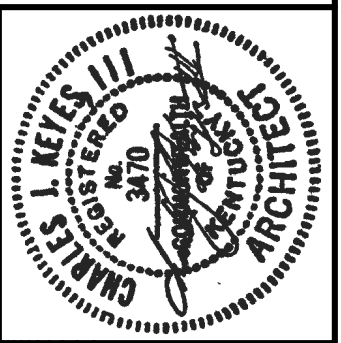


KEYES ARCHITECTS & ASSOCIATES
4717 PRESTON HIGHWAY
LOUISVILLE, KENTUCKY 40213 (502) 636-5113

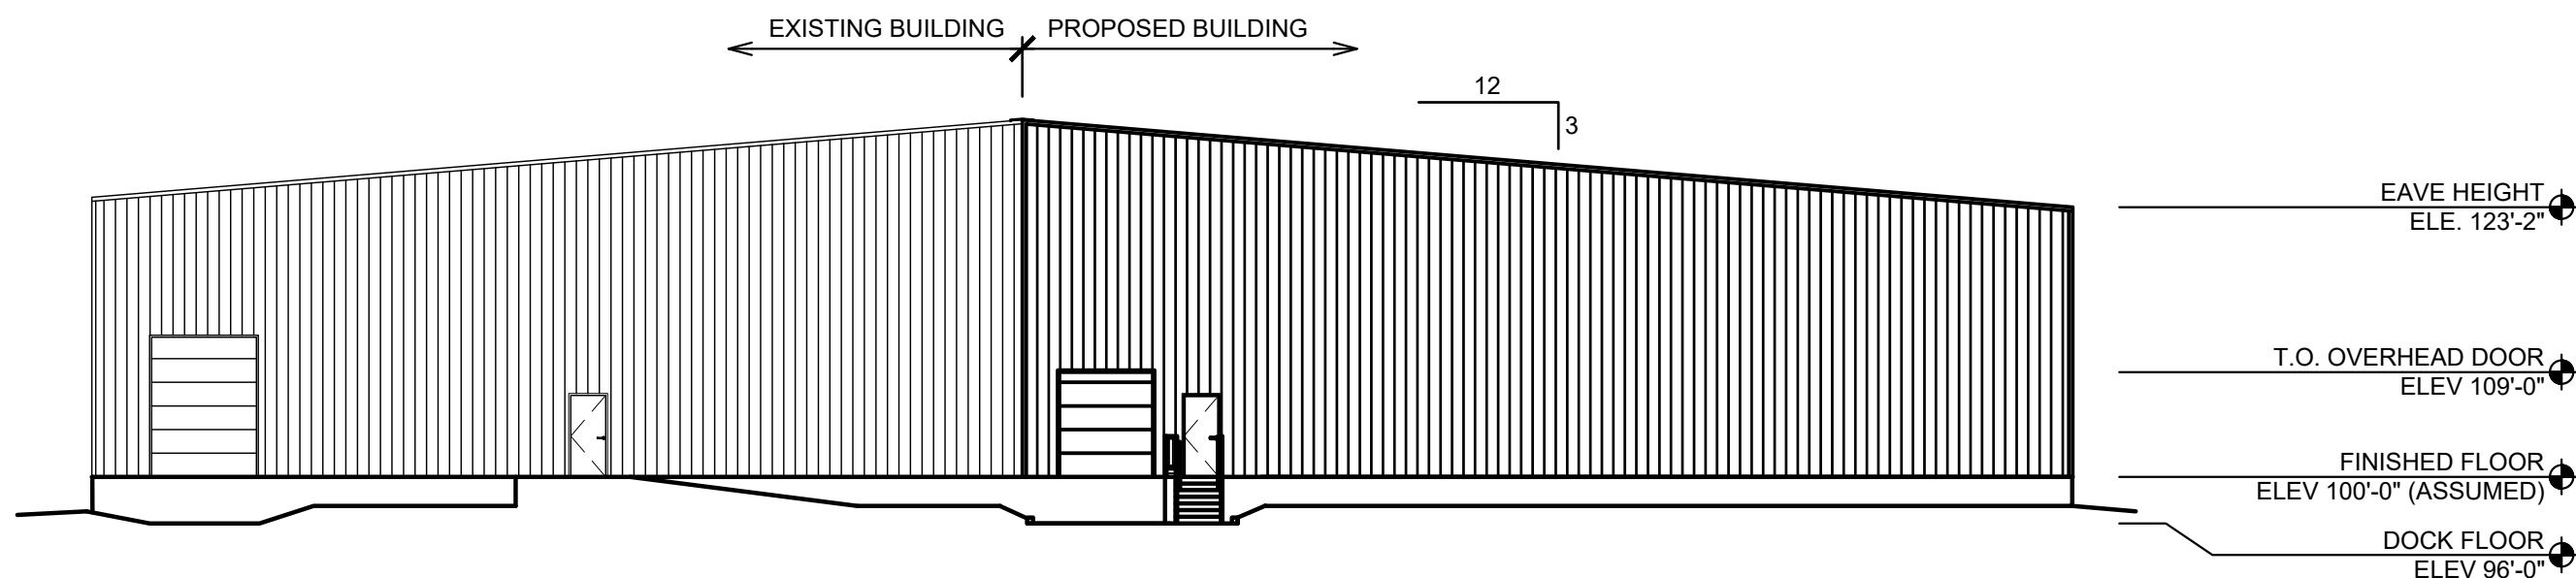

01 REAR ELEVATION
SCALE: 1/16" = 1'-0"

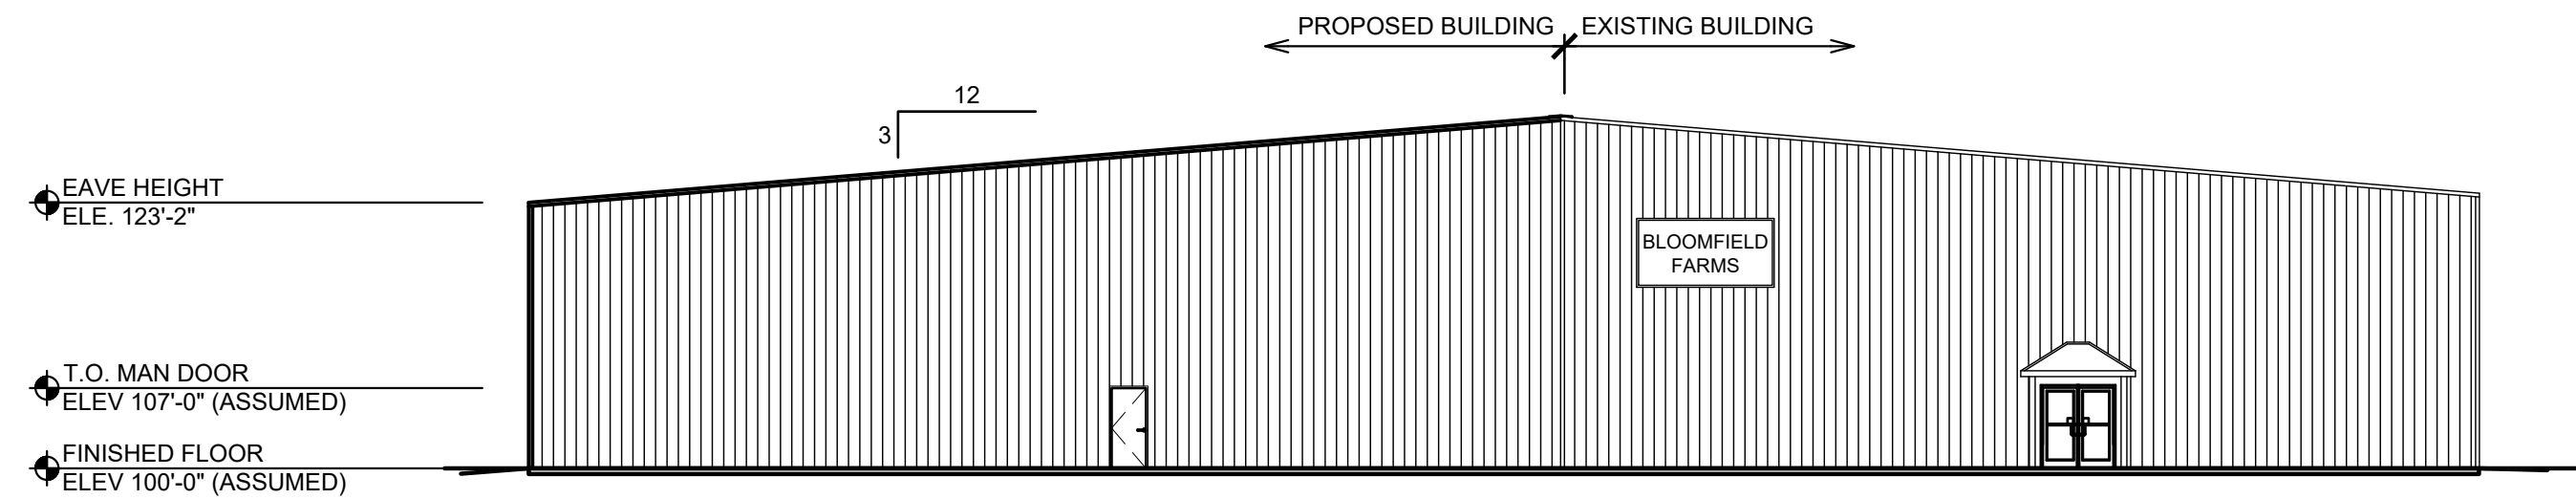


02 STREET FRONTAGE ELEVATION
SCALE: 1/16" = 1'-0"

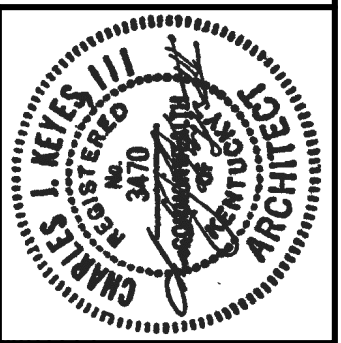

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BUILDING ADDITION:
**BLOOMFIELD FARMS
BUILDING ADDITION**
575 SPENCER-MATTINGLY LANE
BARDSTOWN, KY 40004

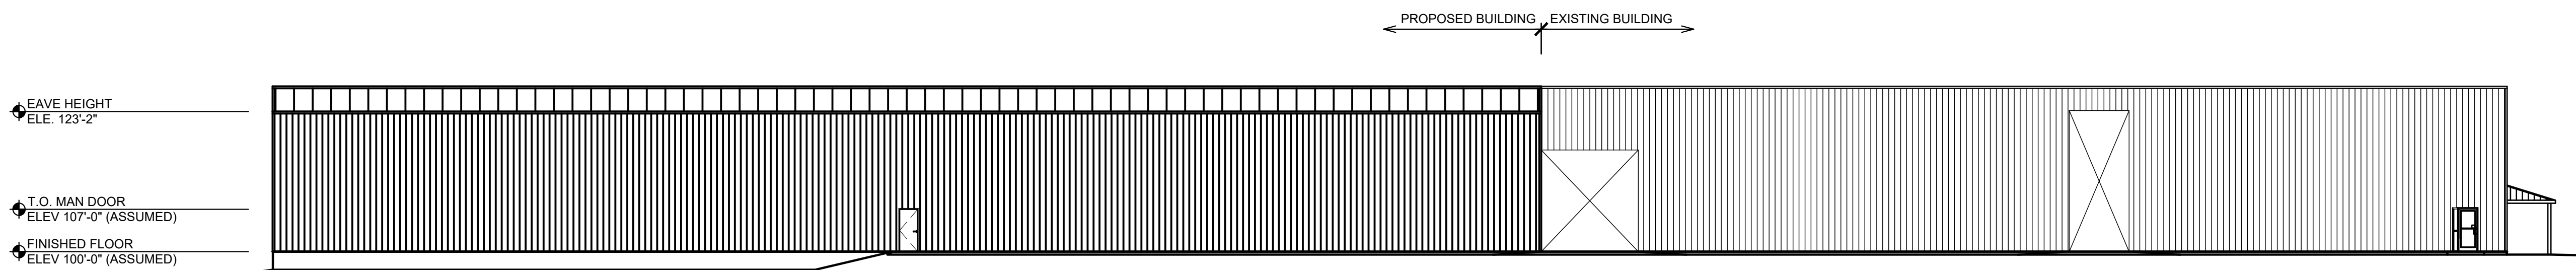

03 SIDE ELEVATION
SCALE: 1/16" = 1'-0"

NOTE: INSTALL RAILS PER
KENTUCKY BUILDING CODE

1 1/2" PIPE RAILS (TYPICAL)
1 1/2" HANDRAIL PER K.B.C.

— 1/2" SQ. PICKETS @ 4" O.C.

PROJECT NO:
20-4073

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DATE:
11-17-2020

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BUILDING ADDITION:
BLOOMFIELD FARMS
BUILDING ADDITION
575 SPENCER-MATTINGLY LANE
BARDSTOWN, KY 40004

STAIR DETAILS

A8.01

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02 STAIR SECTION

SCALE: 1-1/2" = 1'-0"

NOTE: EXTRA BLOCKING WILL BE
REQUIRED AT THE METAL SIDING WALL

- HANDRAIL EACH SIDE -
PER K.B.C.

STEEL OPEN GRATE TREADS
& LANDING

12 X 10.6

— ∠ 2 X 2 X 1/8"

- 4" PIPE COLUMNS TO FOUNDATION -
- (4) AT LANDING &
- (2) AT STAIR MIDSPAN

NOTE: LANDING BOLTED
INTO BLDG FLOOR W/ (3) 1/2"
EXPANSION BOLTS

01 STAIR SECTION

SCALE: 1-1/2" = 1'-0"

03 STAIR PLAN

SCALE: 1-1/2" = 1'-0"

1 1/2" DIA. PIPE/RAILING

BUILDING WALL
WHERE OCCURS

1-1/2" DIA. PIPE/RAILING —

5'-6*

~~DN~~~~DN~~

-7 1/2"

3'-0"

 $3\frac{1}{2}''$

PROJECT: BLOOMFIELD FARMS BUILDING ADDITION - FILE: SP1.02 Specifications.dwg - DATE: Nov 17, 2020 11:03AM - BY: DEBBY BRD

Install 4" wide Bright White stripes at all shown parking spaces.
Install 4" wide Safety Yellow stripes at Handicapped parking and loading areas.
Directional arrows where shown, to be Safety Yellow.
All Striping and marking to be straight, perpendicular and uniform.

10000 SPECIALTIES

A. Fire extinguisher and cabinets to be by owner as required by code and by the fire inspector.

12000 FURNISHINGS

A. Owner to furnish and install all furnishings not required or listed herein.

13000 SPECIAL CONSTRUCTION: PRE-ENGINEERED BUILDING PACKAGE

A. Owner to furnish any special construction not required or listed herein.

B. Building package to be generally as shown on drawings to include primary and secondary steel framing

C. Walls to be painted ribbed siding unless otherwise note on plans.

D. Canopy roofs to be painted vertical rib standing unless otherwise noted on plans.

E. Main roofs to be galvanized standing seam roof with thermal blocks (unless otherwise noted on plans) over 6" (min.) of vinyl faced insulation, with related flashing, gutters, downspouts, soffits and overhangs.

F. Full design responsibility of package to be by manufacturer. Roof loads to be 20#/s.f. plus 5#/s.f. for equipment loads, plus dead load and additional collateral loads as designed by manufacturer. Manufacturer to provide additional reinforcing required for any snow build-up, framing at canopies and for all roof top units (verify weight with mechanical contractors). Wind load of 15#/s.f. on walls and UL 90 uplift on roof. Building manufacturer to comply with all requirements of the State Building Codes. This includes all bracing and connections required to transfer loads to foundations as shown, or required. (Note: Live Load Reductions are not allowed in steel weights).

G. All roof curbs to be min. 6" high, seamless welded up curb units. Profile of curbs to match the panel profiles and colors of the roof it occurs on, have a water diverter on the top side and be stitched into the roof system. Units to be manufacturer by "Custom Curb" or approved equal.

H. Weather tightness of pre-engineered building component systems to be responsibility of building manufacturer.

14000 CONVEYING EQUIPMENT - Not Used

SPECIAL NOTE:

A. Final detailed layout of Steel Structures, Plumbing, Mechanical, Fire Suppression and Electrical systems are by separate Engineers or installers, it is the responsibility of the owner and General Contractor to coordinate all work with affected other trades to assure completeness and code compliance.

B. It is the responsibility of the General Contractor and the Mechanical, Electrical, and Plumbing Contractors to ensure that all parts of their work is to be accessible as per Federal ADAAG Guidelines and all State / Local Guidelines. This includes but is not limited to Electrical Controls such as Thermostats or Lighting Controls, Light Switches, Outlet Plugs, Hand Dryers, and Faucet Controls. If there are concerns about how to determine reach ranges, equipment clearance or other accessibility items, contact the architect immediately before work begins for guidance.

15330 AUTOMATIC SUPPRESSION SYSTEM

A. Contractor to furnish and install a complete wet pipe sprinkler system per N.F.P.A. 13 and Factory Mutual requirements. System to be design to give full coverage as required by N.F.P.A. requirements for the specific use areas of this building.

B. Bid to be complete to provide all work required. Include dedicated fire suppression line to the street, new tap and P.I.V. or vault. Riser, compressor and alarm to be located as shown. Coordinate final locations, power, communications and service with all other trades.

C. Coordinate P.I.V. and Fire Department connection, location and pipe threads with local fire department. Sprinkler lines to be installed so as not to interfere with future crane, piping systems, mechanical systems and electrical systems or fixtures.

D. Provide shop drawings for approval before ordering materials. Design, stamped drawings and obtaining agency approvals of system to be responsibility of sprinkler subcontractor.

E. Extension of existing fire suppression system per N.F.P.A. 13. (Minimum Requirements). Coordinate with owner, field verify existing system for extension before beginning construction.

END OF SPECIFICATIONS

ABBREVIATIONS

These are abbreviations used on the plans and in these specifications. Not all items may be use and are for reference only.

- ACT - Acoustical Ceiling Tile
- AFF - Above Finished Floor
- CJ - Control Joint
- E.I.F.S. - Exterior Insulation and Finish System
- FRP - Fiberglass Reinforced Panels
- Gyp. Bd. - Gypsum Board
- I.B.C. - International Building Code
- MAX - Maximum
- MIN - Minimum
- NRP - Non-Removable Pin
- O.C. - On Center
- VCT - Vinyl Composite Tile
- VET - Vinyl Enhanced Tile
- V.I.F. - Verify In Field

PROJECT NO:

20-4073

DRAWN BY:

NM/DB/

DATE:

11-17-2020



KEYES ARCHITECTS & ASSOCIATES
4717 PRESTON HIGHWAY
LOUISVILLE, KENTUCKY 40213 (502) 636-5113

BUILDING ADDITION:

**BLOOMFIELD FARMS
BUILDING ADDITION**

575 SPENCER-MATTINGLY LANE
BARDSTOWN, KY 40004

SPECIFICATIONS

SP1.02