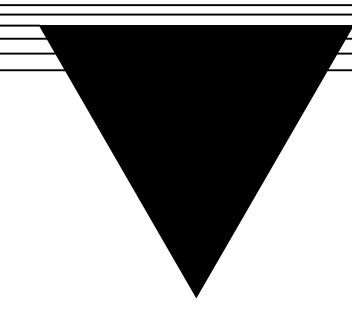
FIVESTAR STORE #9000

NEWCOMB OIL CO., LLC

1830 COMMERCE DIVE SCOTTSVILLE, KY 42164



ARCHITECT:

KEYES ARCHITECTS AND ASSOCIATES

4717 PRESTON HIGHWAY

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ARCHITECT: CHARLES J. KEYES III

GENERAL CONTRACTOR:

BCD, INC.
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BARDSTOWN, KENTUCKY 40004
PH: (502) 348-2305
WEB: www.bcdinc.com
EMAIL: BCD@BARDSTOWN.COM

MEP ENGINEERS

CMTA Engineering Consultants
10411 MEETING STREET
PROSPECT, KENTUCKY 40059
PH: (502)-326-3085
WEB: cmta.com
EMAIL: TDOWNS@CMTA.COM

<u>OWNER</u>

NEWCOMB OIL COMPANY, LLC. 951 WITHROW CT. BARDSTOWN, KENTUCKY 40004 PH: (502)-348-3961



	PROJECT IN	FORMATION
Totalitie	APPLICABLE BUILDING CODES BUILDING CODE ACCESSIBILITY CODE ENERGY CODE	IBC 2015 / KBC 2018 ADA 2010 / ANSI 2009 IECC 2012
	USE AND OCCUPANCY:	M - MERCANTILE
	CONSTRUCTION TYPE:	V-B
	BUILDING INFORMATION	
	BUILDING:	5,000 s.f.
	TOTAL BUILDING SIZE:	5,000 s.f.
	FIRE SUPPRESSION: NONE	
	I	

OCCUP	ANCY ALLC)WAN	CE
FUNCTION OF SPACE	ALLOWANCE	AREA	OCCUPANCY
MERCANTILE	60 GROSS	5,000	83
ТС	83		

RE\	/ISIOI	NS:	NOTE SYMBOL

	Foundation Plans & Details
F1.01	Foundation Plan
F2.01	Foundation Details
	Structural
S1.01	General Notes
S1.02	Structural Details

Sheet List Table

Sheet Number

S1.03	Structural Details
S1.04	Low Roof Plan
S1.05	Structural Misc. Details
S1.06	Structural Sections & Details
S1.07	Structural Sections & Details
S3.01	Structural Sections & Details
	Floor Plans
A1.01	Floor Plan
A1.02	Dimension Floor Plan
A1.03	Equipment & Casework Plan
A1.04	Finish Plan
A1.05	Reflected Ceiling Plan
A1.06	Roof Plan
	Exterior Elevations
A2.01	Exterior Elevations
A2.02	Exterior Elevations
A2.03	Interior Elevations
A2.04	Interior Elevations
A2.05	Interior Elevations
A2.06	Interior Elevations
	Schedules and Standards
A3.03	Schedules
A3 04	Schadulas

Details & Sections

Building Sections
Building Sections
Wall Sections & Details
Wall Sections & Details

Wall Sections & Details
Wall Sections & Details

Wall Sections & Details
Wall Sections & Details

Mechanical Legends & Schedules

Mecahanical Section Views & Detai

Plumbing Legend & Details

Floor Plan - Sanitary Waste & Vent

Floor Plan - Water & Gas

Electrical Legend & Details

Electrical Lighting
Electrical Power & Systems

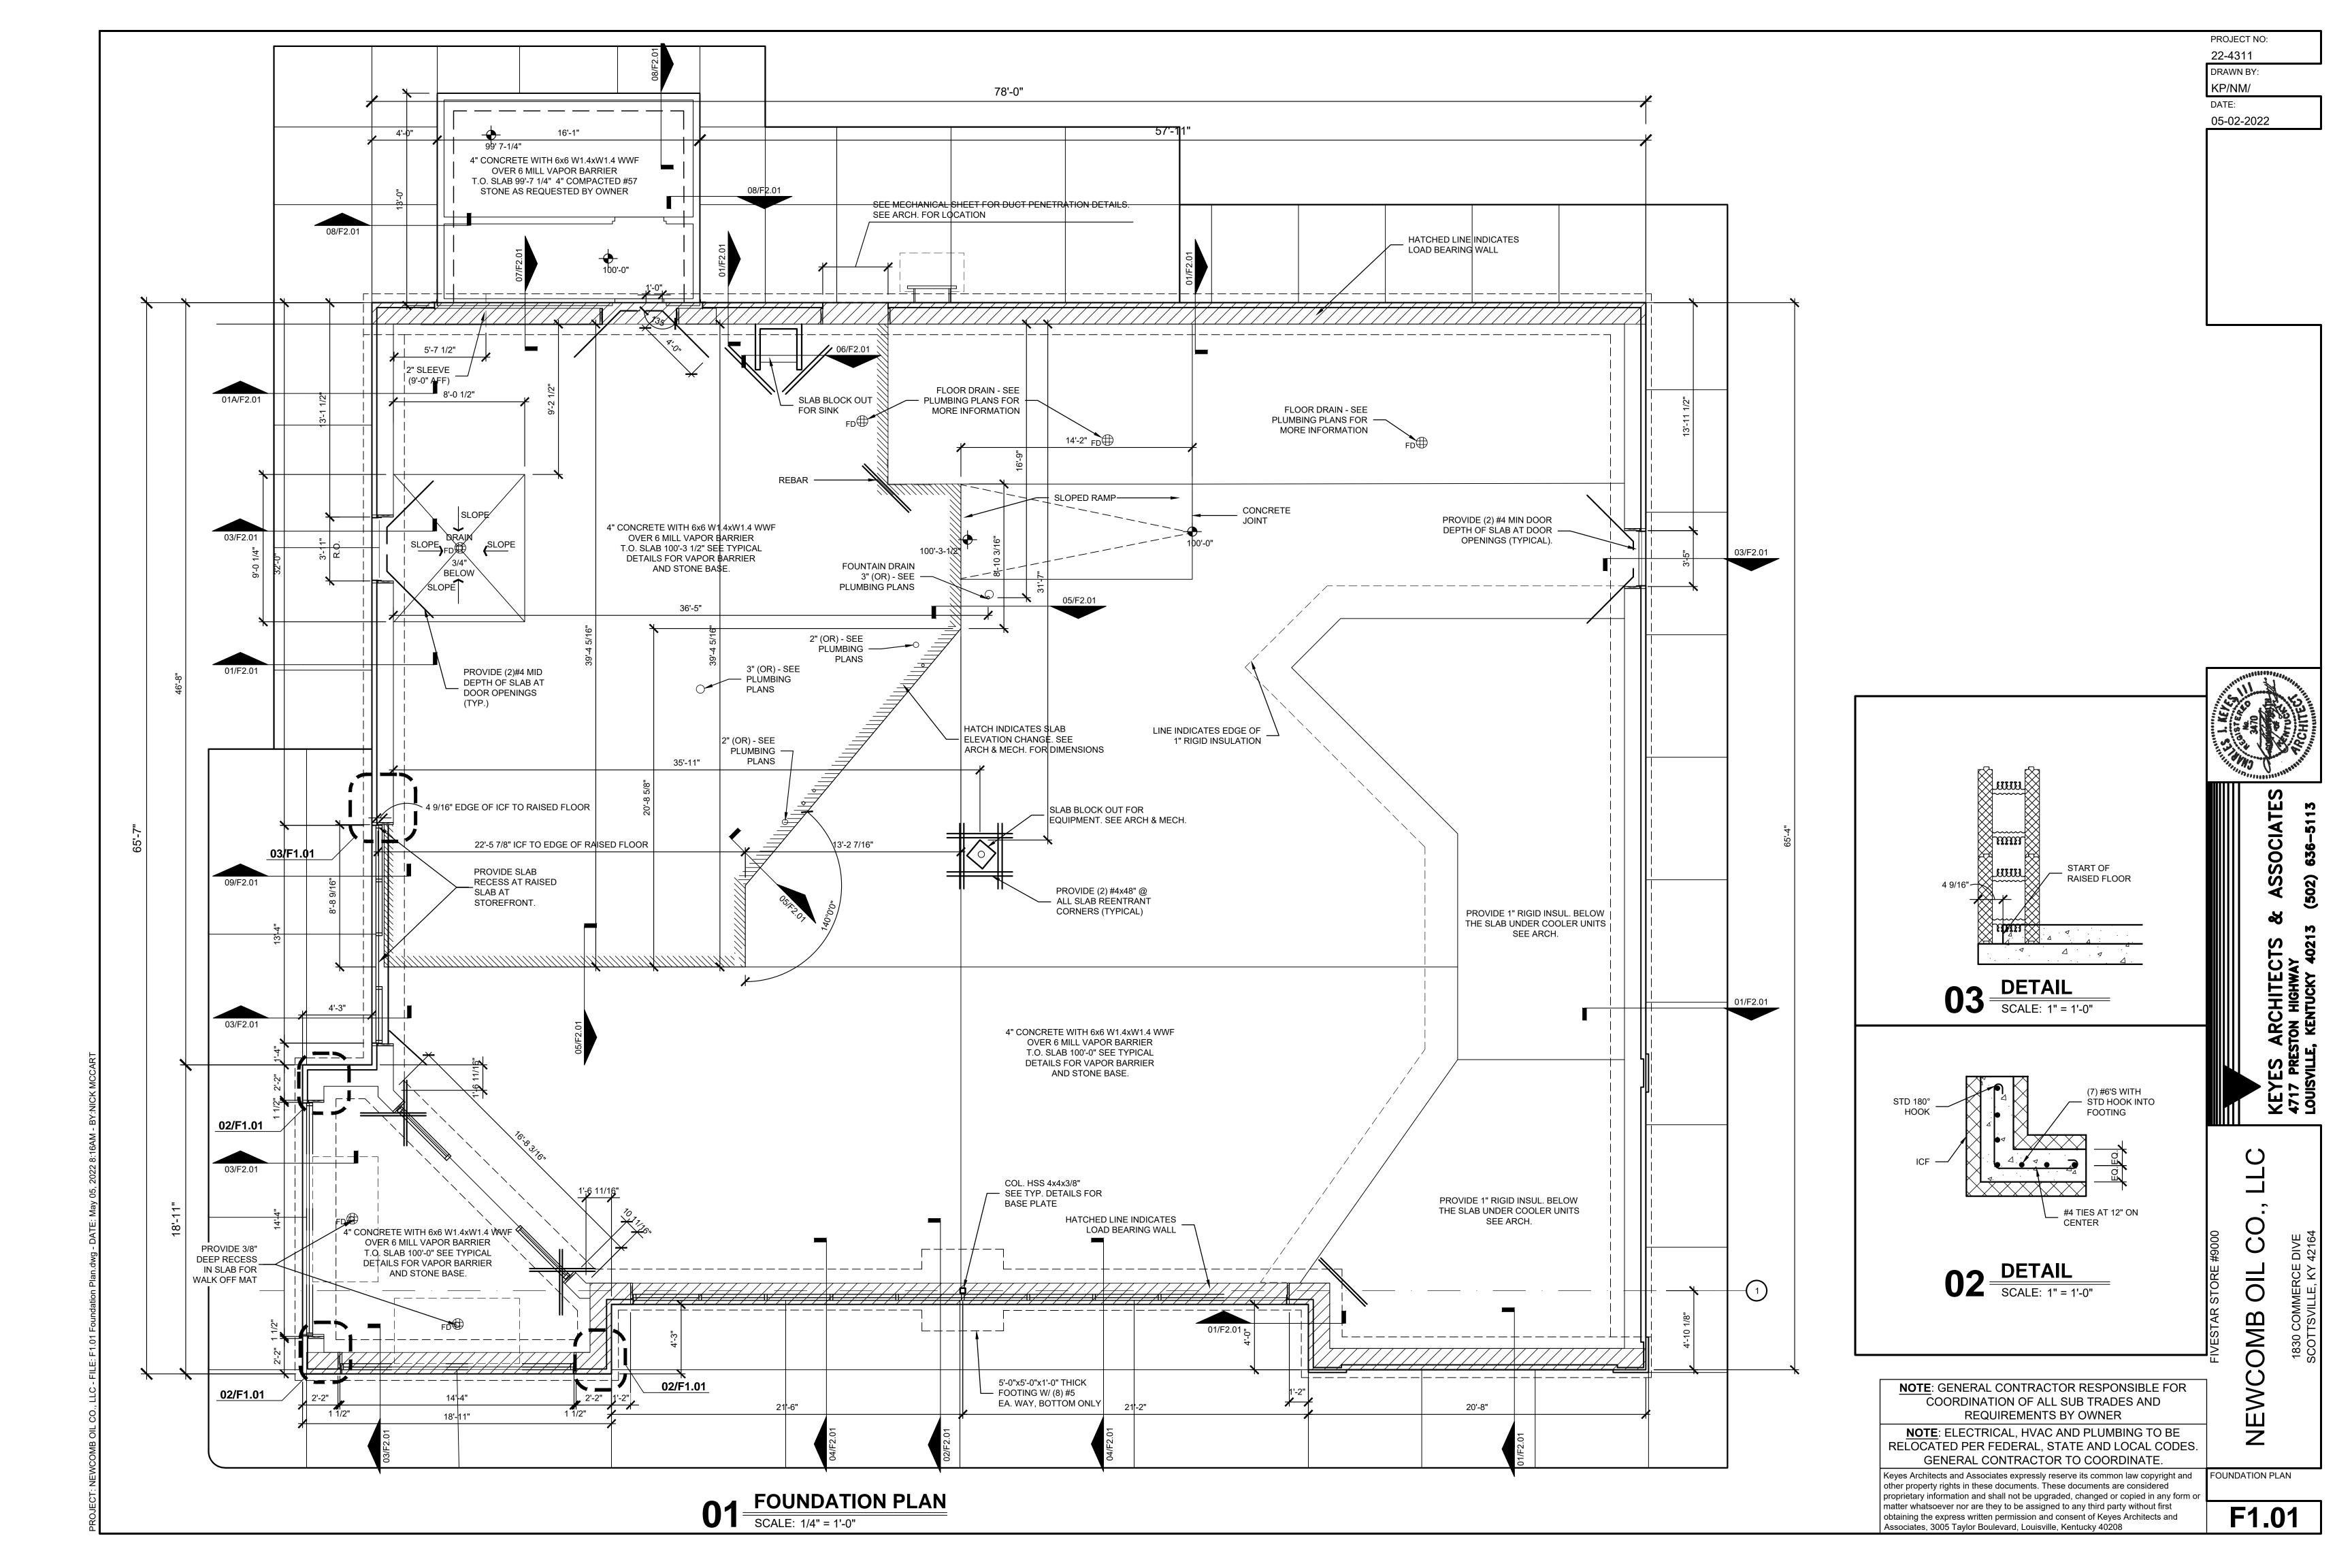
Electrical Riser Diagram

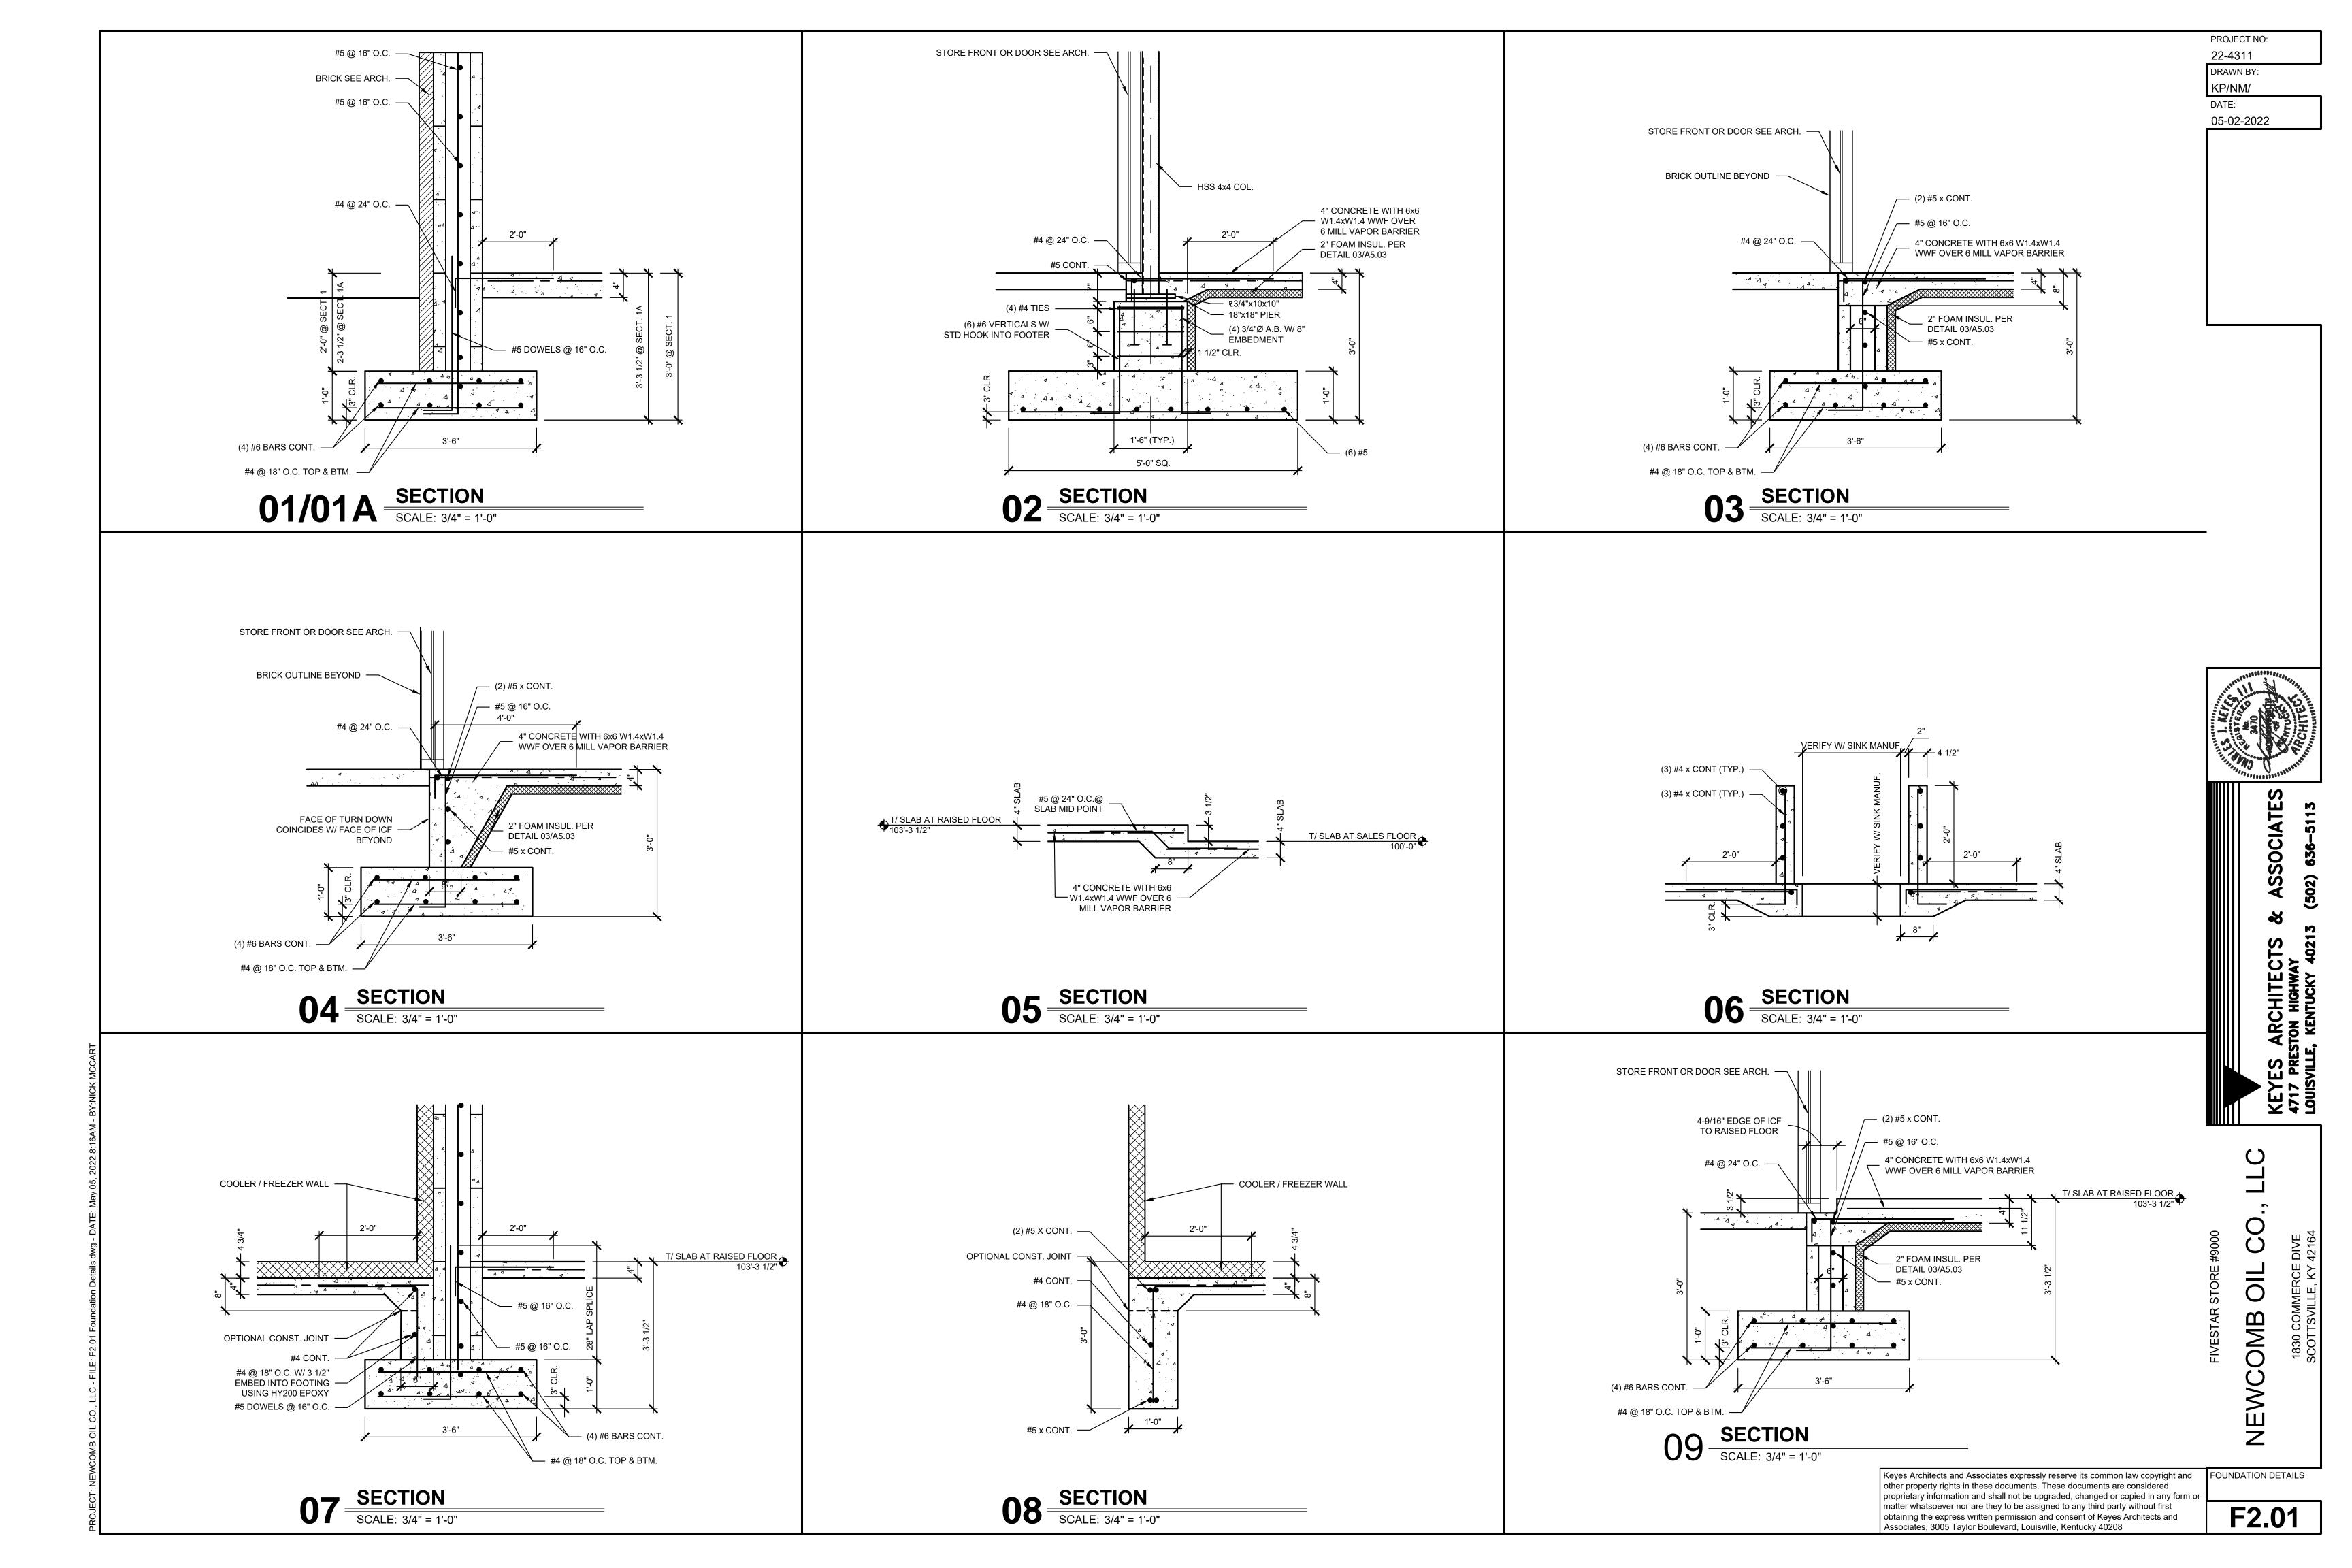
Electrical Schedules

Electrical

P2.02

E2.00





1.0 0.75 0.375

3. AIR ENTRAPMENT 5% ± 1% FOR EXTERIOR CONCRETE EXPOSED TO FREEZING.

6. CLEAR COVER FOR STEEL REINFORCEMENT

6.1. IN EXTERIOR FACE OF CONCRETE = 3"

6.2. IN INTERIOR FACE OF CONCRETE = 1.5"

4. SLUMP AT POINT OF DISCHARGE: 4" ±1" (7" MAX SLUMP WITH WATER REDUCING ADMIXTURE).

5. DO NOT ADD WATER O CONCRETE DURING DELIVERY. WATER MAY BE ADDED ON SITE ONLY IF A TICKET WITH THE WATER UNDER RUN NOTED

SPECIFICATIONS AFTER THE WATER IS ADDED. CONCRETE ADMIXTURES OF ANY KIND SHALL NOT BE ADDED ON SITE OOR DURING DELIVERY.

IS PROVIDED. WATER ADDED MUST NOT EXCEED THE AMOUNT OF WATER NOTED ON THE TICKET. CONCRETE MUST STILL MEET

CONCRETE PLACEMENT:

1. BEFORE PLACING CONCRETE, INSPECT AND COMPLETE FORMWORK INSTALLATION. VERIFY REINFORCING STEEL PLACEMENT, SIZES, SPLICES

2. COMPLY WITH ACI 304R "RECOMMENDED PRACTICE FOR MEASURING, MIXING, TRANSPORTING AND PLACING CONCRETE".

3. DEPOSIT AND CONSOLIDATE CONCRETE IN FORMS IN HORIZONTAL LAYERS NOT DEEPER THAN 18" AND IN A MANNER TO PREVENT INCLINED CONSTR4UCTION JOINTS.

4. DEPOSIT AND CONSOLIDATE SLABS IN A CONTINUOUS OPERATION WITHIN LIMITS OF CONSTRUCTION JOINTS UNTIL PLACEMENT OF PANEL OR SECTION IS COMPLETED.

5. PROTECT CONCRETE FROM PHYSICAL DAMAGE OR REDUCED STRENGTH WHICH COULD BE CAUSED BY FROST, FREEZING ACTIONS OR LOW TEMPERATURES IN COMPLIANCE ACI 306R.

6. WHEN HOT WEATHER CONDITIONS EXIST THAT WOULD IMPAIR QUALITY AND STRENGTH OF CONCRETE, PLACE CONCRETE IN COMPLIANCE WITH ACI 305R. CONCRETE AT TIME OF PLACEMENT SHALL BE LESS THAN90 DEF "F" AND SHALL BE MAINTAINED SO THAT THE TEMPERATURE

7. CONSOLIDATE CONCRETE BY MECHANICAL VIBRATING EQUIPMENT SUPPLEMENTED BY HAND-SPADING OR RODDING OR TAMPING. DO NOT USE VIBRATORS INSIDE FORMS. DO NOT INSERT VIBRATORS INTO LOWER LAYERS OF CONCRETE THAT HAVE BEGUN TO SET.

FINISH OF HORIZONTAL CONCRETE SURFACES:

DOES NOT EXCEED 90 DEF "F".

1. EXTERIOR SLABS UNDER CANOPY SHALL RECEIVE A FINE BROOM FINISH. APPLY A TROWEL FINISH, STOPPING AFTER A SECOND TROWELING, AND WHEN CONCRETE IS STILL PLASTIC, SLIGHTLY SCARIFY SURFACEWITH FINE BROOM.

2. INTERIOR SLABS SHALL RECEIVE A TROWEL FINISH, APPLY HARD TROWEL FINISH TO SLAB ON GRADE.

3. WATER SHALL NOT BE APPLIED TO HORIZONTAL SURFACES TO RETEMPER PRIOR TO FINISHING.

4. DRY CEMENT SHALL NOT BE ADDED TO HORIZONTAL SURFACES TO STIFFEN SURFACE PRIOR TO FINISH.

5. CONTROL JOINTS FOR SIDEWALKS HAL BE PROVIDED BY SAW CUTTING TO A MINIMUM DEPTH OF 1/4" x SLAB THICKNESS. ELIMINATE TOOL MARKS ON CONCRETE SURFACES.

CONCRETE CURING AND PROTECTION:

1. PROTECT CONCRETE FROM PREMATURE DRYING AND EXCESSIVE COLD OR HOT TEMPERATURES.

2. START INITIAL CURING IMMEDIATELY AFTER FINAL FINISHING IS COMPLETE. CURE CONCRETE WITH KURE N HARDEN BY SONNERBORNE.

1. THE OWNER MAY RETAIN A TESTING LABORATORY TO PERFORM TESTS AND TO SUBMIT TEST REPORTS. THE CONTRACTOR SHALL ALLOW

TESTING AGENCY ACCESS TO ALL MATERIALS AND SHALL ASSIST IN OBTAINING SAMPLES.

2. TESTING AGENCY HAS THE AUTHORITY TO REJECT A LOAD OF CONCRETE THAT DOES NOT MEET SPECIFICATIONS. REJECTED CONCRETE SHALL BE REPLACED AT NO COST TO THE OWNER.

STRUCTURAL STEEL:

1. STRUCTURAL STEEL HAS BEEN DESIGNED AND SHALL BE FABRICATED AND ERECTED IN ACCORDANCE WITH THE AISC SPECIFICATION FOR THE STRUCTURAL STEEL BUILDINGS 15TH ADDITION.

2. ALL MATERIALS SHALL CONFORM TO THE FOLLOWING SPECIFICATIONS: LATEST EDITIONS OF THE 2018 KENTUCKY BUILDING CODE SHALL BE

STRUCTURAL WIDE FLANGE SHAPES

QUALITY CONTROL TESTING OF CONCRETE DURING CONSTRUCTION:

INCLUDING COLUMNS, BEAMS, ETC. ASTM A992 STRUCTURAL ANGLES, CHANNELS PLATE & MISC. ITEMS ASTM A36 ANCHOR BOLTS A36 OR A307 STRUCTURAL TUBING & PIPE ASTM A500, GRADE "B"

WELDING ELECTRODES E70XX

SHALL BE NOT LESS THAN 1.5 MILS. DRY FILM THICKNESS.

3. ALL BOLTED CONNECTIONS SHALL BE DESIGNED BY THE FABRICATOR IN ACCORDANCE WITH THE "SPECIFICATION FOR STRUCTURAL JOINTS USING ASTM A325 BOLTS" USING 3/4" INCH DIAMETER BOLTS. WASHERS SHALL BE LOAD INDICATOR TYPE OR BOLTS SHALL BE TENSION CONTROL TYPE.

4. ALL WELDING SHALL BE IN ACCORDANCE WITH "THE STRUCTURAL WELDING CODE" AWS D1.1.

5. ALL CONNECTIONS SHALL BE DESIGNED FOR 1/2" OF THE MAXIMUM UNIFORM LOAD FOR THE SIZE, SPAN, AND GRADE OF STEEL LISTED IN TABLE 3-6 "MAXIMUM TOTAL UNIFORM LOAD" FROM THE3 AISC MANUAL (15TH EDITION) UNLESS OTHERWISE NOTED.

6. ALL CONDITIONS AND DIMENSIONS PRIOR TO FABRICATION AND ERECTION OF STEEL SHALL BE VERIFIED. ANY AMBIGUITY FOUND SHALL BE IMMEDIATELY BROUGHT TO THE NOTICE OF NEWCOMB OIL COMPANY.

7. GROUT SHALL BE PRE-MIXED, NON-METTALIC, NON-CORROSIVE, NON-STAINING PRODUCT CONTAINING SELECTED SILICA SANDS, PORTLAND, CEMENT, SHRINKAGE COMPENSATING AGENTS, PLASTICIZING AND WATER REDUCING AGENTS, COMPLY WITH CE-CRD-C621.

8. BEFORE SHIPPING FROM THE STEEL SHOP ALL STEEL SHALL BE CLEANED. REMOVE HEAVY RUST AND MILL SCALE, SPATTER, SLAG OR FLUX DEPOSITS. COMPLY WITH STEEL FABRICATORS SP-3 "POWER TOOL CLEANING". REMOVE OIL, GREASE AND SIMILAR CONTAMINATES; COMPL

WITH SSPC SP-1 "SOLVENT CLEANING" 9. IMMEDIATELY AFTER CLEANING APPLY MANUFACTURERS OR FABRICATOR'S STANDARD, FAST CURING, LEAD FREE, UNIVERSAL MODIFIED ALKYD PRIMER SELECTED FOR GOOD RESISTANCE TO NORMAL ATMOSPHERIC CORROSION, FOR COMPATIBILITY WITH ALKYD FINISH PAINT SYSTEMS, AND FOR THE CAPABILITY OF PROVIDING A SOUND FOUNDATION FOR FIELD APPLIED TOPCOATS DESPITE PROLONGED EXPOSURE. APPLICATION

STEEL JOISTS:

1. ALL STEEL JOISTS, JOIST GIRDERS, REQUIRED ACCESSORIES SHALL BE DESIGNED, DETAILED AND FABRICATED IN ACCORDANCE WITH THE "STANDARD SPECIFICATIONS FOR OPEN WEB STEEL JOISTS. ACCORDING TO THE STEEL JOIST INSTITUTE". CURRENT EDITIONS SHALL APPLY.

2. PROVIDE JOISTS FABRICATED IN COMPLIANCE WITH THE STEEL JOIST INSTITUTE (SJI) STANDARD SPECIFICATIONS, LOAD TABLES AND WEIGHT TABLES FOR: OPEN WEB STEEL JOISTS (K-SERIES) AND LONGSPAN STEEL JOISTS (LH SERIES).

3. EXTENT OF WORK IS INDICATED ON THE PLANS INCLUDING BASIC LAYOUT AND TYPE OF JOISTS REQUIRED. UNLESS OTHERWISE INDICATED, THE FOLLOWING ITEMS ARE INCLUDED: STEEL JOISTS, JOIST EXTENDED ENDS, CEILING EXTRUSIONS, EXTENDED BOTTOM CHORES USED AS STRUTS, BRIDGING AND BRIDGING ANCHOR, JOIST BOTTOM CHORD BRACING, JOIST WALL AND BEAM ANCHORS, HEADERS, LOOSE BEARING PLATES

AND ANCHOR BOLTS FOR PLACEMENT.; 4. JOISTS SHALL BE DESIGNED BY JOIST MANUFACTURER TO INSURE THAT CHORD MEMBERS ARE SUFFICIENT TO WITHSTAND FORCES INDICATED ON THE DRAWINGS. ALL JOISTS SHALL BE REVIEWED AND SEALED BY A LICENSED ENGINEER REGISTERED IN THE STATE OF TENNESSEE. JOISTS MANUFACTURER SHALL DESIGN CONNECTIONS ON SHOP DRAWINGS. CONNECTION DESIGN SHALL BE COORDINATED WITH THE STRUCTURAL

5. DESIGN AND FABRICATE STEEL JOISTS IN ACCORDANCE WITH SJI SPECIFICATIONS, INCLUDING HEADERS AND OTHER SUPPORT FRAMING. VERIFY DRAWING DIMENSIONS AND FIELD CONDITIONS PRIOR TO FABRICATION.

6. PROVIDE HORIZONTAL OR DIAGONAL TYPE BRIDGING FOR JOISTS, COMPLYING WITH SJI "SPECIFICATIONS". PROVIDE BRIDGING ANCHORS FOR

ENDS OF BRIDGING LINES TERMINATING AT WALLS OR BEAMS.

7. PROVIDE END ANCHORAGES TO SECURE JOISTS TO ADJACENT CONSTRUCTION, COMPLYING WITH SJI "SPECIFICATIONS", UNLESS OTHERWISE

INDICATED.

STEEL FABRICATOR. ALL WELDS OR BOLTS REQUIRED SHALL BE CLEARLY INDICATED.

8. CAMBER JOISTS TOM ALLOW FOR DEAD-LOAD DEFLECTION AS PROVIDED IN THE SJI "STANDARD SPECIFICATIONS".

9. REMOVE LOOSE SCALE, HEAVY RUST, AND OTHER FOREIGN MATERIALS FROM THE FABRICATED JOISTS AND ACCESSORIES BEFORE APPLICATION OF SHOP PAINT. APPLY ONE COAT SHOP COAT OF PRIMER TO STEEL JOISTS AND ACCESSORIES, BY SPRAY. OR OTHER METHOD WHICH COMPLIES WITH STEEL STRUCTURES PAINTING COUNCIL SPECIFICATION, SSPC NO. 15.

STEEL DECKING:

1. COMPLY WITH PROVISIONS OF THE FOLLOWING CODES AND STANDARDS, EXCEPT AS OTHERWISE INDICATED OR SPECIFIED:

A. ANSI "SPECIFICATION FOR THE DESIGN OF COLD-FORMED STEEL STRUCTURAL MEMBERS".

B. AWS "STEEL WELDING CODE".

C. SDI "DESIGN MANUAL FOR FLOOR AND ROOF DECKS"

2. PROTECT DECKING FROM CORROSION (WHITE RUST), DEFORMATION AND OTHER DAMAGE DURING DELIVERY, STORAGE AND HANDLING. STORE DECKING ON WOOD SLEEPERS WITH SLOPE FOR POSITIVE DRAINAGE. DECKING SHALL BE FREE OF CORROSION (WHITE RUST) PRIOR TO

3. BASIC STEEL SHALL BE FLAT ROLLED, GALVANIZED SHEETS OF STRUCTURAL QUALITY, MEETING THE REQUIREMENTS OF ASTM A653. GALVANIZING SHALL MEET ASTM A924, G90 COATING. STEEL BLOCK SUPPLIER TO PROVIDE GALVANIZED DECK WHICH IS SHOP AND FIELD

4. ROOF DECKING SHALL BE A MINIMUM OF 20 GAUGE METAL DECK, TYPE "B" WIDE RIB, WITH A FABRICATED DEPTH OF 1-1/2" INCHES. FORM DECK UNITS IN LENGTHS TO SPAN 3 OR MORE SUPPORTS, WITH FLUSH, TELESCOPED OR NESTED 2" LAPS AT ENDS AND SIDE LAPS, UNLESS

5. FABRICATE METAL DECKING IN ACCORDANCE WITH SDI DESIGN MANUAL TO ACCOMMODATE MAXIMUM WORKING STRESS OF 0.6FY AND MAXIMUM SPAN DEFLECTION OF L/240. FOR ROOF DECKING, MAXIMUM FIBER STRESS SHALL NOT EXCEED 20,000 PSI UNDER A TOTAL DEAD AND LIVE LOAD OF 50PSF AND DEFLECTION SHALL NOT EXCEED L/360 OF THE SPAN UNDER A LIVE LOAD OF 25 PSF. FOR FLOORING DECKING, MAXIMUM FIBER STRESS SHALL NOT EXCEED 0.6FY UNDER A TOTAL DEAD AND LIVE LOAD OF 150 PSF AND DEFLECTION SHALL NOT EXCEED L/360 OF THE SPAN UNDER LIVE LOAD OF 100 PSF.

6. ERECT AND ATTACH METAL DECKING IN ACCORDANCE WITH SDI DESIGN MANUAL FOR FLOOR AND ROOF DECK, AS WELL AS WITH MANUFACTURER'S RECOMMENDATIONS AND FINAL SHOP DRAWINGS. PROVIDE WELDING IN ACCORDANCE WITH SDI SPECIFICATIONS AND

7. STEEL ROOF DECK UNITS SHALL BE ANCHORED TO SUPPORTING STRUCTURAL STEEL MEMBERS TO PROVIDE LATERAL STABILITY TO THE TOP FLANGE OF THE SUPPORTING STRUCTURAL MEMBERS AND TO RESIST UPLIFT WIND FORCES INDICATED ON THE PLANS. THE DEAD LOAD OF THE ROOF DECK CONSTRUCTION PLUS THE DEAD LOAD OF THE ROOFING MATERIAL PLUS RIGID INSULATION MAY BE DEDUCTED FROM THE SPECIFIED UPLIFT FORCES.

8. INSTALL 6" INCH WIDE 18ga SHEET STEEL COVER PLATES WHERE DECK CHANGES DIRECTION. SCREW IN PLACE 12" INCHES ON CENTER

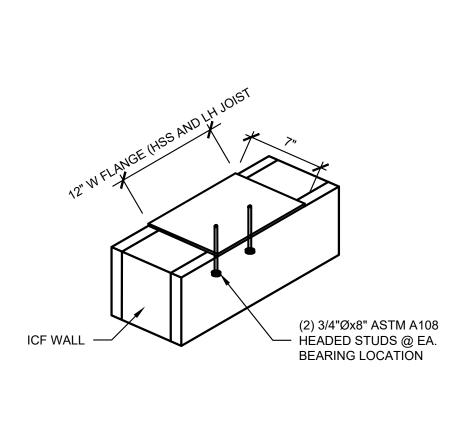
9. AFTER DECKING INSTALLATION, WIRE BRUSH, CLEAN AND PAINT SCARRED AREAS, WELDS AND RUST SPOTS ON TOP AND BOTTOM SURFACES OF DECKING UNITS AND SUPPORTING STEEL MEMBERS. TOUCH UP GALVANIZED SURFACES WITH GALVANIZING REPAIR PAINT APPLIED IN ACCORDANCE WITH MANUFACTURER'S INSTRUCTIONS.

PROJECT NO:

22-4311 DRAWN BY: KP/NM/

05-02-2022

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TYP. WIDE FLANGE, HSS, AND JOIST BEARING PLT. DET.

#5 DOWELS @ 12" O.C. PROVIDE (2) #5 ON BOTH SIDES OF OPENING (TYP.) W/ 180° HOOK @ BOTT. JAMB DOWELS SHALL BE CONT. TO FOOTING (2) #6 LINTEL REINF. w/ STD HOOK (TYP.) (1) #6 LINTEL REINF. w/ STD HOOK (TYP.)

TYP. REINFORCEMENT @ HVAC OPENING IN ICF

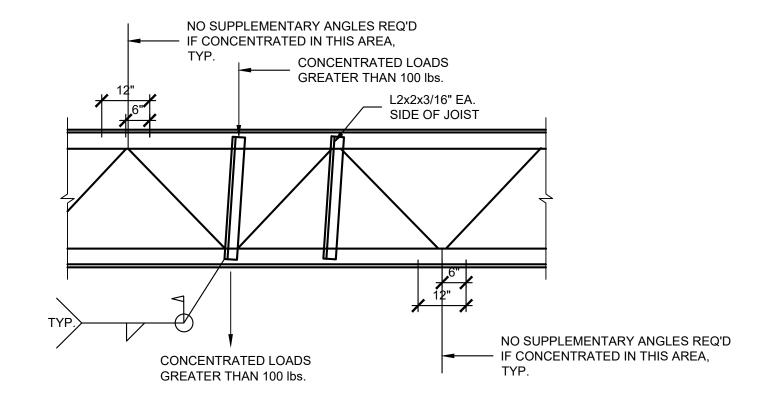
PROVIDE (2) #5 ON #5 DOWELS @ 12" O.C. W/ 180° HOOK @ BOTT. BOTH SIDES OF OPENING (TYP.) PROVIDE #5 IN TWO ADJACENT CELLS ON BOTH SIDES OF DOOR OPENING (TYP.) (2) #6 LINTEL REINF. w/ STD HOOK (TYP.) #4 - 24" #5 - 30" JAMB DOWELS SHALL BE #6 - 36" ----CONT. TO FOOTING MIN. DEVELOPMENT LENGTH - TYP.

TYP. AROUND DOOR/STOREFRONT OPENING IN ICF

(1) LAYER OF 6 MIL.VAPOR BARRIER (AS REQ'STD BY THE OWNER).

TYP. SLAB ON GRADE, SUB-GRADE, VAPOR BARRIER AND CONTROL JOINT

SCALE: 3" = 1'-0"



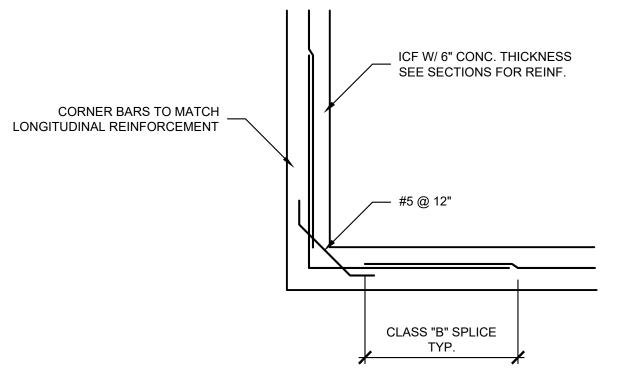
TYP. JOIST REINFORCEMENT

SCALE: 3" = 1'-0"

SCALE: 3" = 1'-0"

OPENING WIDTH ANGLE SIZE LESS THAN 6'-0" L4x3x1/4"	SCHE	DULE
LESS THAN 6'-0" L4x3x1/4"	OPENING WIDTH	ANGLE SIZE
	LESS THAN 6'-0"	L4x3x1/4"
6'-0" TO 8'-0" L6x4x3/8"	6'-0" TO 8'-0"	L6x4x3/8"

BRICK LINTEL



06 TYP. WALL CORNER REINFORCEMENT DETAIL

SCALE: 3" = 1'-0"

A36 OR A325 SEE PLAN FOR ORIENTATION FOR A325 ANCHOR BOLTS EMBED BOLT HEAD **NUT & WASHER WELDED**

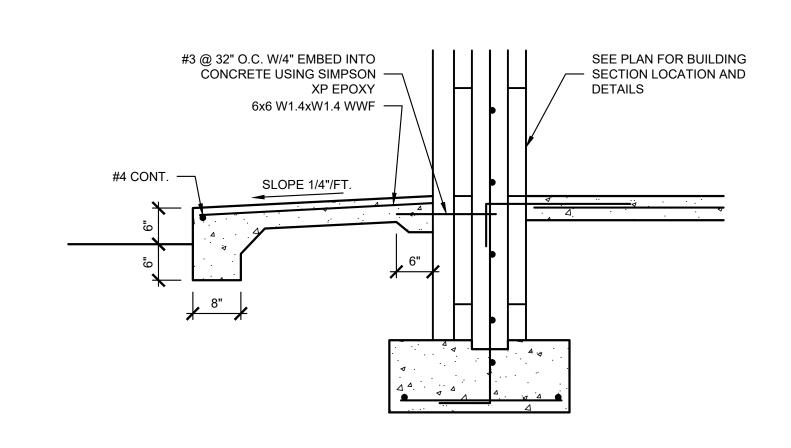
TYP. STEEL COLUMN BASE DETAIL

SCALE: 3" = 1'-0"

3/4"Ø A36 ANCHOR BOLT W/ 9" EMBED INTO PIER W/ HEAVY HEX NUT WELDED TO EMBEDDED END — HSS 4x4 COLUMN

TYP. HSS 4x4 BASE PLATE DETAIL

SCALE: 3" = 1'-0"



O9 TYP. SIDEWALK DETAIL

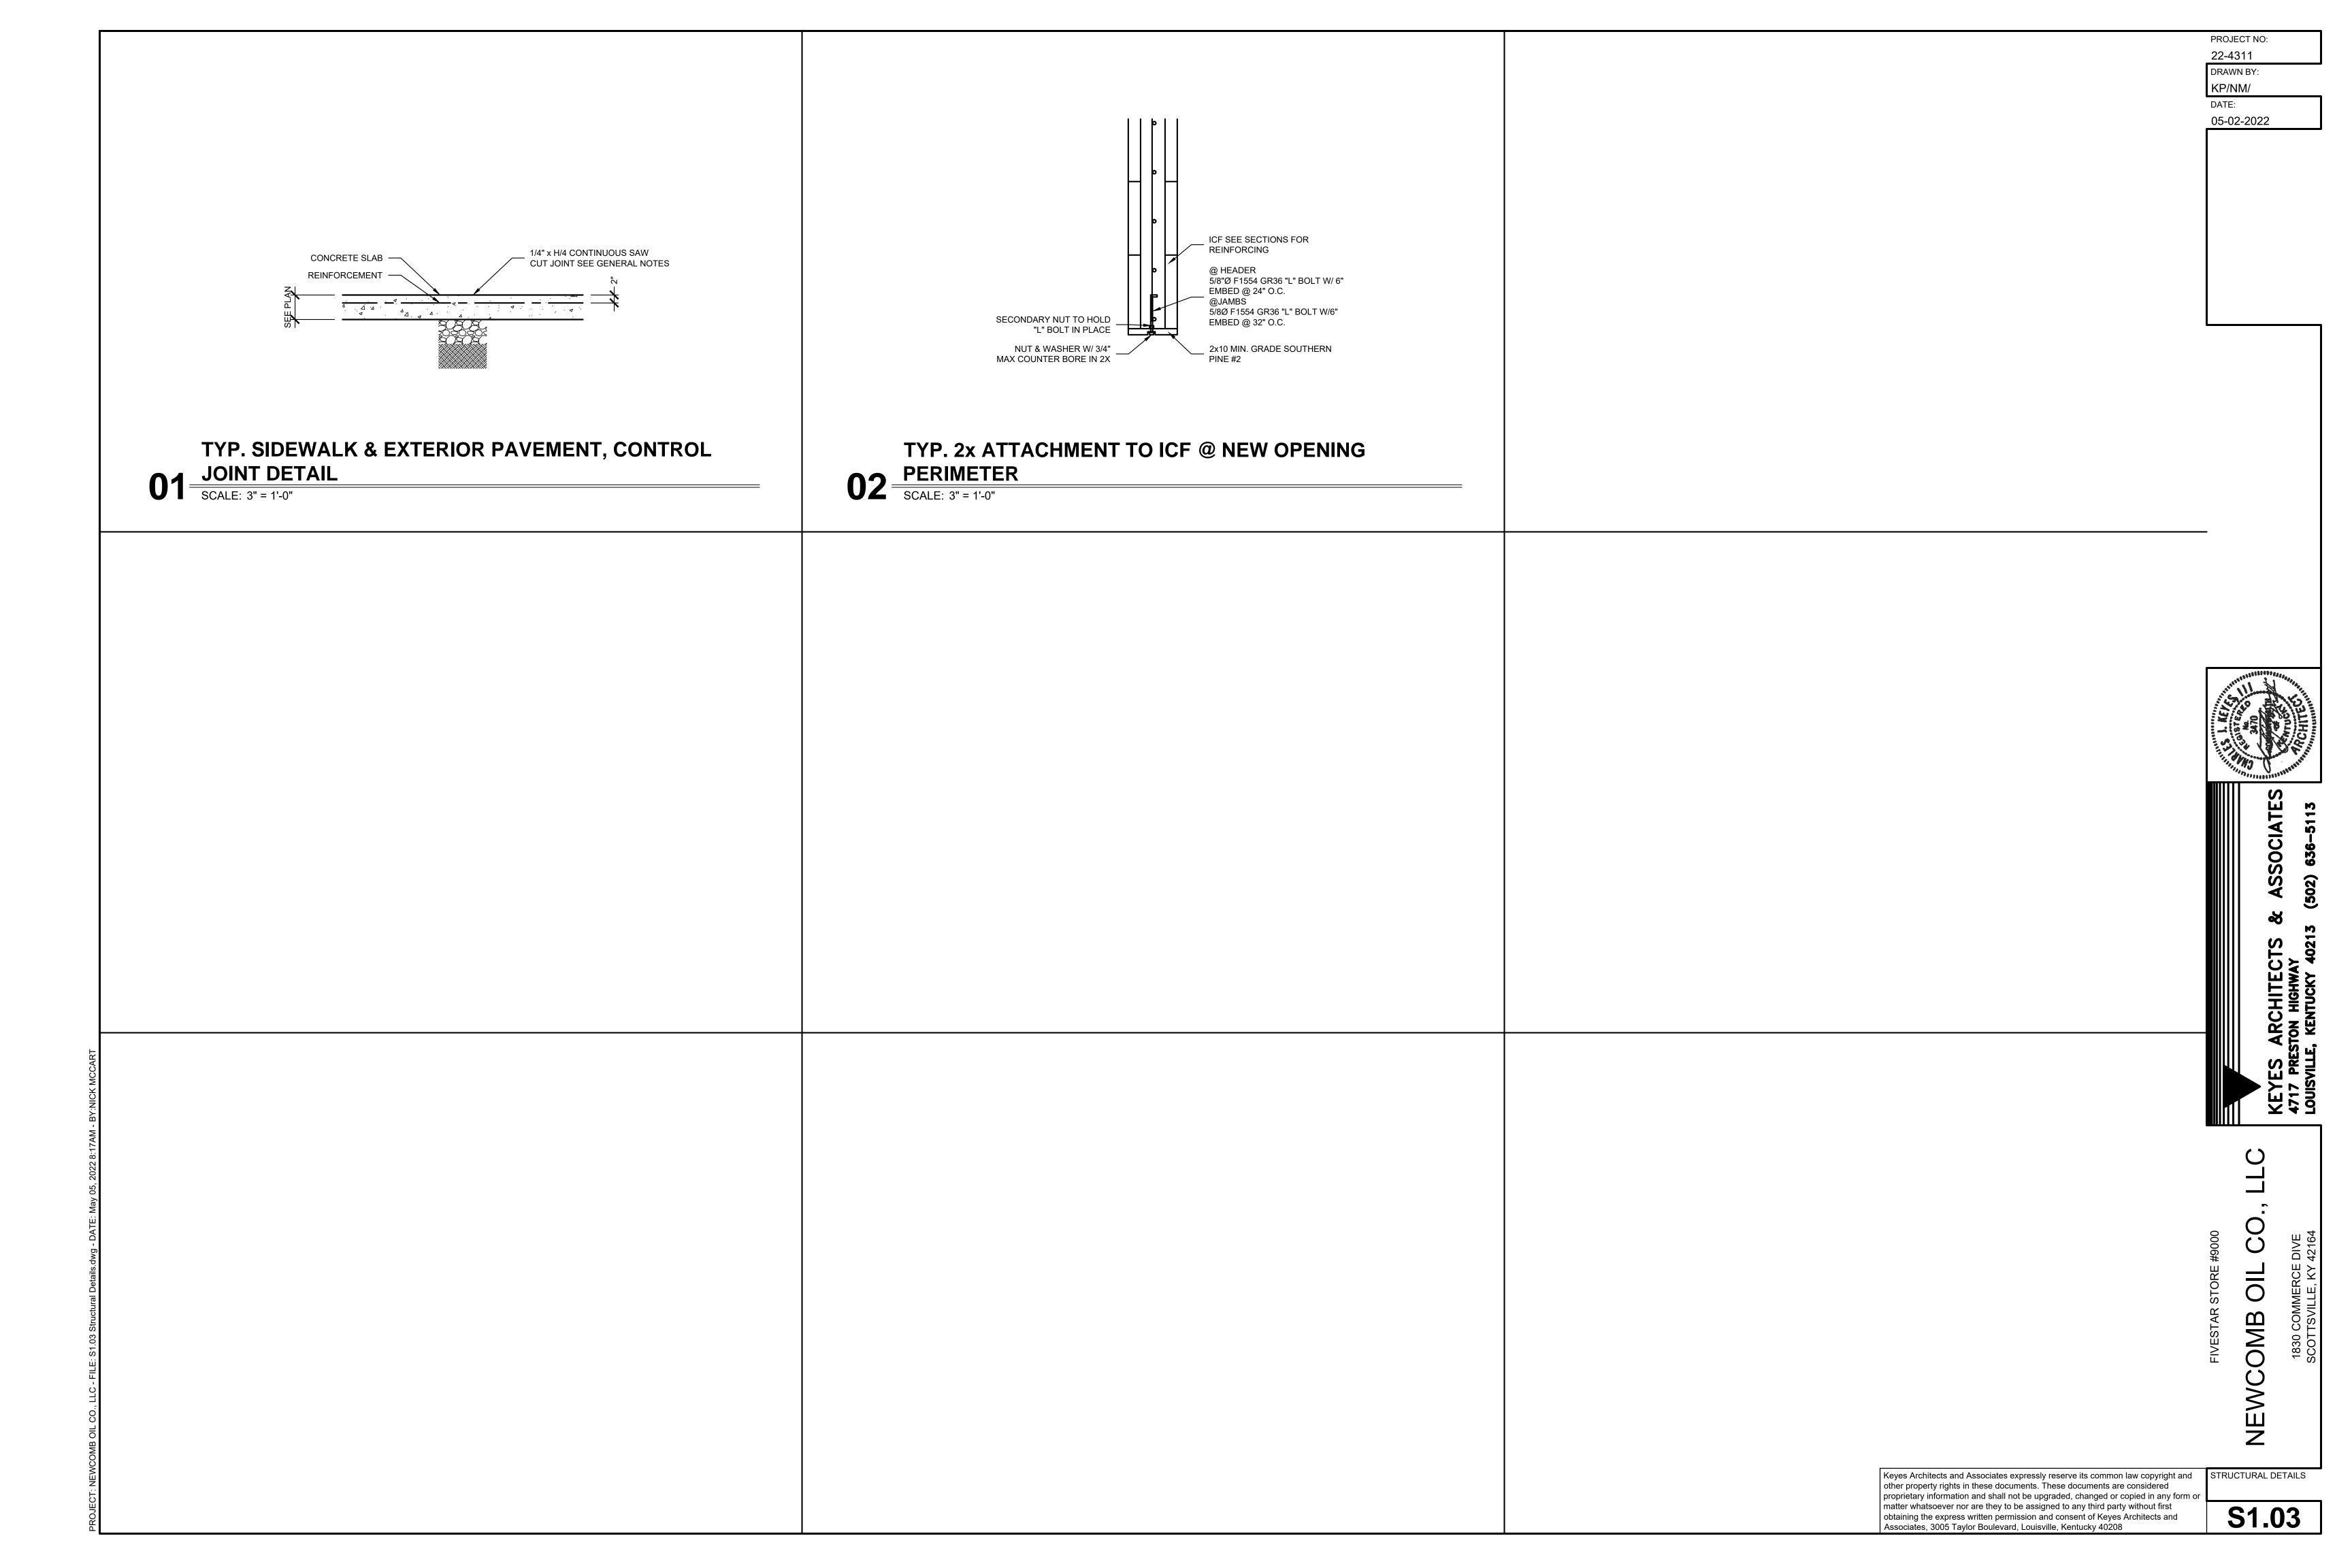
SCALE: 3" = 1'-0"

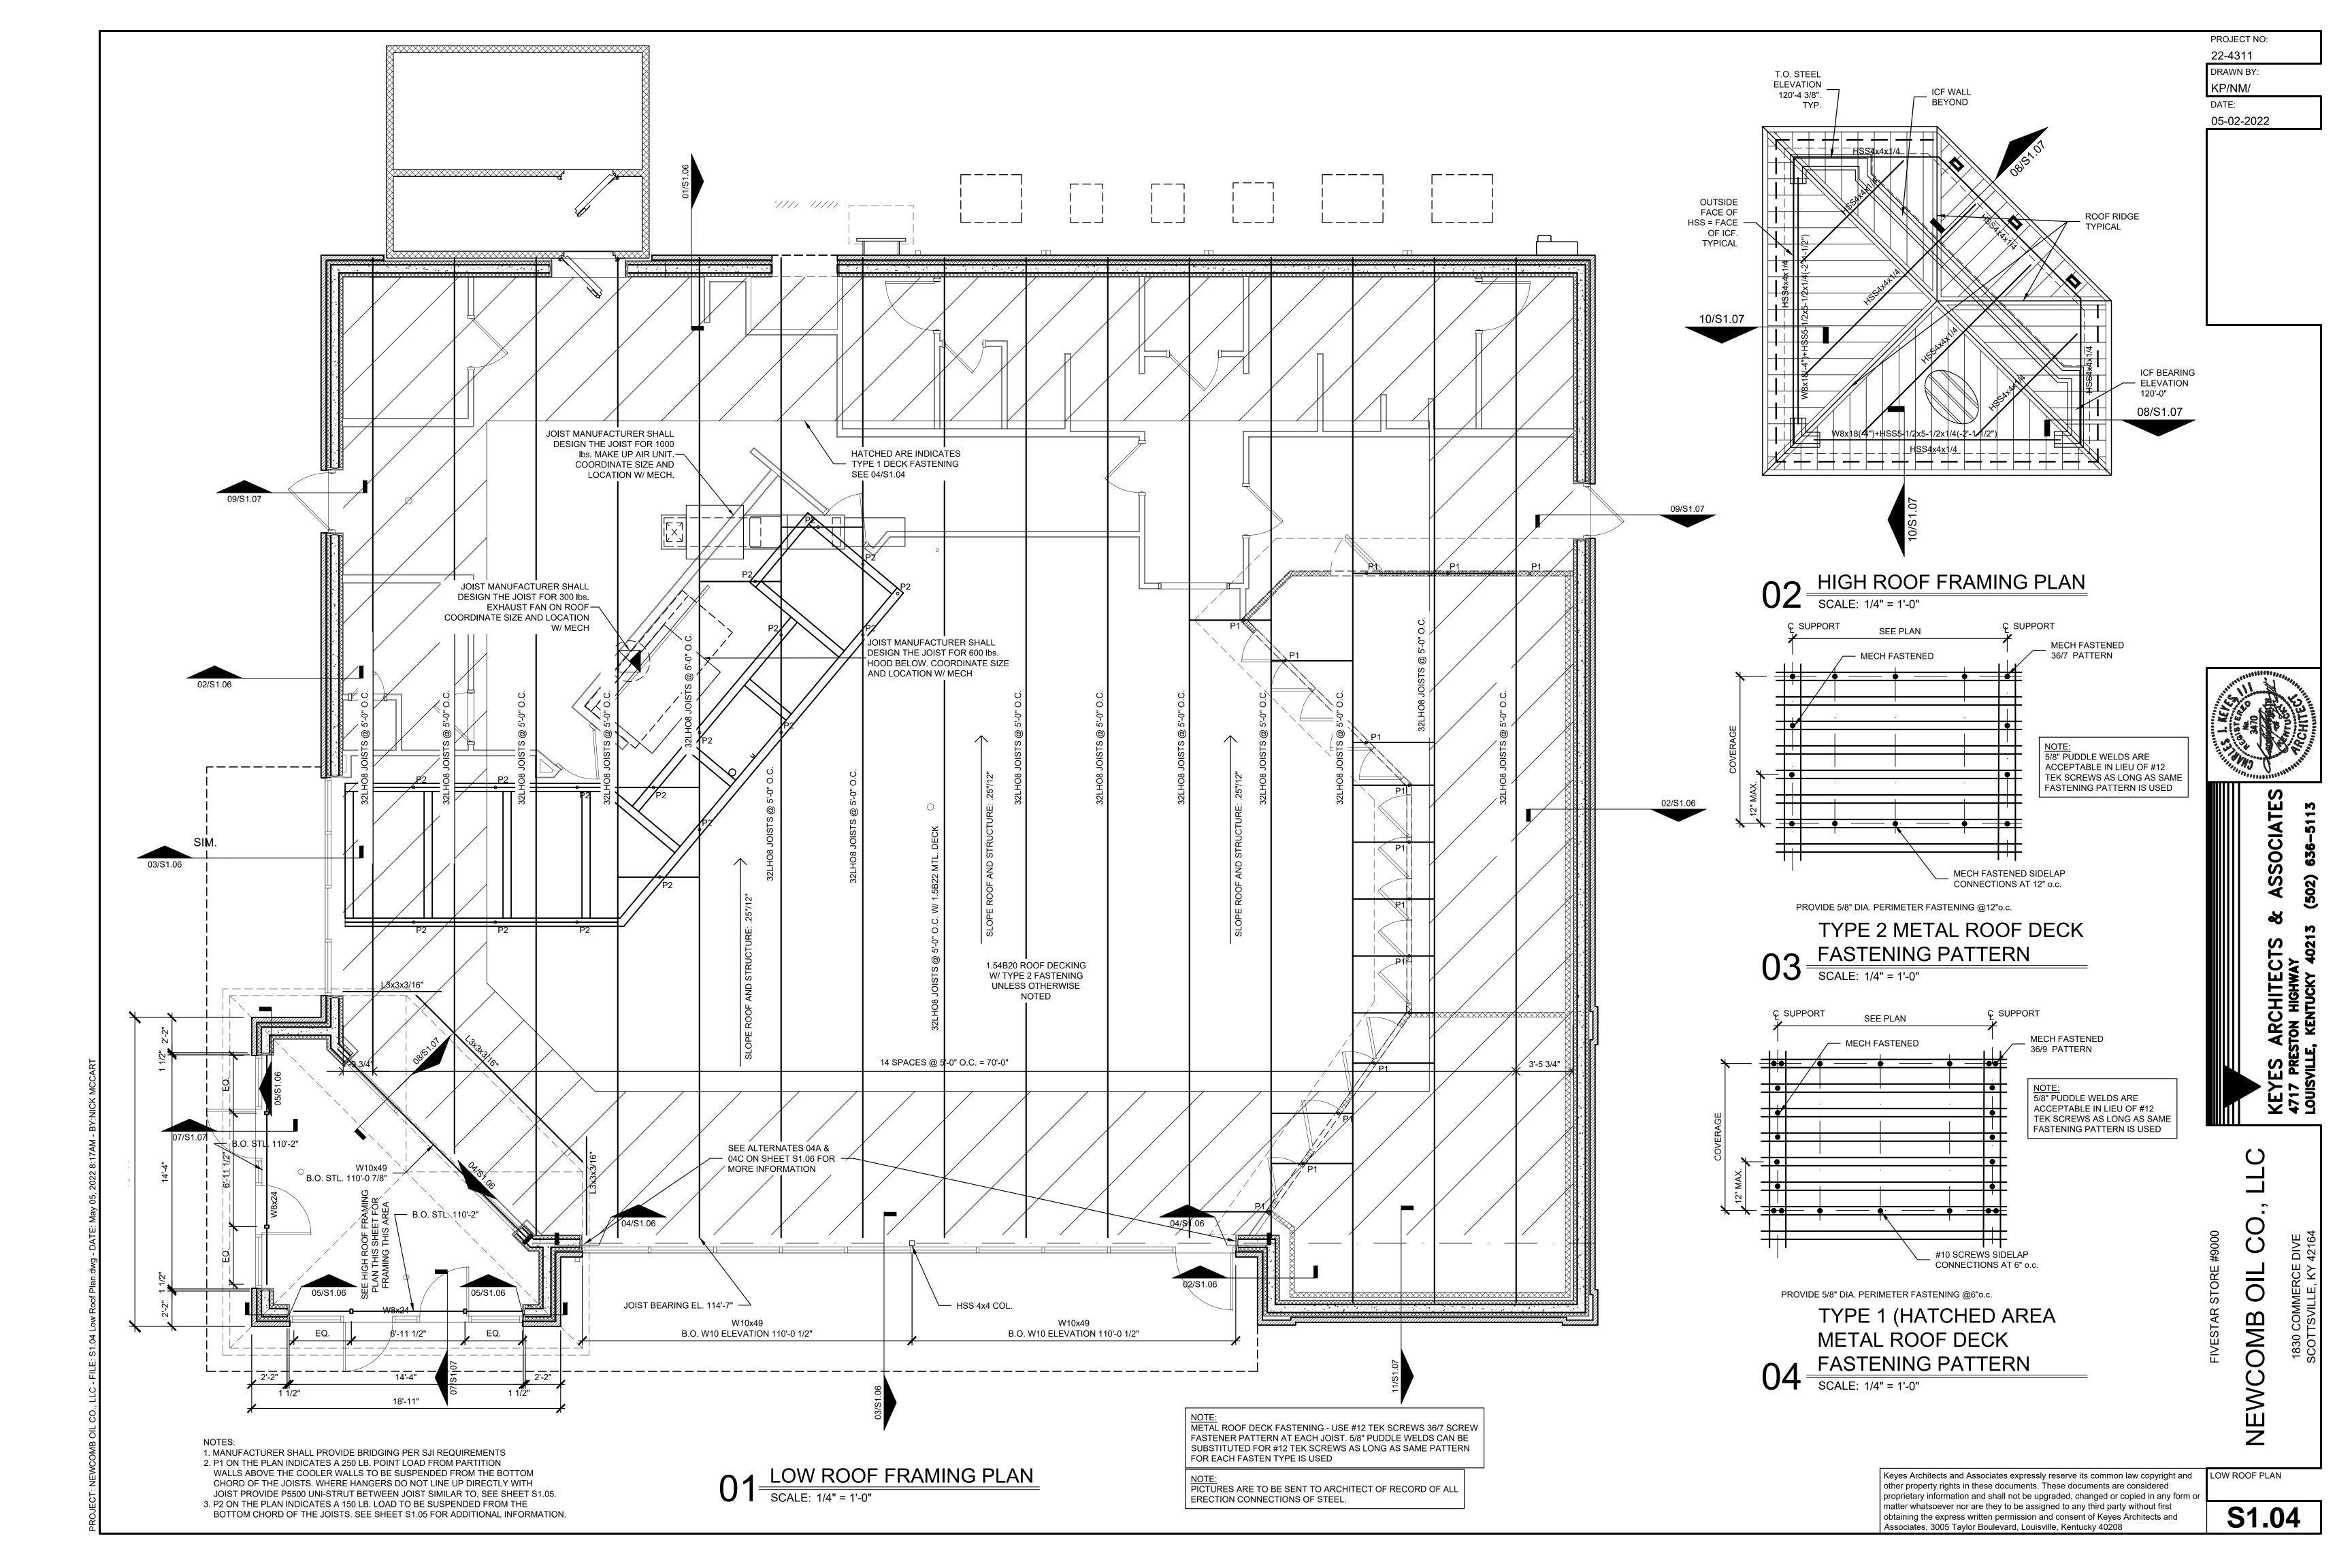
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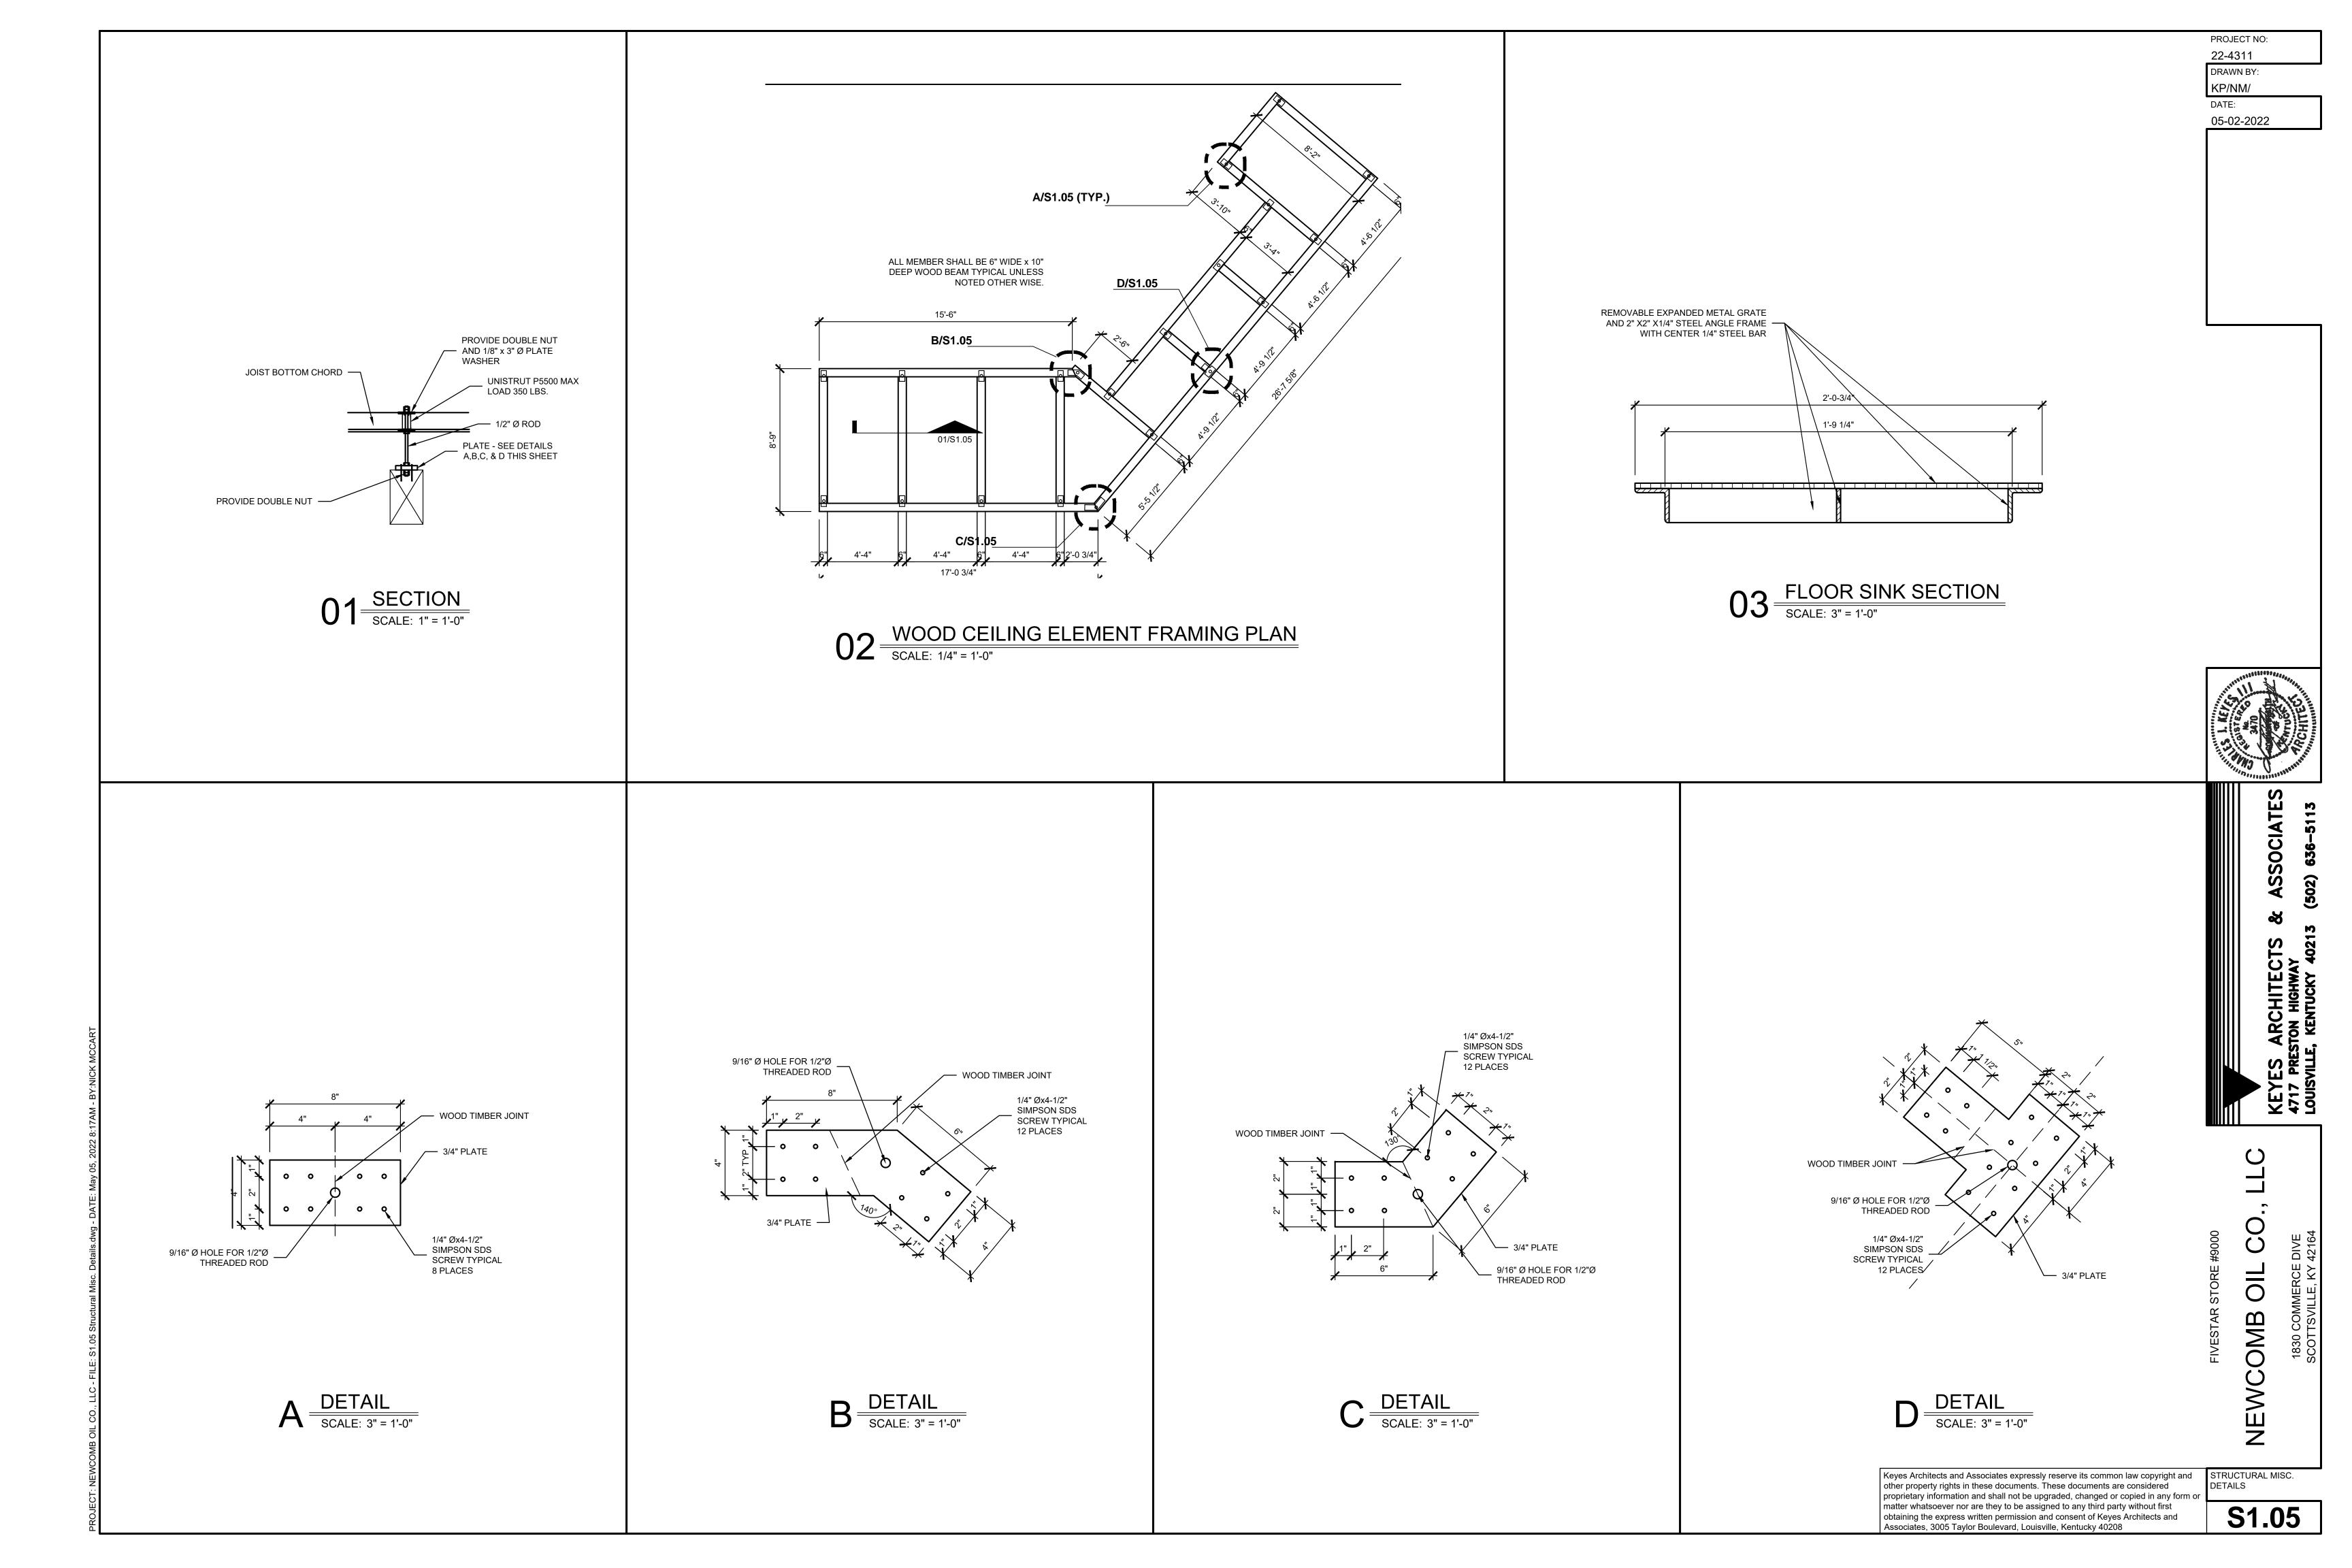
S1.02

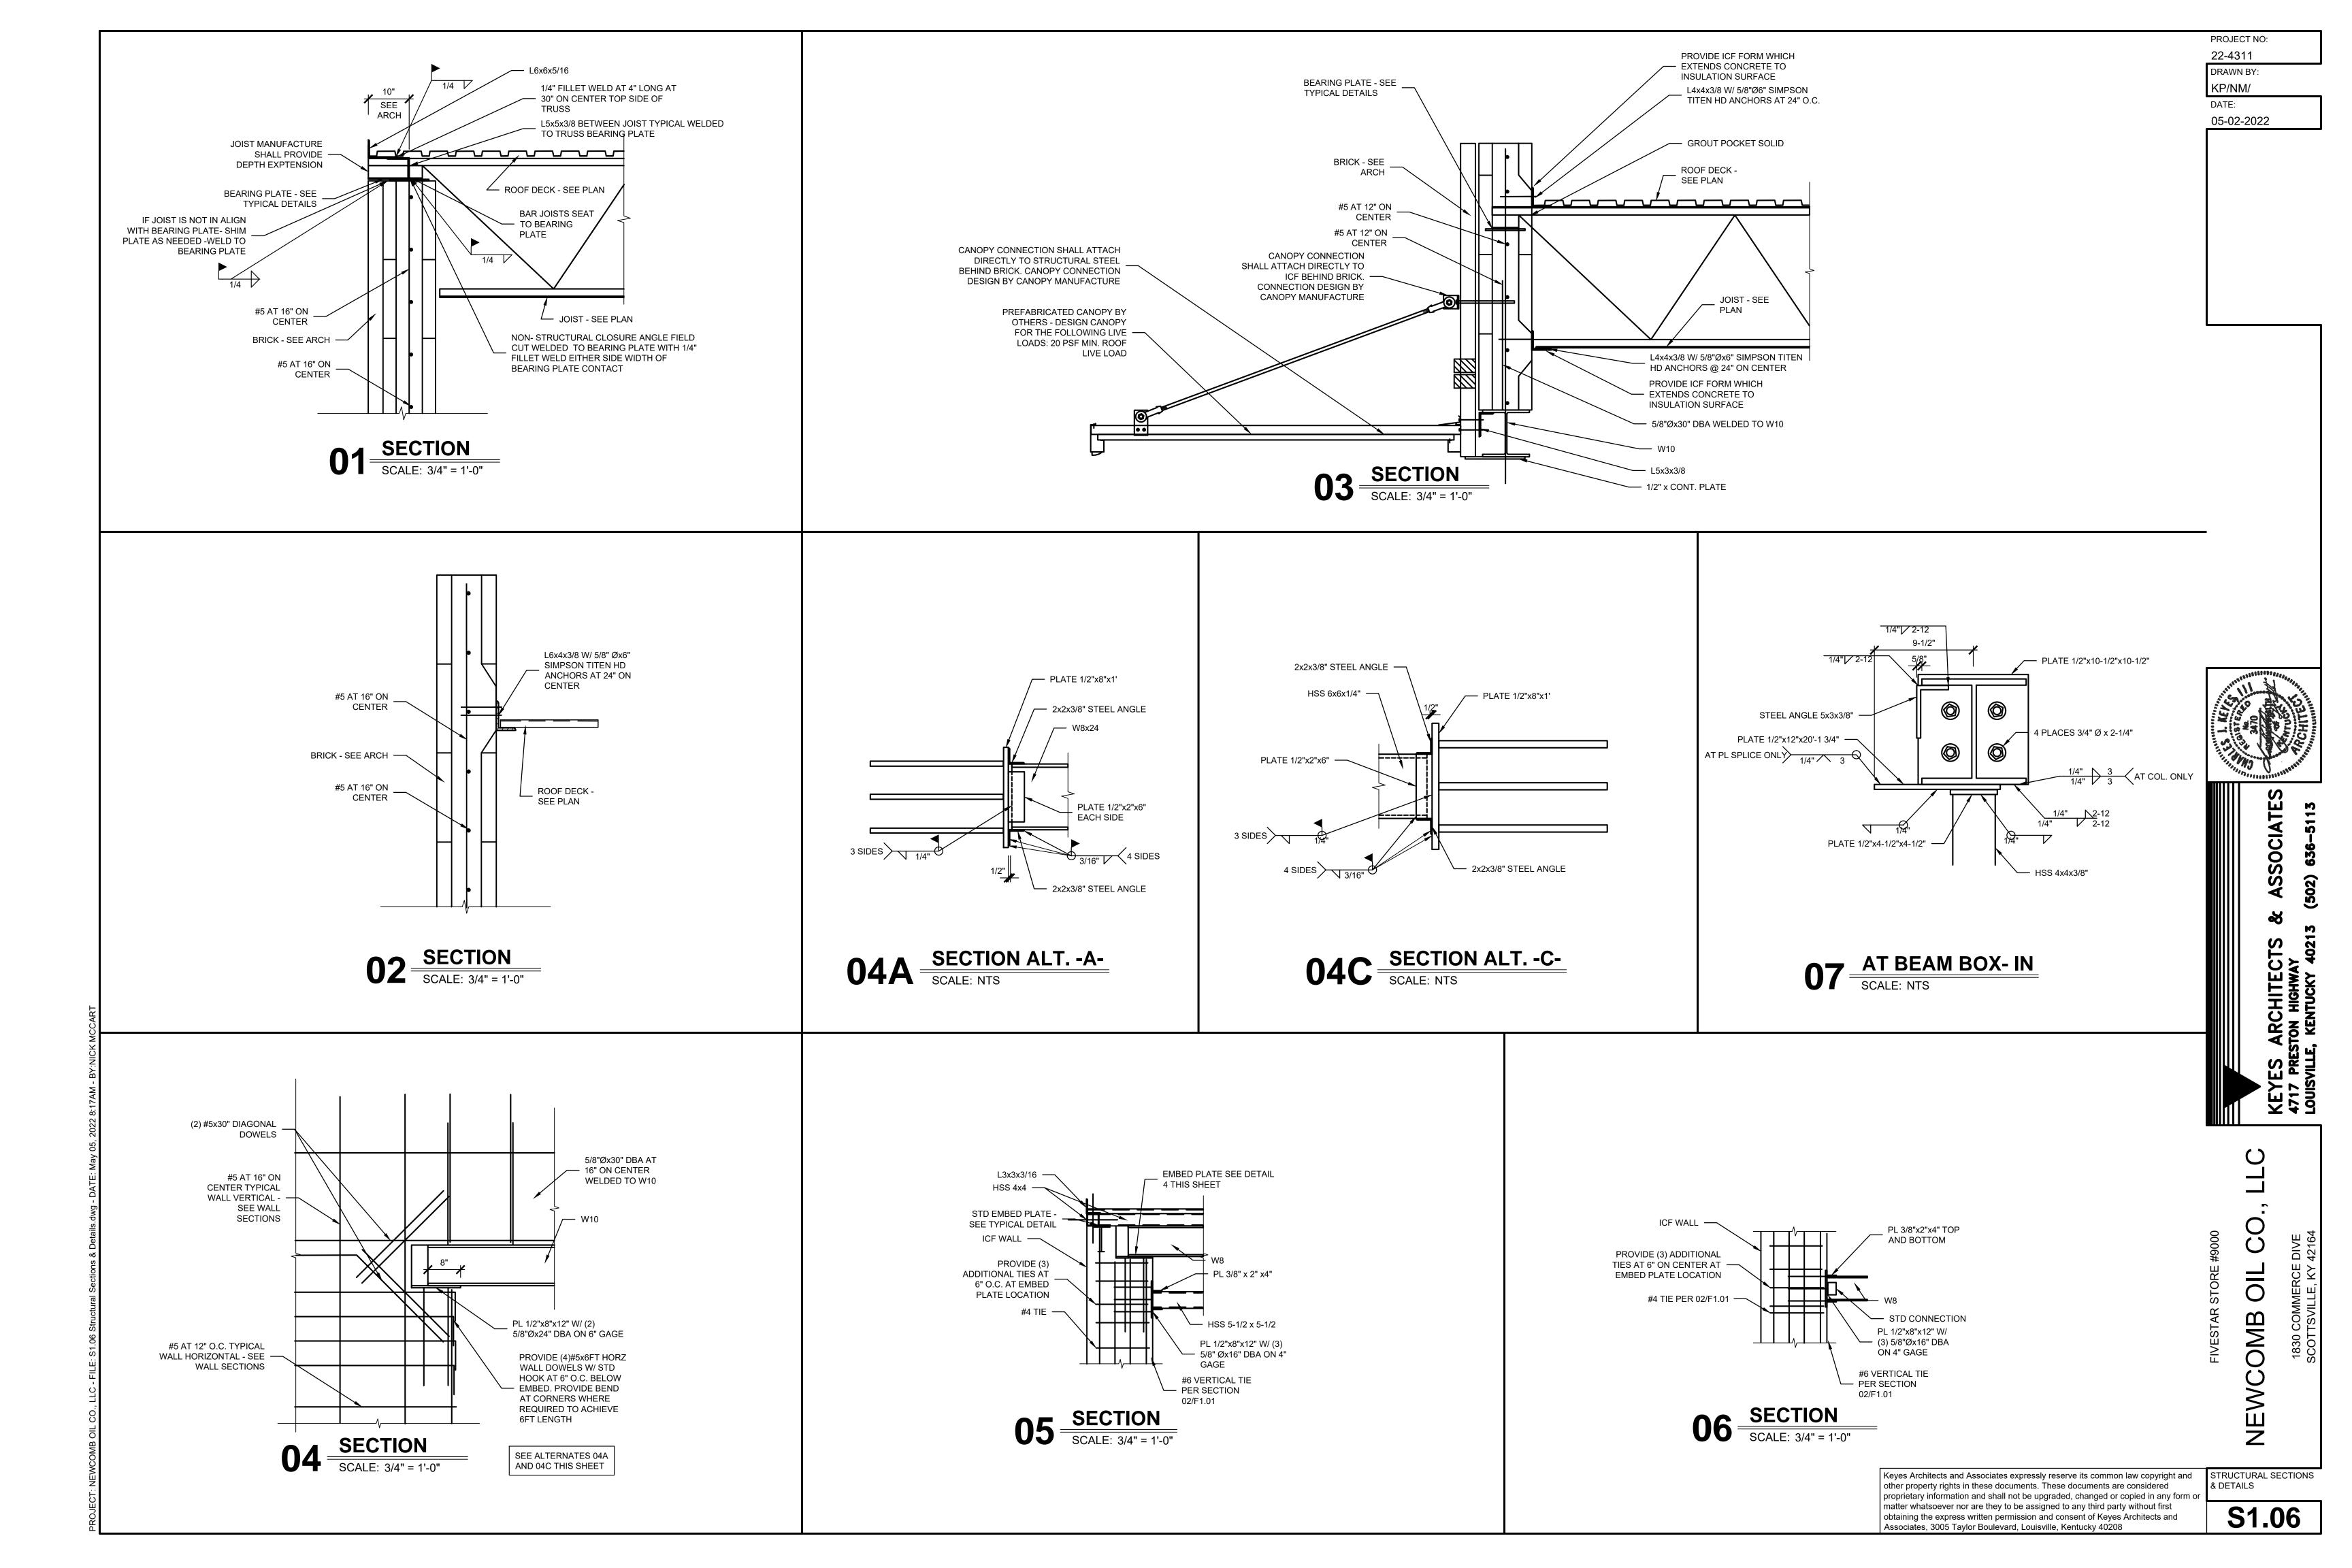
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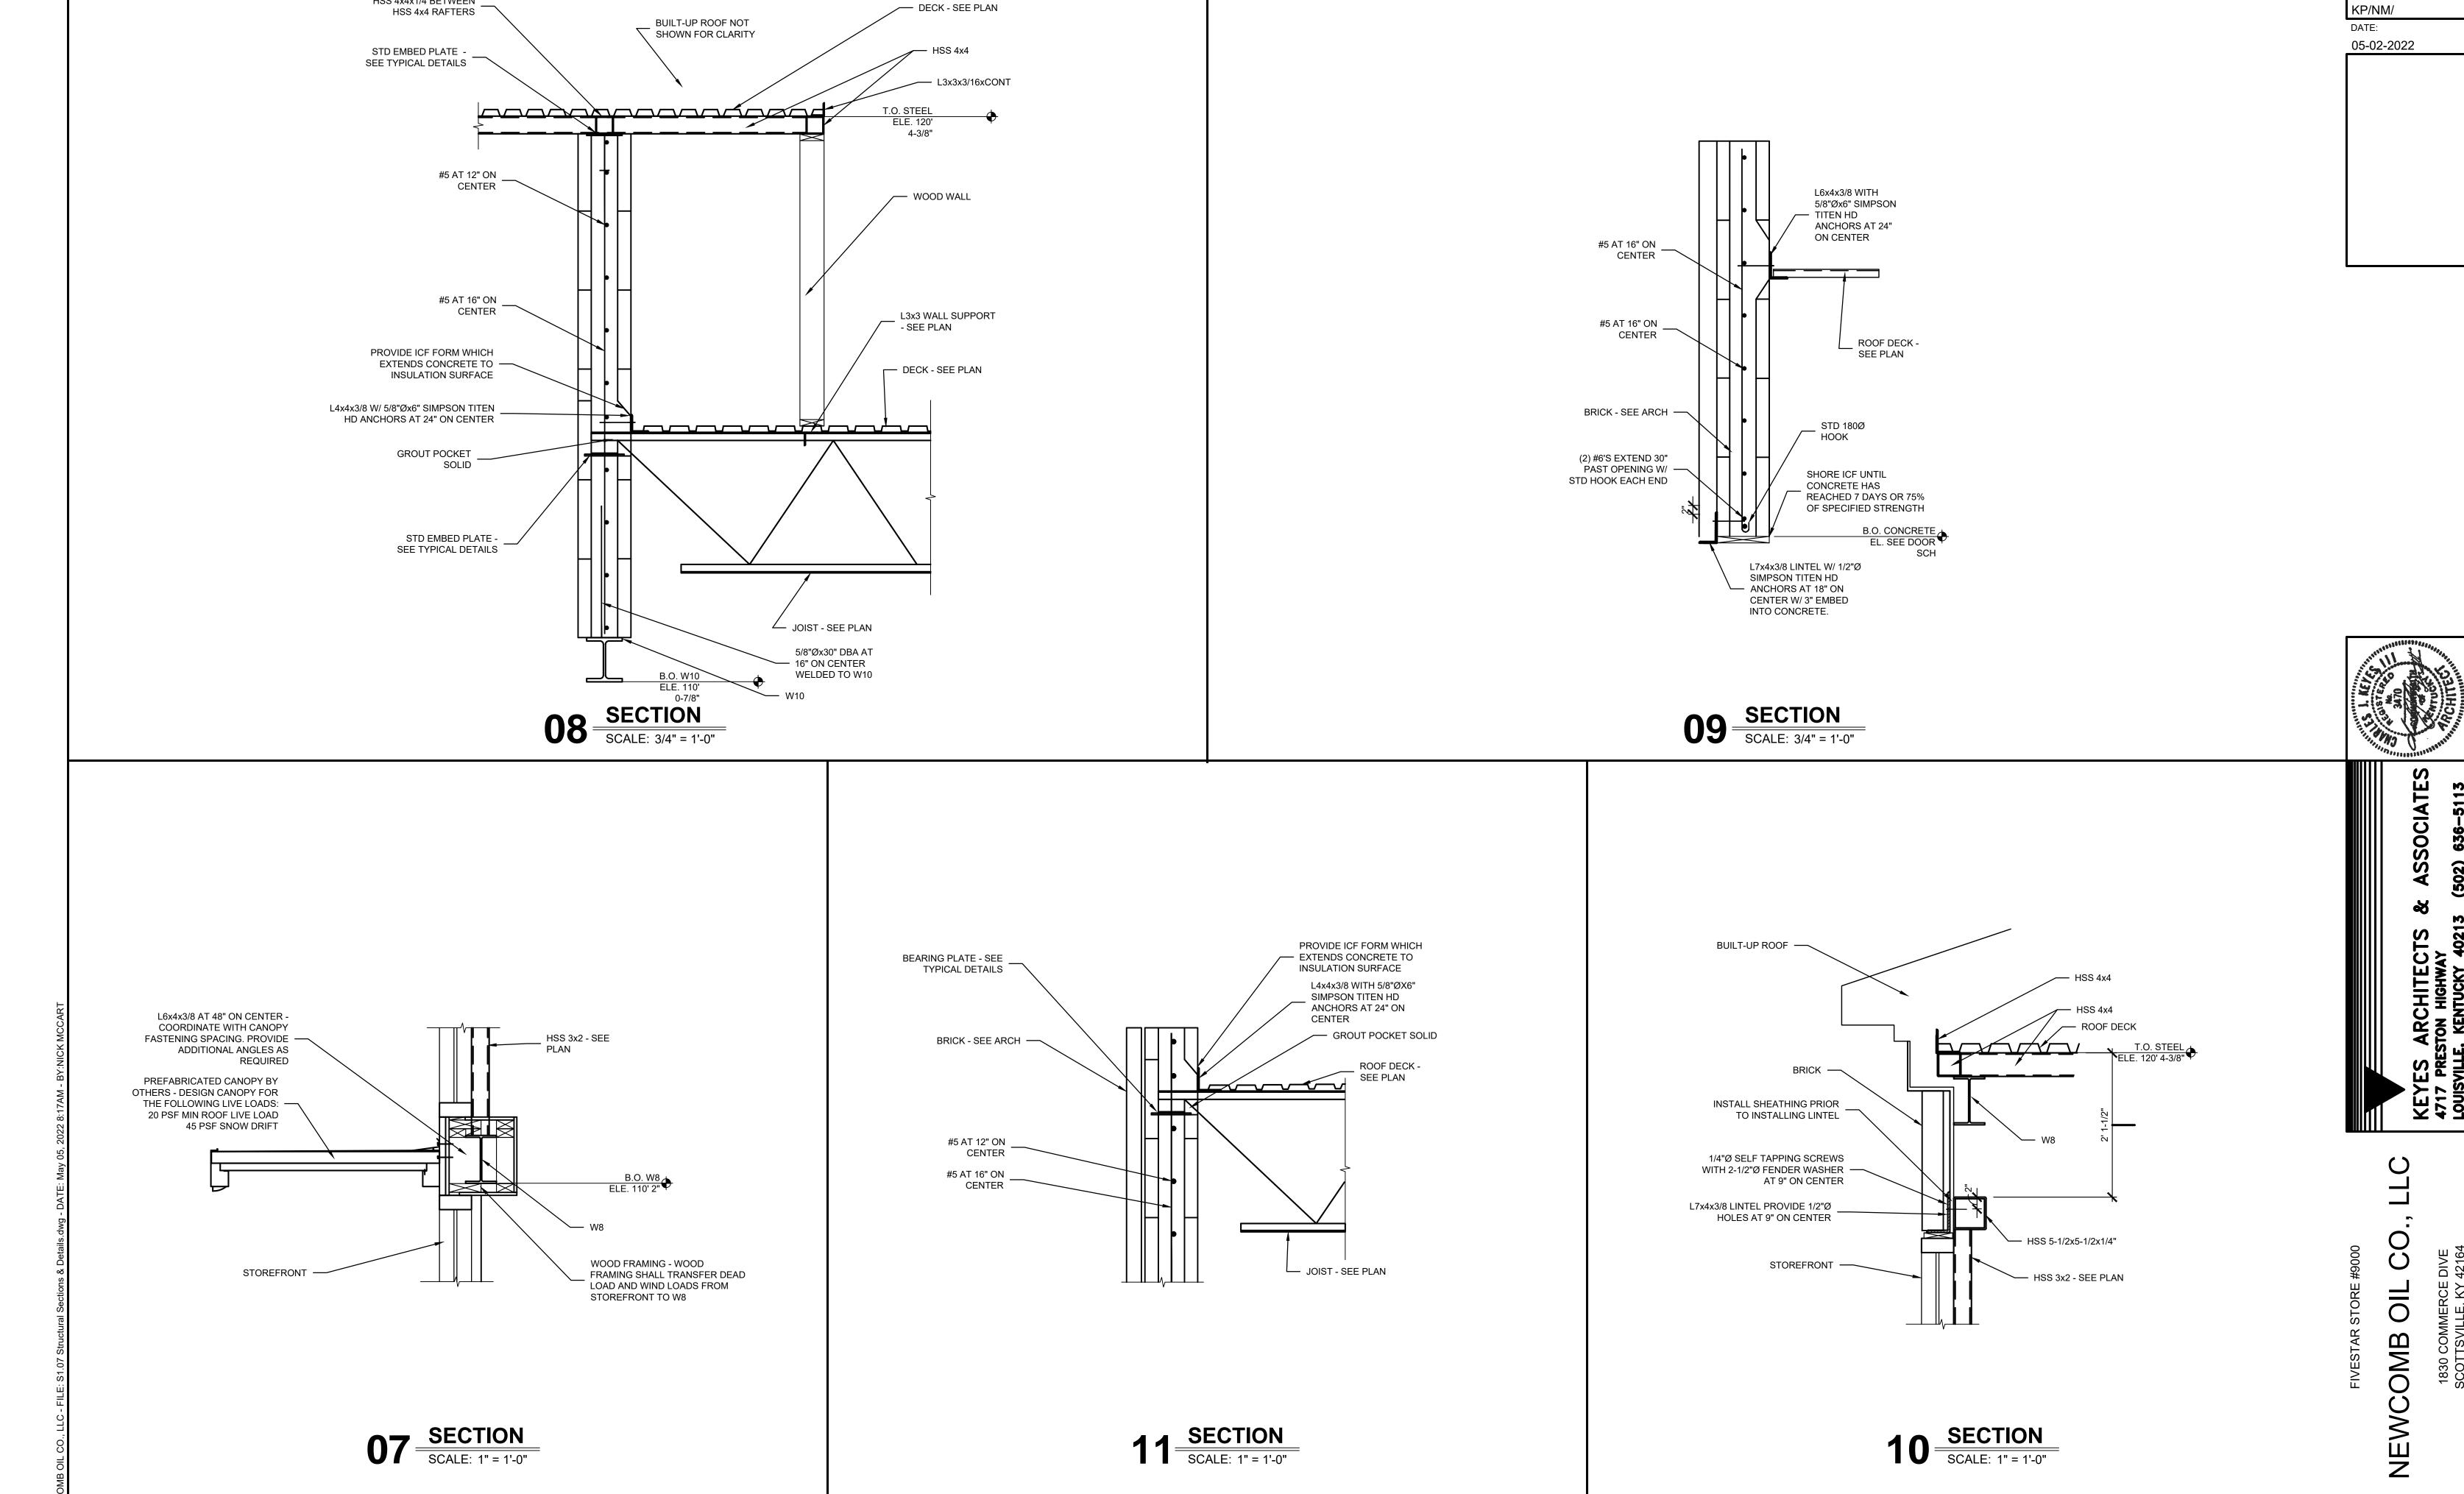
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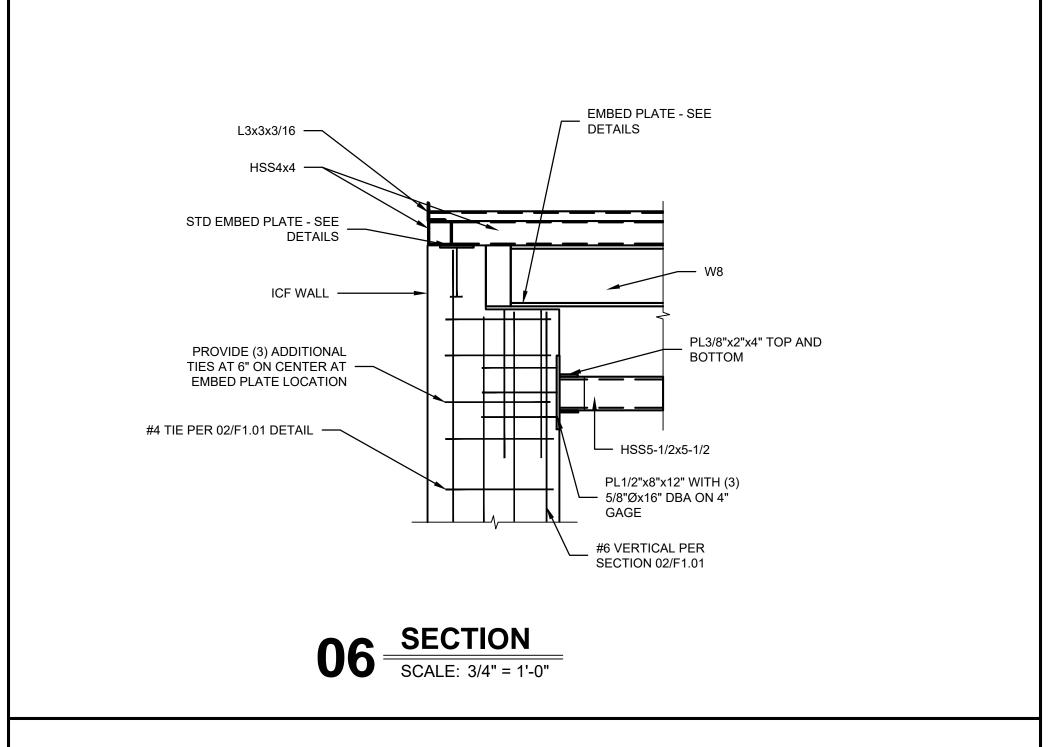
HSS 4x4x1/4 BETWEEN

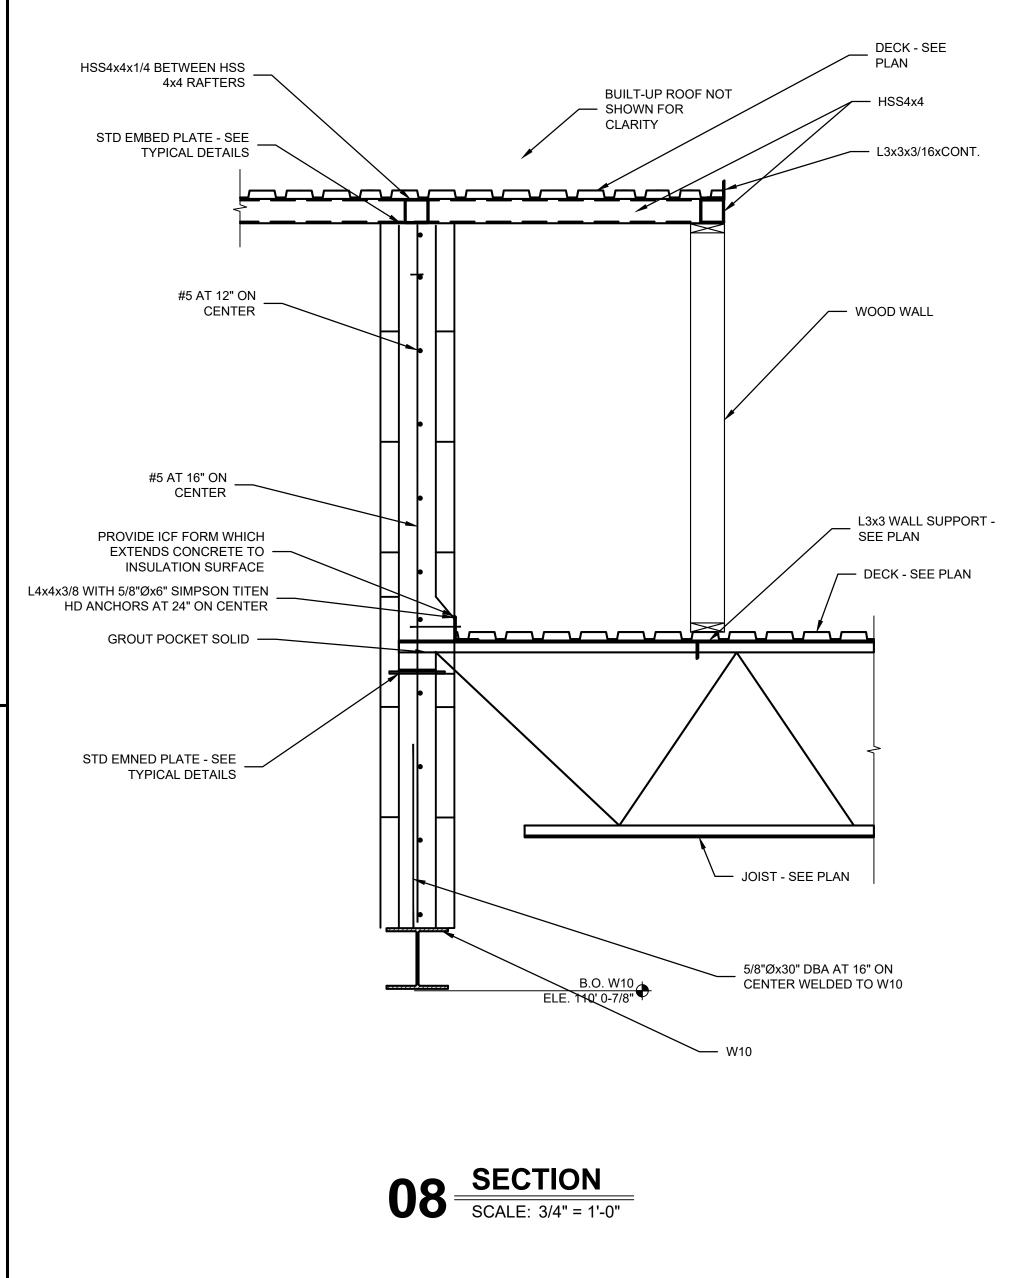
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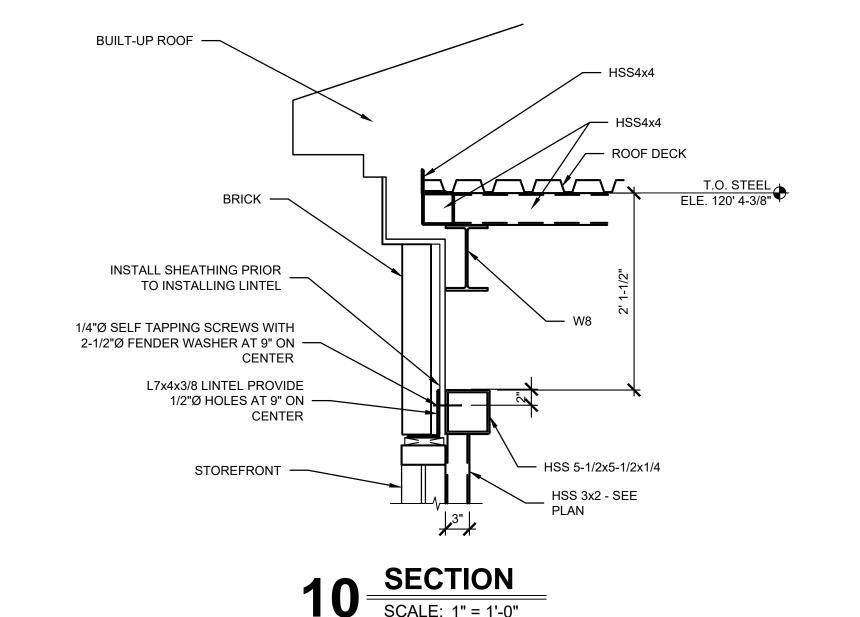
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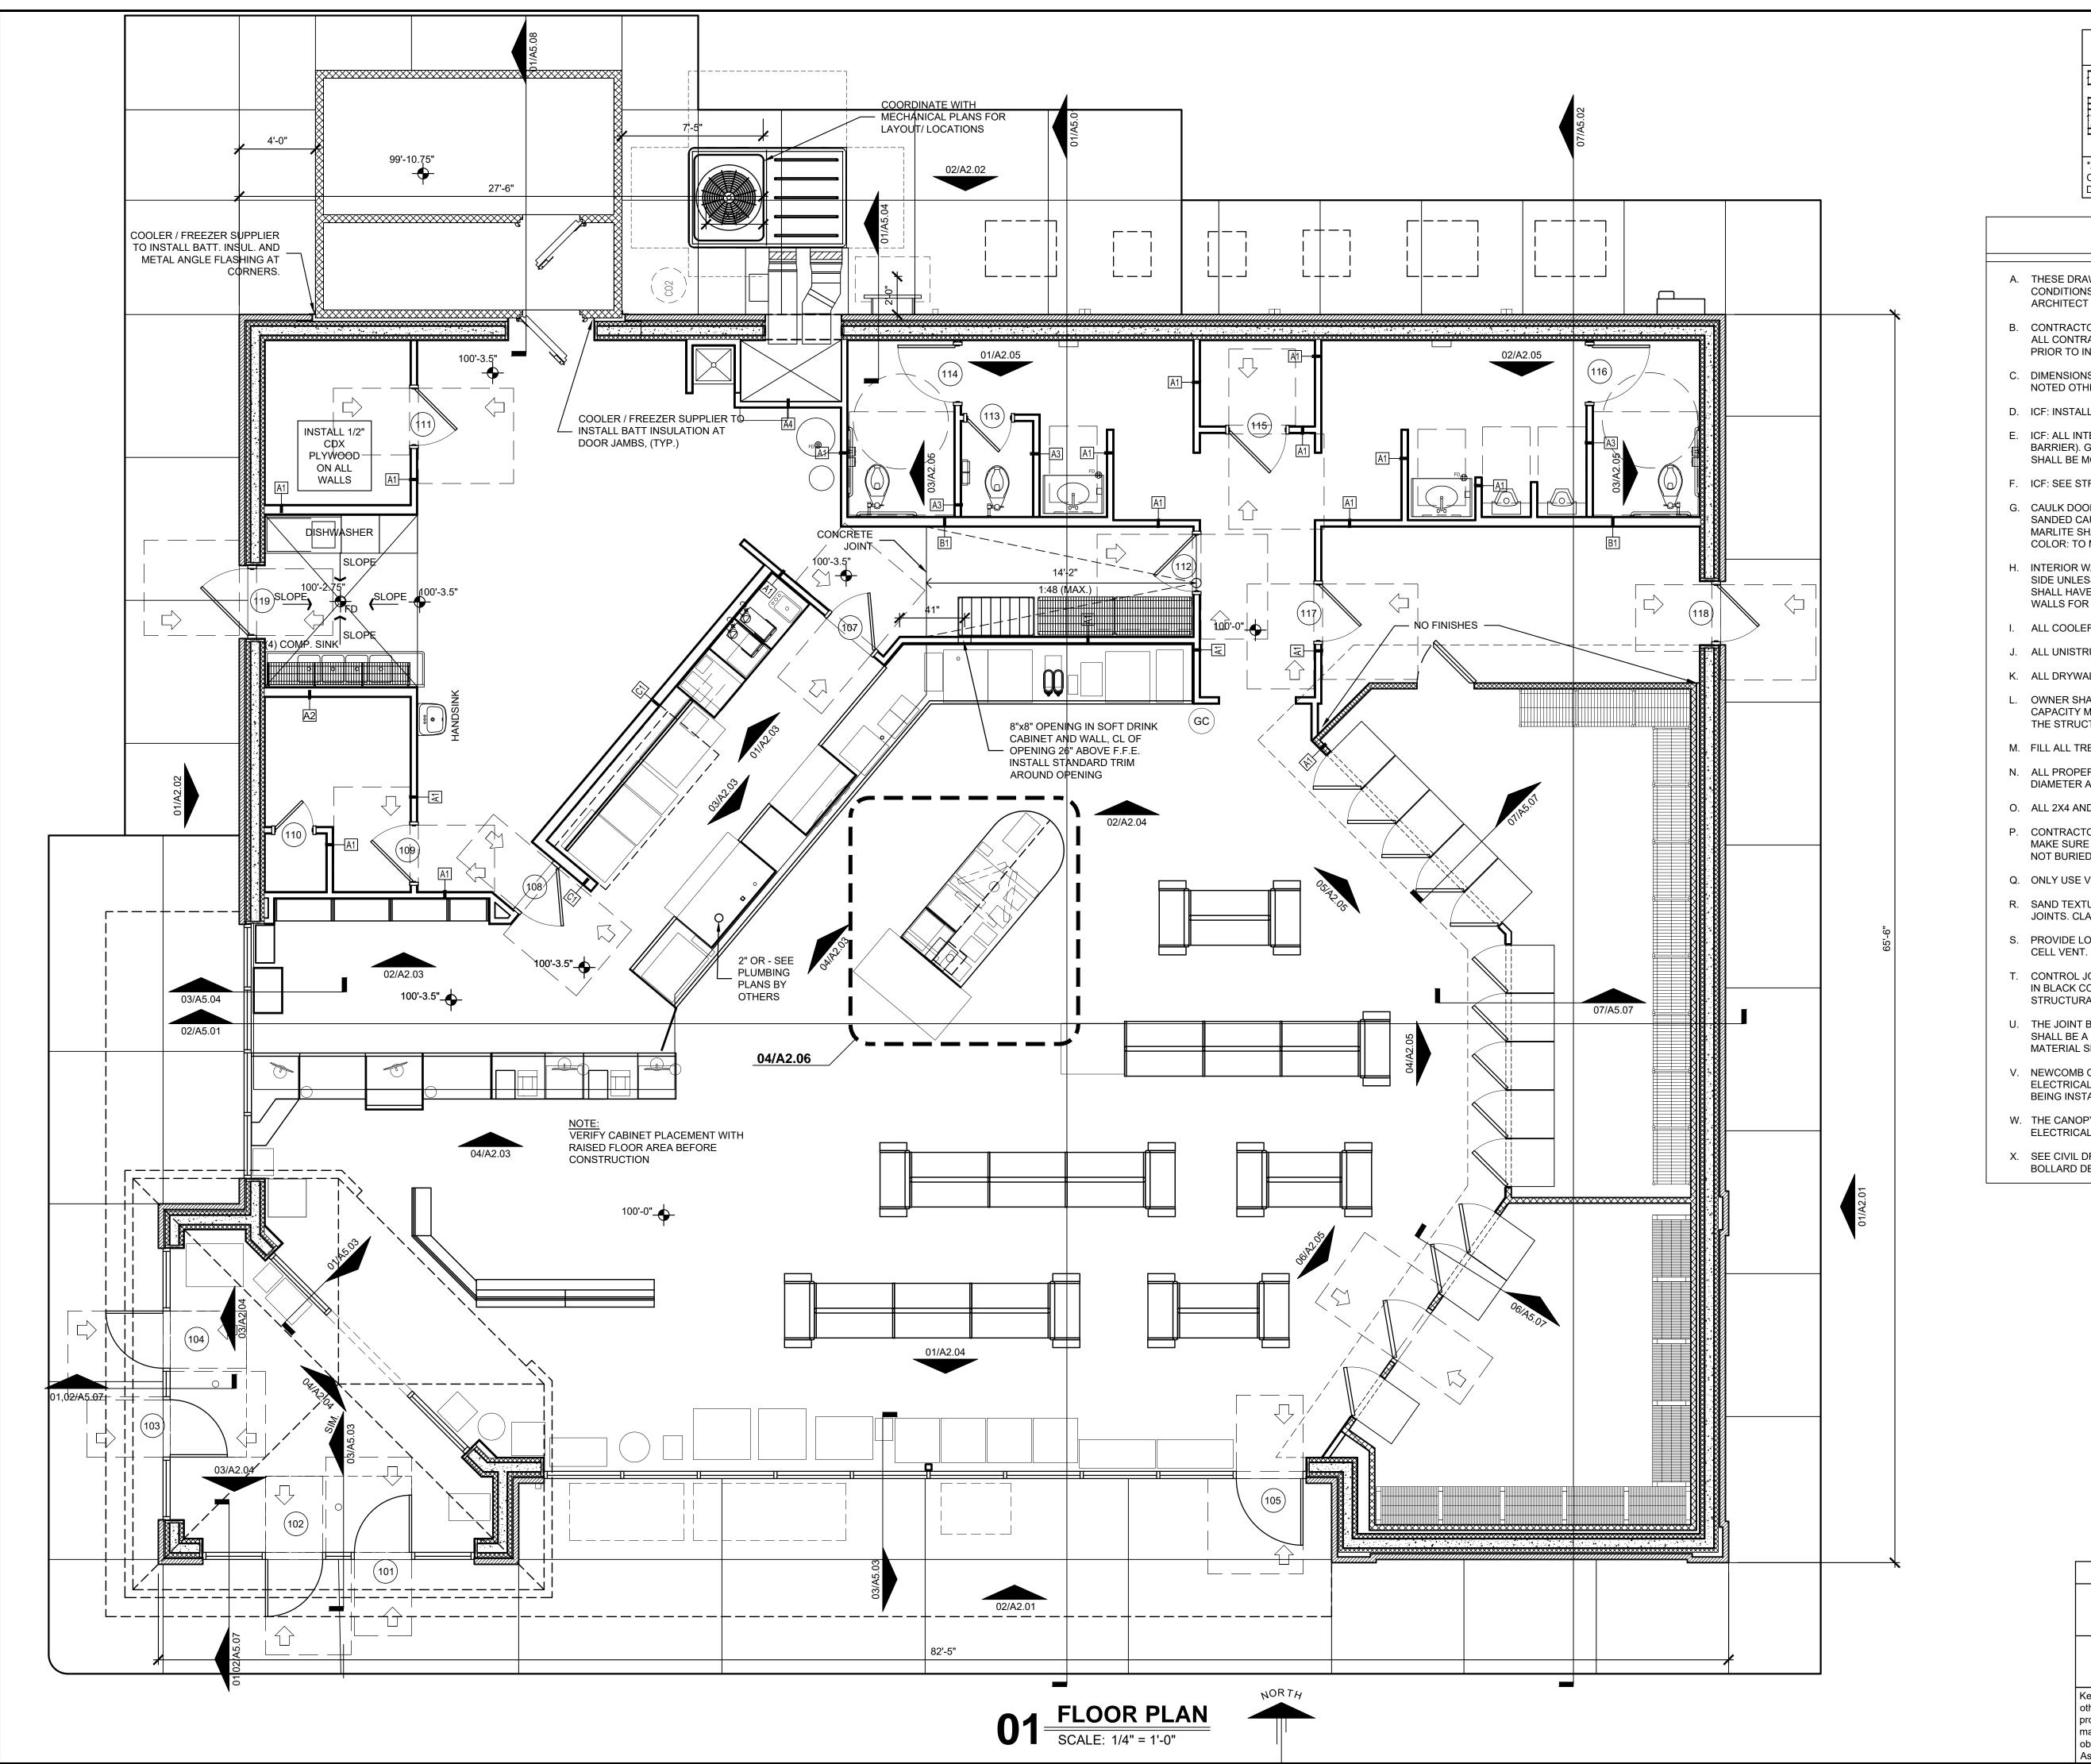


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PROJECT NO: 22-4311 WALL LEGEND DRAWN BY:

KP/NM/ DATE:

05-02-2022

GENERAL NOTES:

DETAILS AT A DIFFERENT SIZE

2x4 WOOD STUD WALL

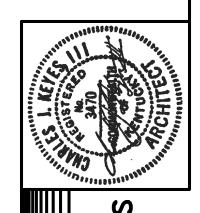
RECOMMENDATIONS.

I.C.F. WALLS TO BE INSTALLED MANUFACTURERS

*ALL MATERIALS ARE SIZES LISTED IN THIS LEGEND UNLESS

OTHERWISE DIMENSIONED ON THIS PLAN OR SPECIFIED IN THE

- A. THESE DRAWINGS ARE DIAGRAMMATIC IN NATURE, FIELD VERIFY ALL CONDITIONS, QUANTITIES AND MATERIALS. REPORT DISCREPANCIES TO ARCHITECT FOR CLARIFICATION. DO NOT SCALE DRAWINGS.
- B. CONTRACTOR IS RESPONSIBLE FOR COORDINATION OF ALL CONSTRUCTION. ALL CONTRACTORS OF ALL DISCIPLINES TO COORDINATE CONSTRUCTION PRIOR TO INSTALLATION.
- C. DIMENSIONS ARE TO THE FINISHED FACE OF STUD, CONCRETE, OR ICF UNLESS NOTED OTHERWISE.
- D. ICF: INSTALL PER MANUFACTURERS RECOMMENDATIONS.
- E. ICF: ALL INTERIOR ICF WALLS TO RECEIVE 1/2" MIN. GYP. BD. (15 MIN. THERMAL BARRIER). GYP. BD. BEHIND COOLERS AND FREEZERS AND IN RESTROOMS SHALL BE MOISTURE AND MOLD RESISTANT GYP. BD.
- F. ICF: SEE STRUCTURAL DRAWINGS FOR REINFORCING DESIGN IN ICF WALLS
- G. CAULK DOOR JAMBS AND INSIDE CORNERS IN CERAMIC TILE WALLS WITH SANDED CAULK TO MATCH THE GROUT COLOR. ALL OTHER DOOR JAMBS AND MARLITE SHALL BE CAULKED WITH SHERWIN WILLIAMS POWER HOUSE 60 YR, COLOR: TO MATCH PAINT.
- H. INTERIOR WALLS SHALL BE 2X4 WD STUDS 16" O.C. WITH 1/2" GYP BD. EACH SIDE UNLESS NOTED OTHERWISE. WALLS BEHIND COOLER AND FREEZERS SHALL HAVE MOISTURE AND MOLD RESISTANT GYP. BD.. PROVIDE BLOCKING IN WALLS FOR DOOR WALL STOPS.
- I. ALL COOLER DOORS SHALL BE INSTALLED 8" A.F.F.
- J. ALL UNISTRUTS SHALL BE INSTALLED OPEN SIDE UP.
- K. ALL DRYWALL CEILINGS SHALL BE GLUED AND SCREWED.
- L. OWNER SHALL VERIFY THAT GEOTECHNICAL CONDITIONS AND SOIL BEARING CAPACITY MEET THE REQUIREMENTS OF THE "FOUNDATION DESIGN" NOTED IN THE STRUCTURAL DRAWINGS.
- M. FILL ALL TRENCHES UNDER PAVEMENT WITH STONE
- N. ALL PROPERTY CORNER PINS SHALL BE ENCASED IN CONCRETE 12" DEEP, 8" DIAMETER AND SHALL BE FLUSH WITH THE GROUND.
- O. ALL 2X4 AND 2X6 WOOD STUDS SHALL BE #2 SPRUCE ONLY.
- P. CONTRACTOR SHALL POLICE THE SITE AFTER COMPLETION OF THE BRICK TO MAKE SURE ALL BRICK AND MORTAR ARE CLEANED UP FROM THE SITE AND NOT BURIED IN THE FOOTING TRENCHES.
- Q. ONLY USE VANITROLL FOR BRICK CLEANING.
- R. SAND TEXTURED CAULK TO BE USED WHEN CAULKING BRICK EXPANSION JOINTS. CLAY TAN 225-U (LRV -19)
- S. PROVIDE LOW WEEP VENTS IN VENEER MASONRY BRICK. USE 3/8" HONEYCOMB
- T. CONTROL JOINTS IN EXTERIOR BUILDING CONCRETE SIDEWALKS AND JOINTS
- IN BLACK CONCRETE SHALL BE TOOLED AND SAW CUT. REFER TO STRUCTURAL DRAWINGS FOR MORE INFORMATION.
- U. THE JOINT BETWEEN THE BUILDING SIDEWALK AND THE BLACK CONCRETE PAD SHALL BE A CONSTRUCTION JOINT NOT AN EXPANSION JOINT. NO EXPANSION MATERIAL SHALL BE INSTALLED.
- V. NEWCOMB OIL SHALL CHECK WALLS FOR ALIGNMENT, LOCATION OF ELECTRICAL AND PLUMBING AND STRING LINE THE WALLS PRIOR TO DRYWALL BEING INSTALLED.
- W. THE CANOPY CONTRACTOR SHALL INSTALL CANOPY SIGNS. THE BUILDING
- ELECTRICAL CONTRACTOR SHALL INSTALL THE BUILDING SIGNS.
- X. SEE CIVIL DRAWINGS FOR BOLLARD LOCATION. SEE DETAIL 02/A5.02 FOR

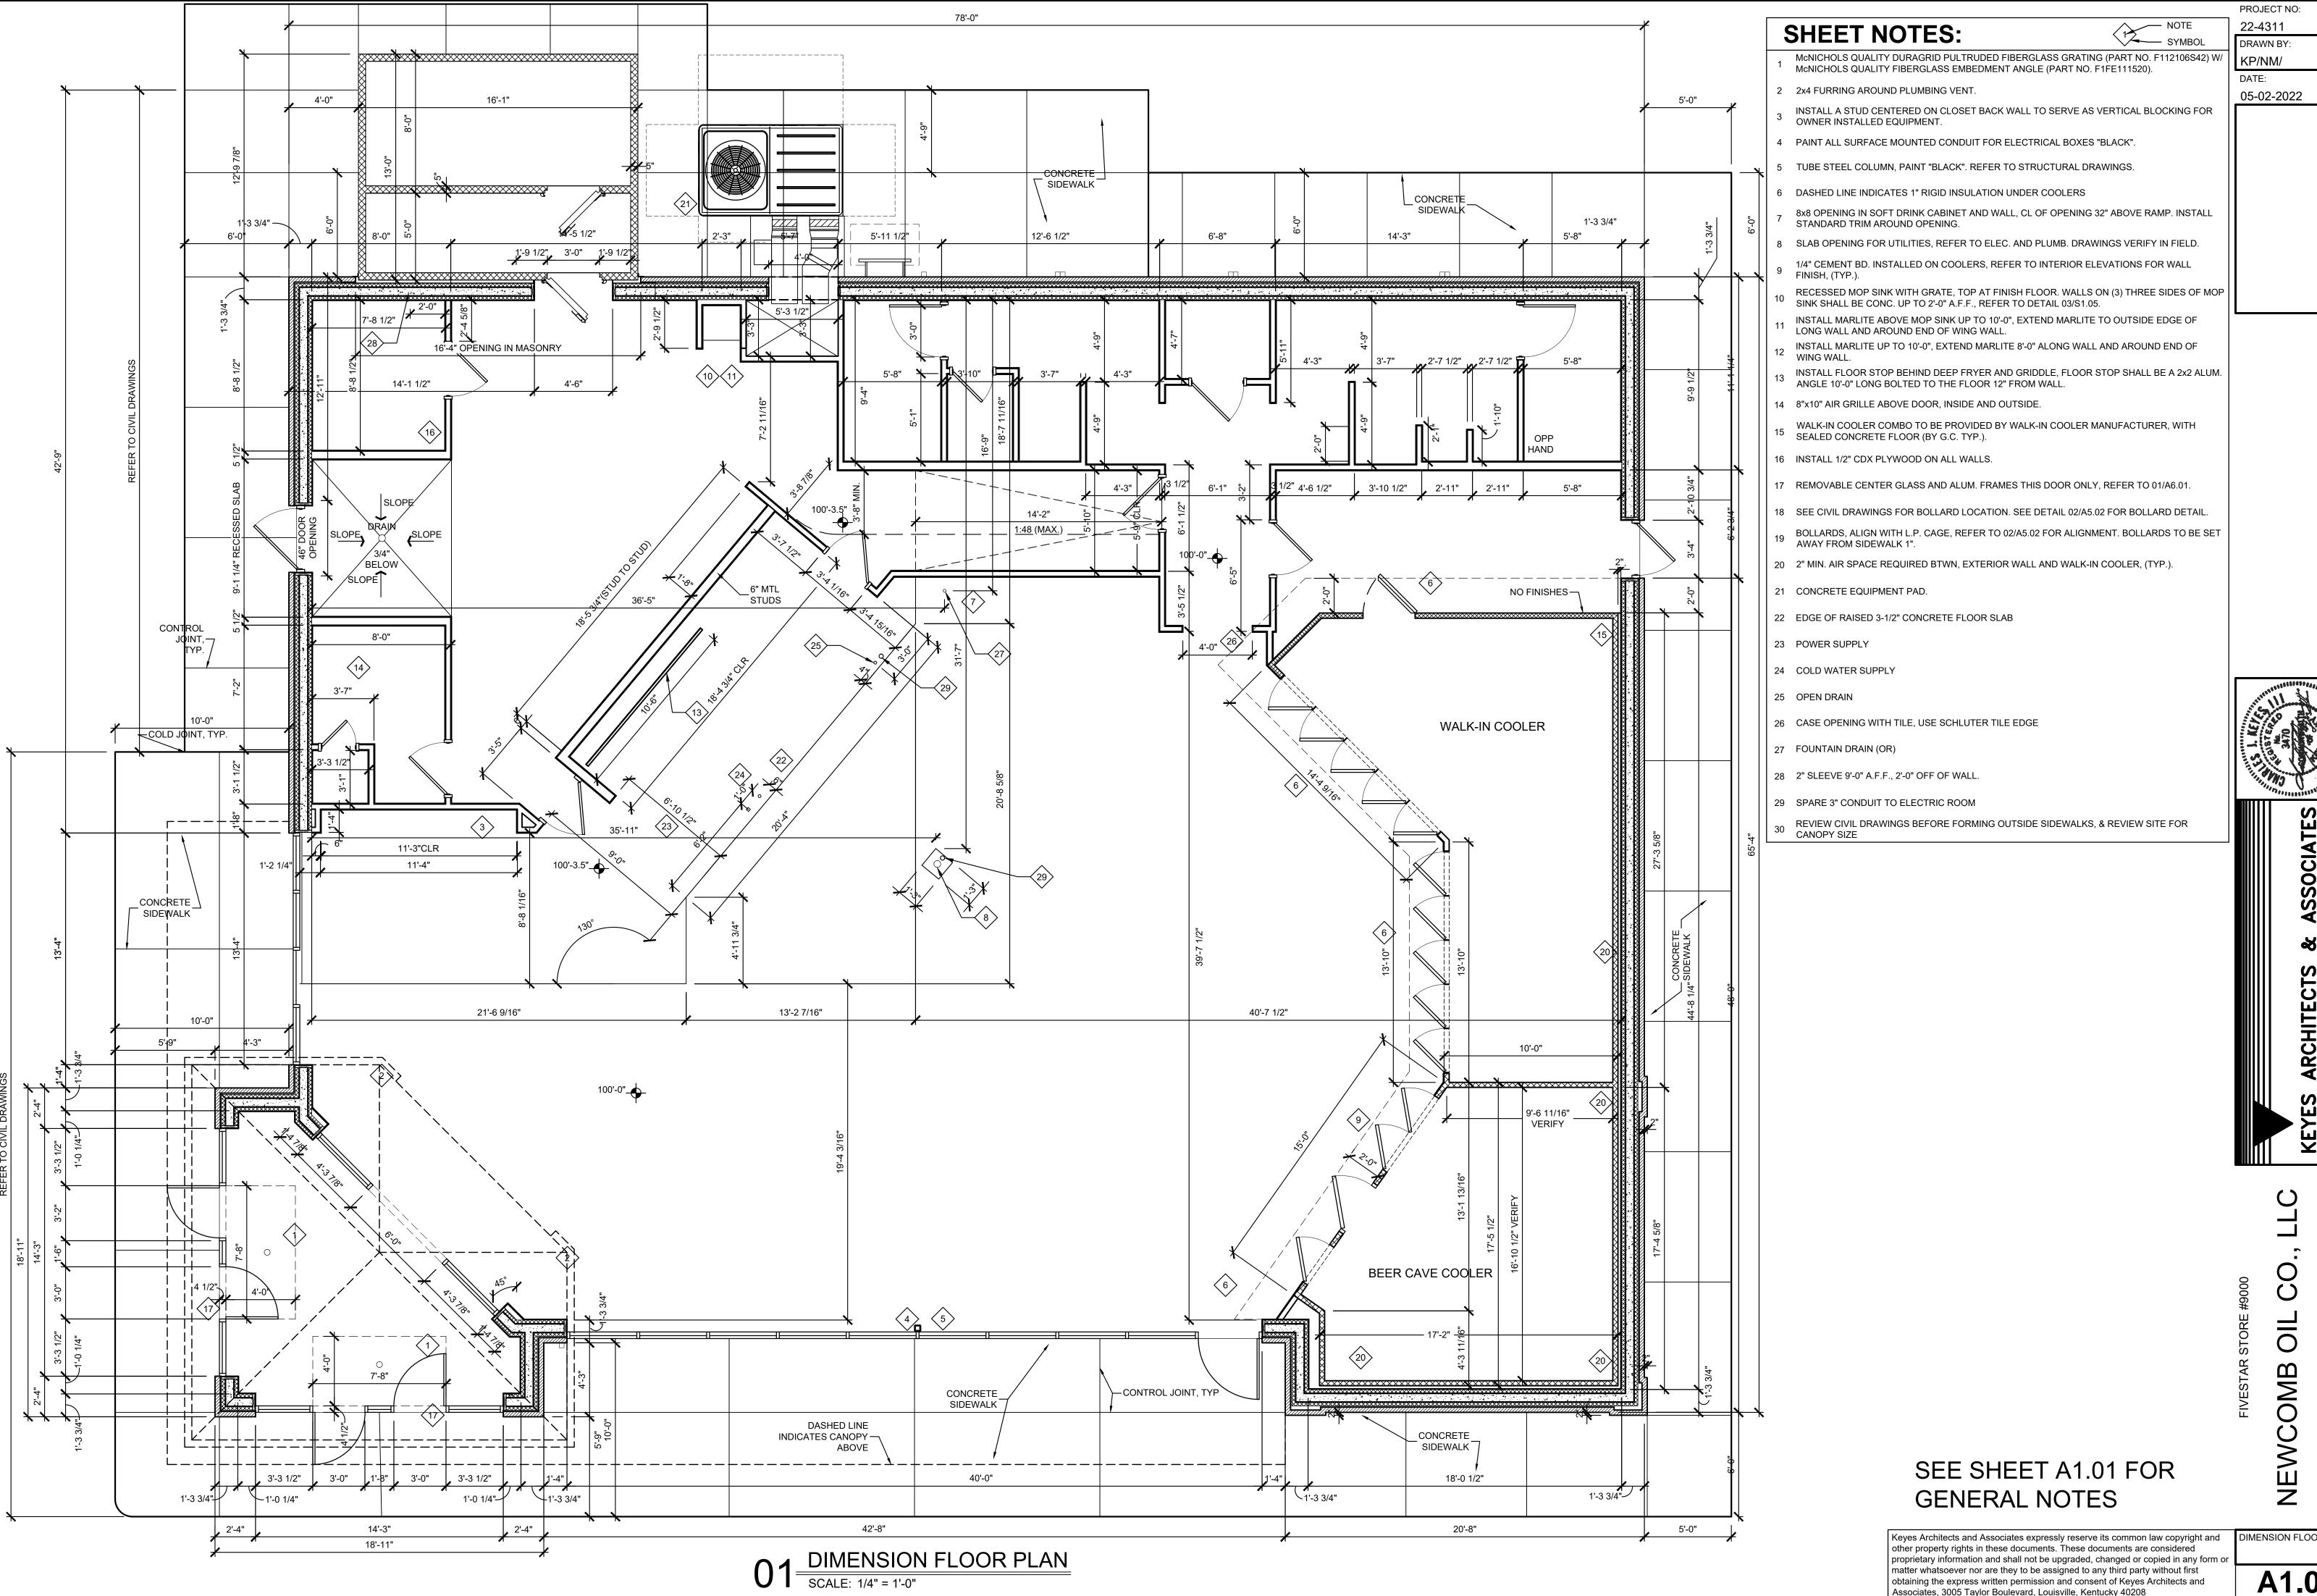


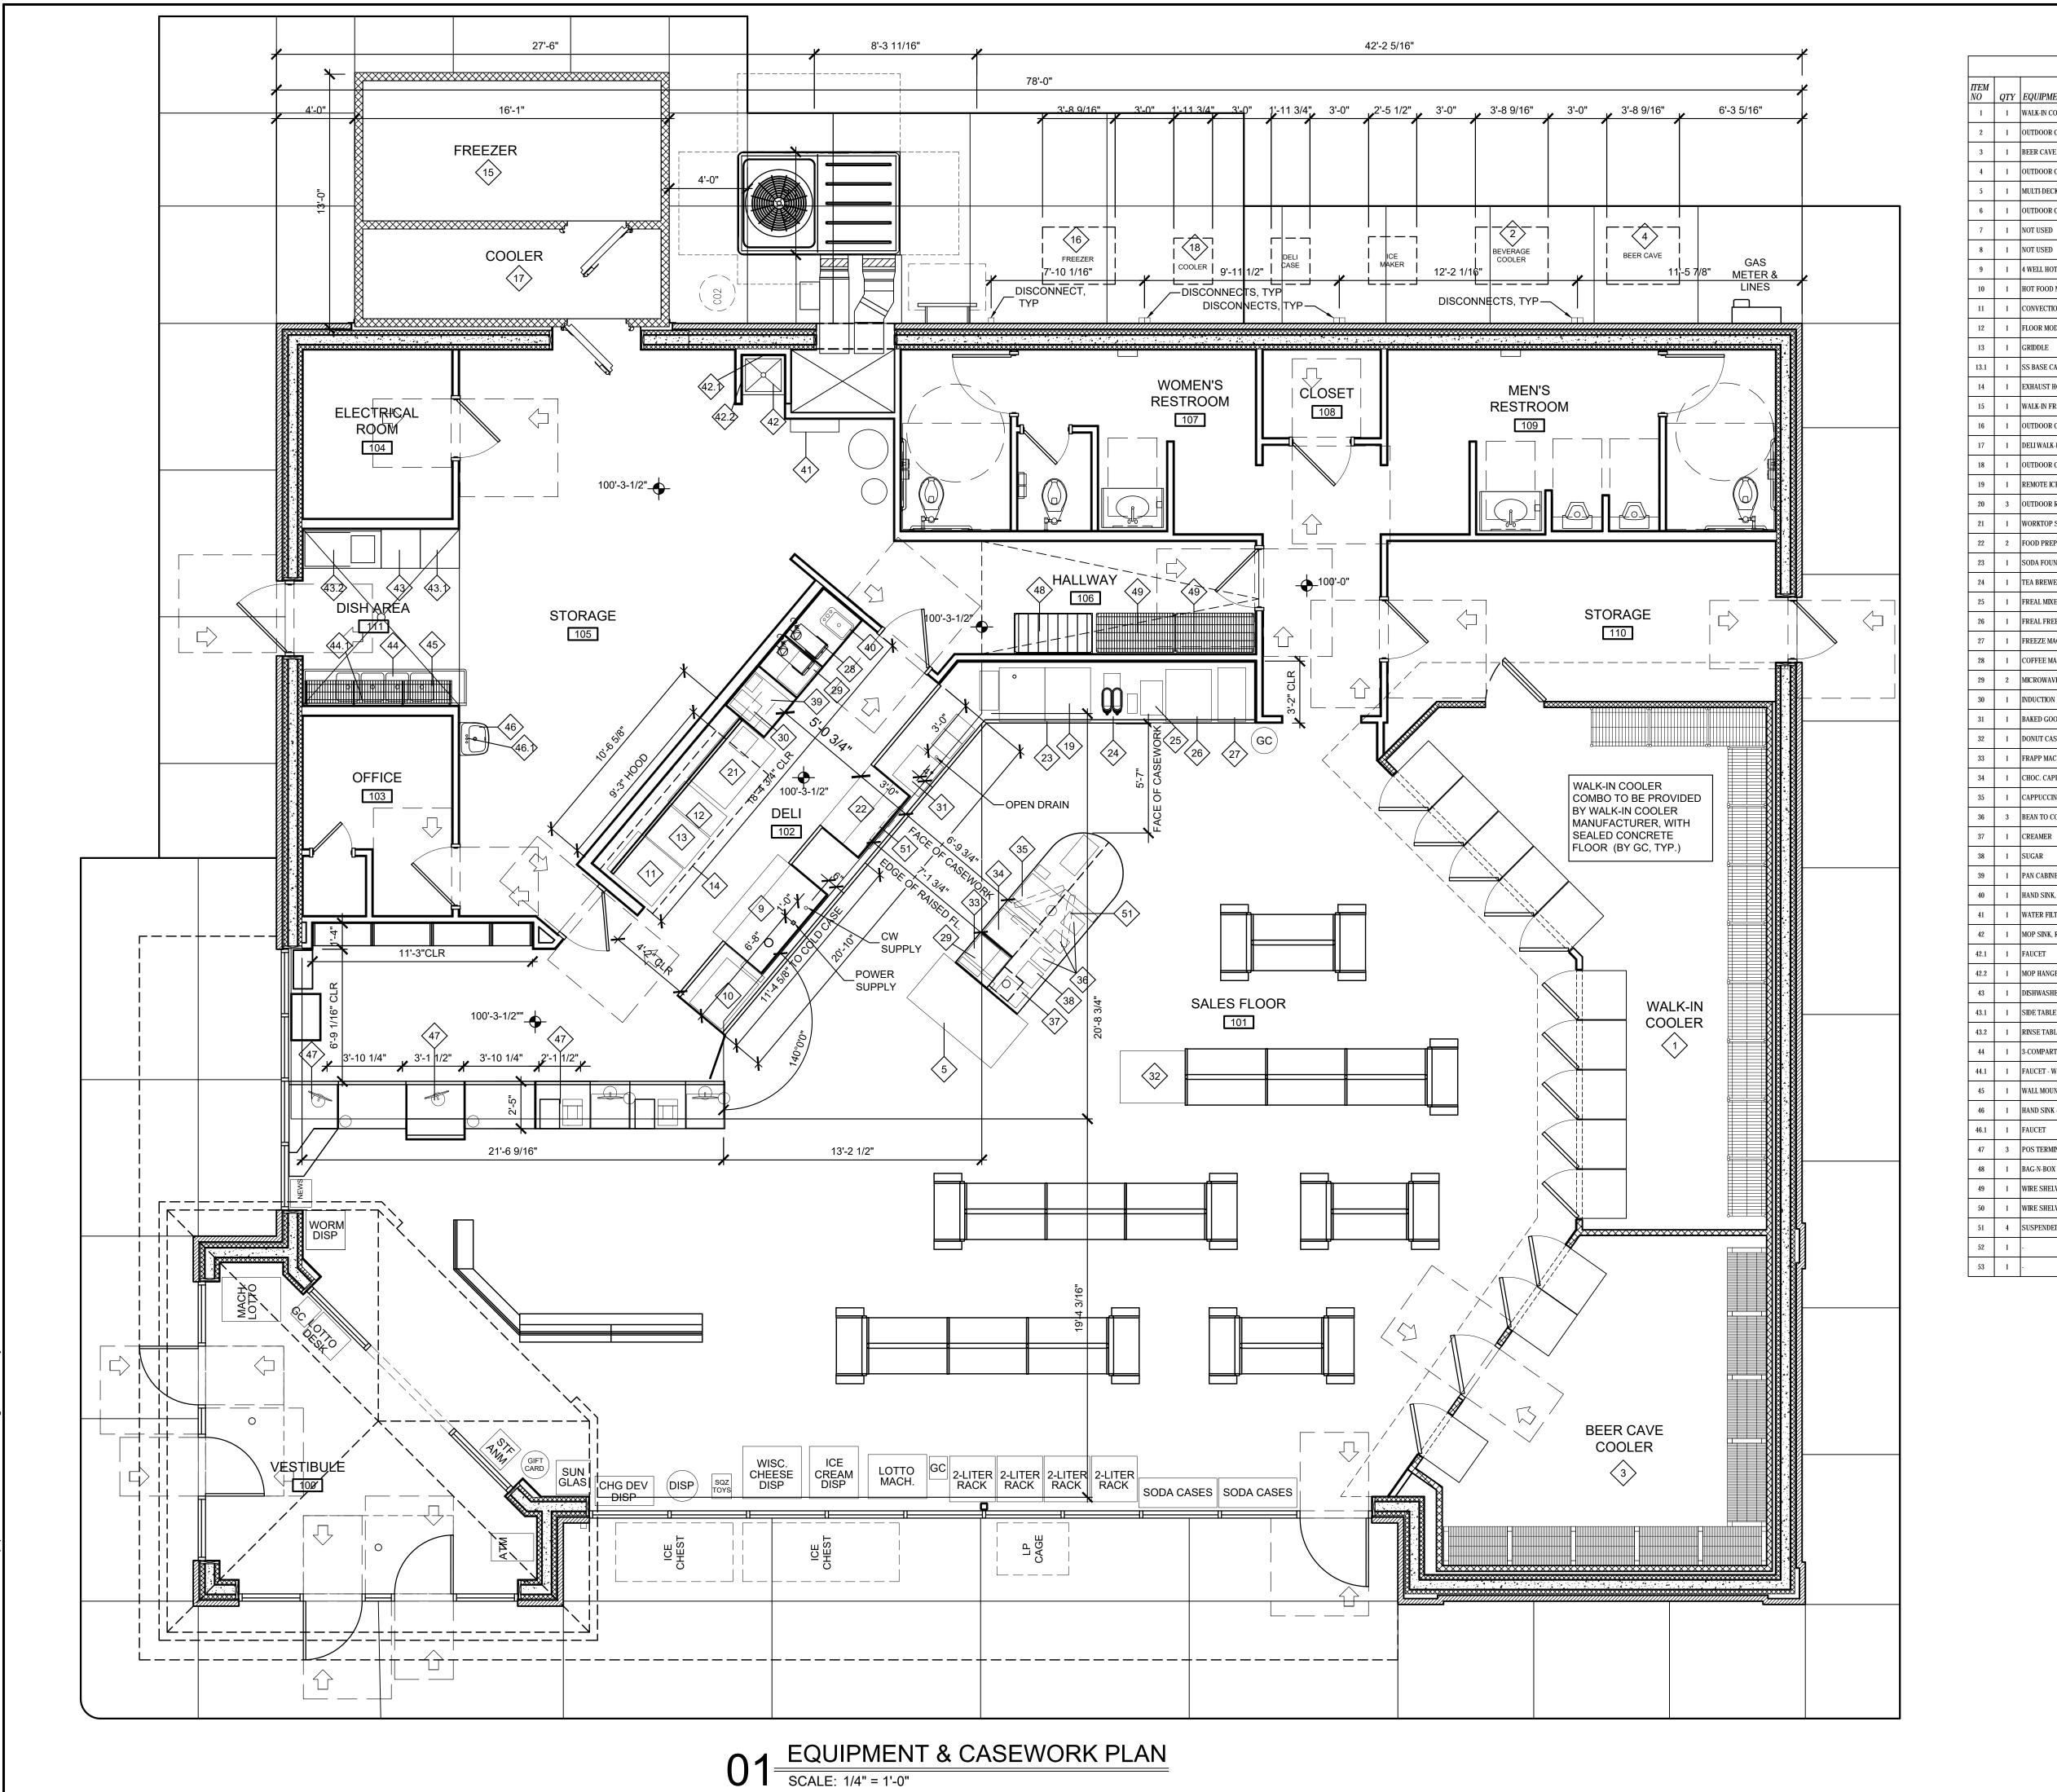
NOTE: ALL DIMENSIONS ARE TO FACE OF STUD

NOTE: GENERAL CONTRACTOR RESPONSIBLE FOR COORDINATION OF ALL SUB TRADES AND REQUIREMENTS BY OWNER

NOTE: ELECTRICAL, HVAC AND PLUMBING TO BE RELOCATED PER FEDERAL, STATE AND LOCAL CODES. GENERAL CONTRACTOR TO COORDINATE.

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EQUIPMENT SCHEDULE MANUFACTURER OFOI OFCI CFCI MODEL NUMBER WALK-IN COOLER OUTDOOR CONDENSING UNIT BEER CAVE WALK-IN COOLER OUTDOOR CONDENSING UNIT MULTI-DECK ISLAND MERCHANDISER HUSSMAN 6 1 OUTDOOR CONDENSING UNIT 4 WELL HOT FOOD TABLE DELFIELD HOT FOOD MERCHANDISER 120V-1550 WATTS CONVECTION OVEN/WITH HOLDING CABINET W/ P8M PROOFER HOLDER FLOOR MODEL GAS FRYER SOLSTICE SG14 13.1 1 SS BASE CABINET W/ ROLLERS CAPTIVE AIRE EXHAUST HOOD WALK-IN FREEZER OUTDOOR CONDENSING UNIT DELI WALK-IN OUTDOOR CONDENSING UNIT REMOTE ICE MAKER (INSTALLED ON FOUNTAIN) SCOTSMAN N1322R-32A OUTDOOR REMOTE CONDENSER WORKTOP SOLID DOOR FREEZER TWT-48F-HC FOOD PREP TABLE TSSU-48-12 SODA FOUNTAIN TEA BREWER FREAL MIXER SINGLE DOOR FREEZER FREAL FREEZER FREEZE MACHINE TAYLOR CROWN 28 1 COFFEE MAKER MICROWAVE INDUCTION RANGE BAKED GOODS DONUT CASE ULTRA 2HP BLK FRAPP MACHINE 34 1 CHOC. CAPPU MACHINE CAPPUCCINO MACHINE 36 3 BEAN TO COFFEE 2 HEAD DISPENSER PERFECT SERVINGS POWDER DISPENSER 39 1 PAN CABINET HAND SINK, INTERGAL WITH COUNTERTOP WATER FILTER CSR QUAD-MC SYSTEM MOP SINK, RECESSED MOP HANGER DISHWASHER SIDE TABLE RINSE TABLE - INTREGAL SINK W/DISPOSAL 3-COMPARTMENT SINK JOHN BOOS 3B184-2D18-16GA FAUCET - WALL MOUNTED WITH 12" SWING EAGLE - METAL MASTERS GWB1436VG WALL MOUNT SHELVING (14" X 36") MANSFIELD GRAND ISLE HAND SINK - WALL HUNG 2018HBNS VITREOUS CHINA RELIANT 3 - 7385.004 AMERICAN STANDARD POS TERMINALS BAG-N-BOX WIRE SHELVING (18" X 36") W/ROLLERS EAGLE - METAL MASTERS WIRE SHELVING (24" X 36") W/ROLLERS EAGLE - METAL MASTERS 4 SUSPENDED TV MONITORS

PROJECT NO: 22-4311

DRAWN BY:

05-02-2022

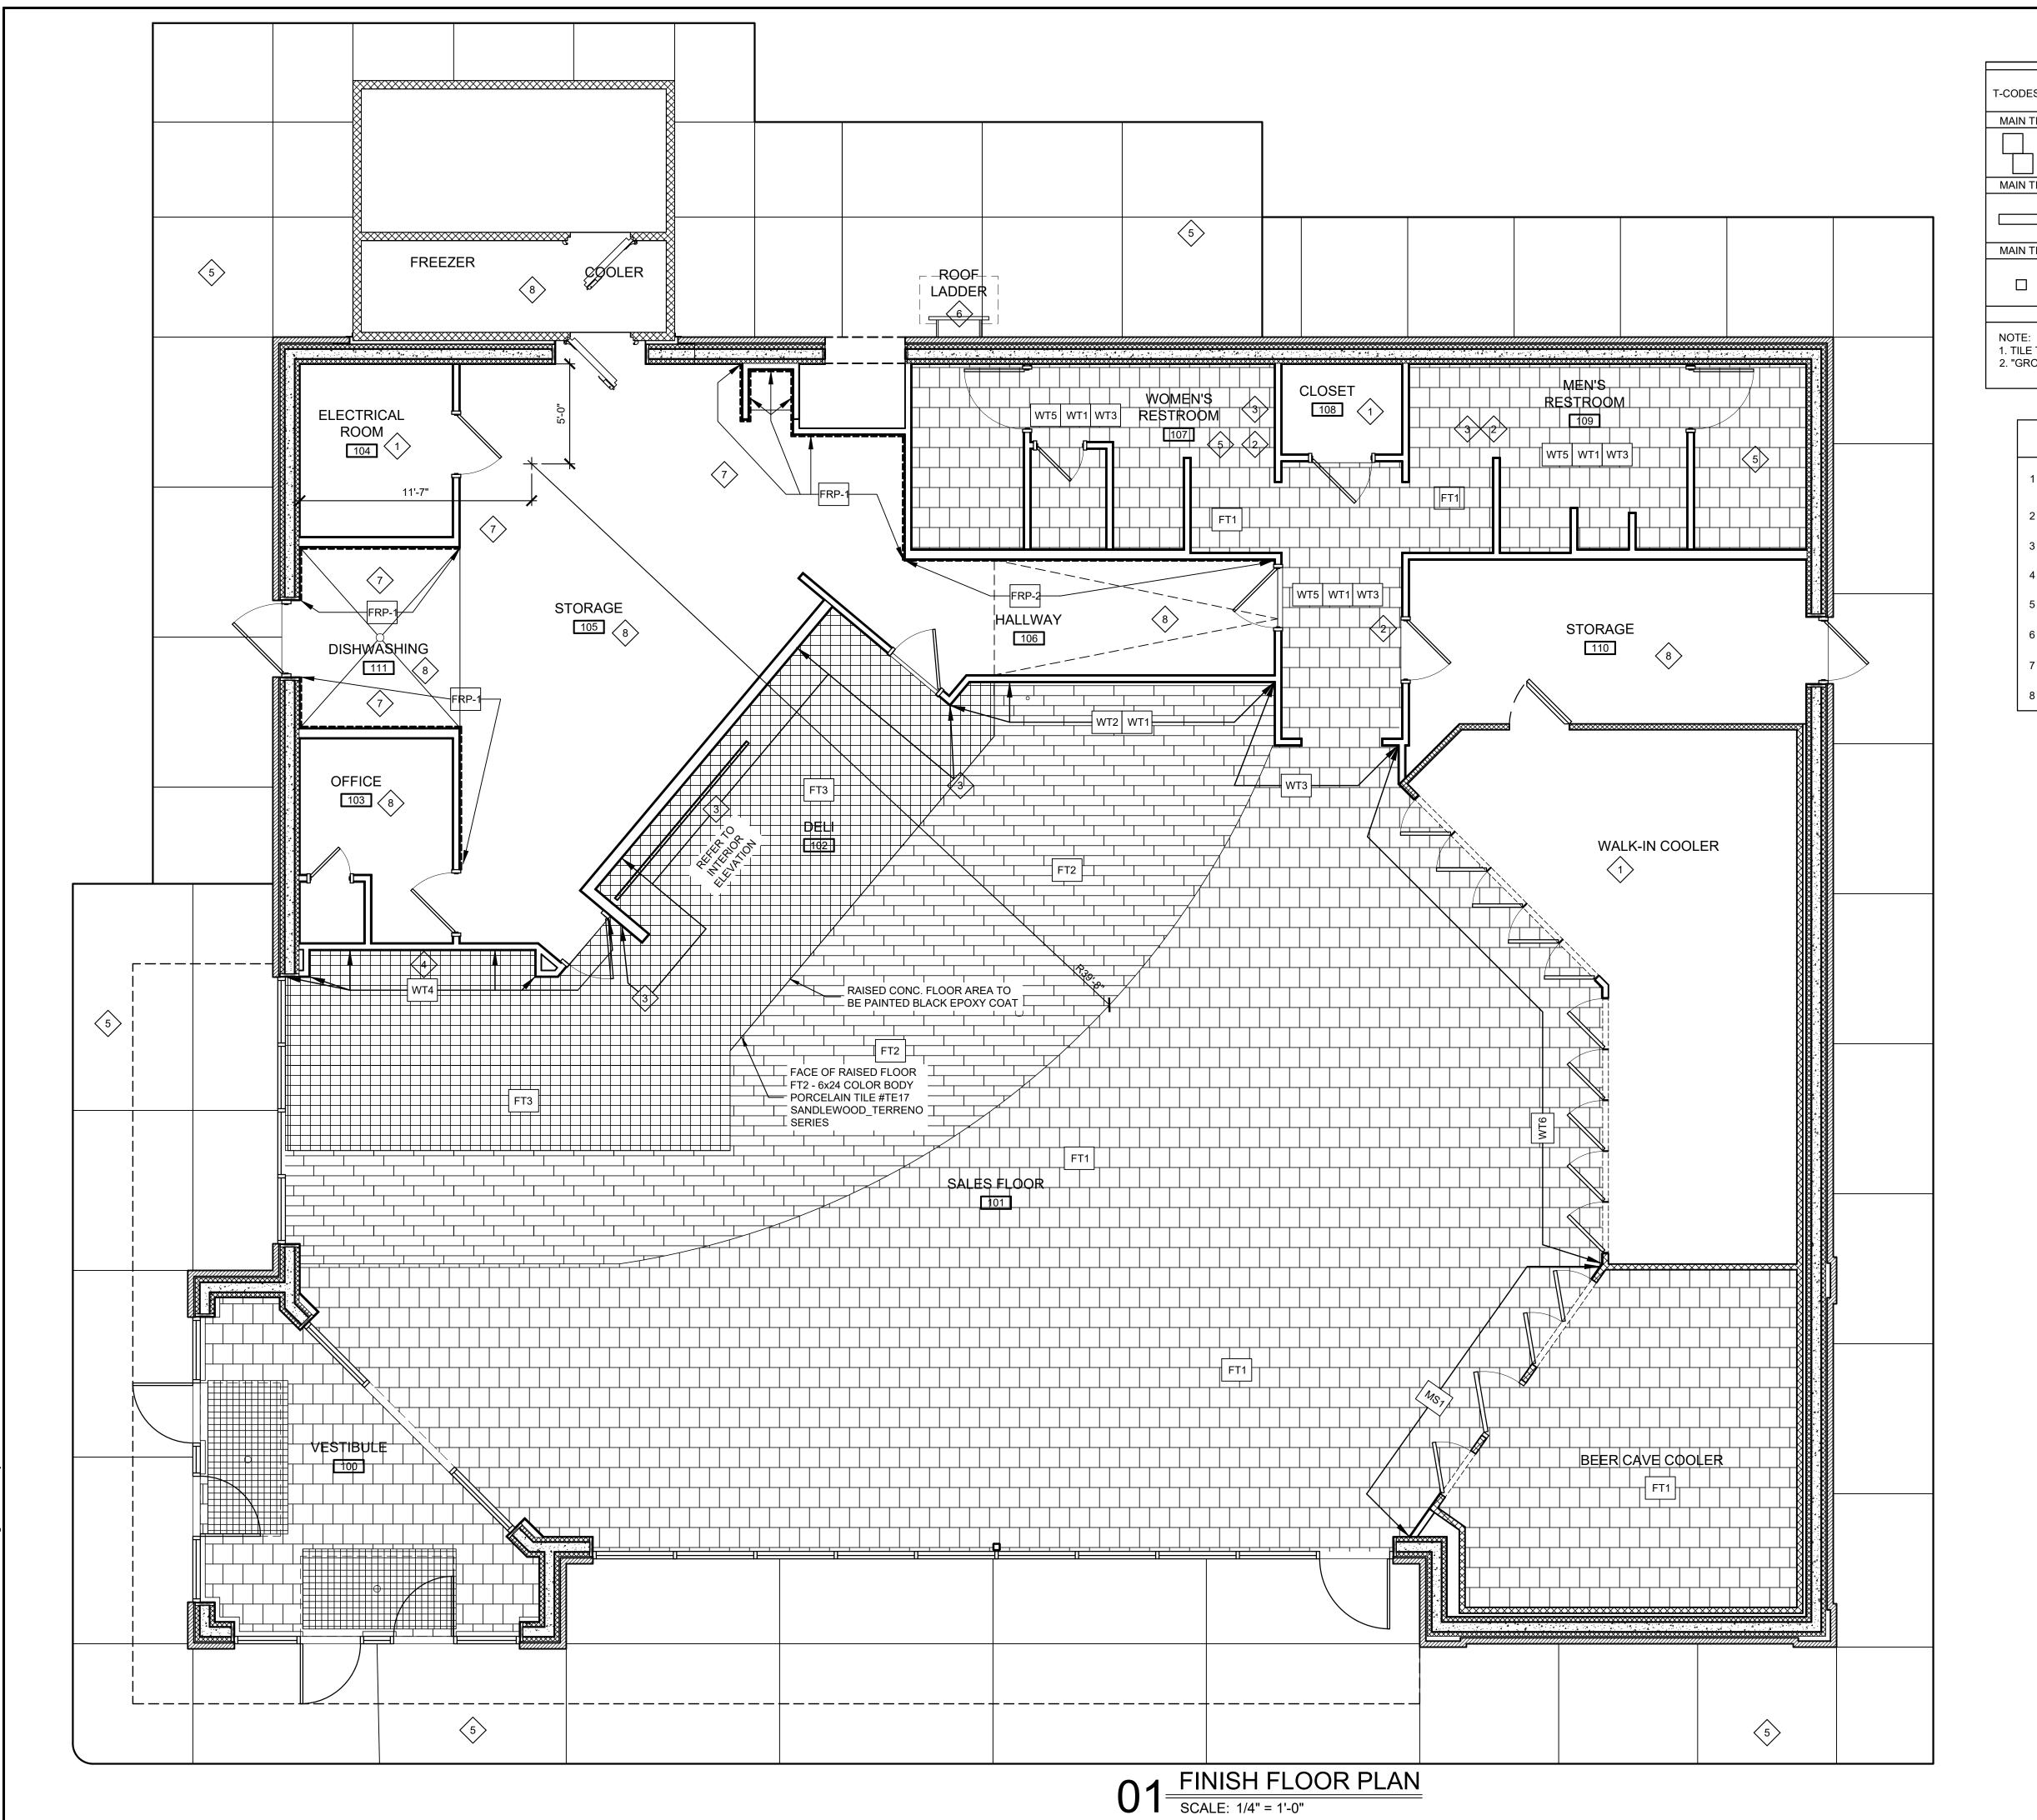
KP/NM/

DATE:

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CASEWORK PLAN

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FLOOR FINISH SCHEDULE

T-CODES = TILES USED ON FLOORS. WALL TILES MAY BE FOUND ON INTERIOR ELEVATIONS

MAIN TILE FIELD A -

FT1- 12 x 12 PORCELAIN STONE TILE / #VL78 - ACCENT BROWN WITH 3/16" GROUT LINES - BRICKWORK PATTERN WITH #145 LIGHT SMOKE SANDED

MAIN TILE FIELD B -

FT2- 6 X 24 COLORBODY PORCELAIN TILE / #HHO3 TEAK WITH 3/16" GROUT LINES - WITH #59 SADDLE BROWN SANDED GROUT.

MAIN TILE FIELD C -

FT3- 6 X 6 PAVER 0Q96 CHARCOAL STD 0Q96661P - WITH POLY LEND PLUS LIGHT SMOKE SANDED GROUT

1. TILE TO RUN CONTINUOUS UNDER CABINETS. 2. "GROUT BOOST" TO BE USED TO MIX GROUT INSTEAD OF WATER.

SHEET NOTES:

1 APPLY "MASTERKURE HD 200WB", ON FLOORS WHERE NOTED.

2 THROUGHOUT RESTROOM AREA, REFER TO INTERIOR ELEVATIONS FOR MORE INFORMATION.

3 REFER TO INTERIOR ELEVATIONS

4 NO TILE BEHIND SHELVING.

APPLY "MASTERKURE ND 200WB" TO ALL EXTERIOR SIDEWALKS, EQUIPMENT PADS AND DUMPSTER PADS.

6 PAINT ROOF LADDER.

7 PAINT WALL PER INTERIOR FINISH SCHEDULE - SEE A3.04 FOR MORE INFORMATION

8 EPOXY COATED FLOORS, WHERE NOTED.

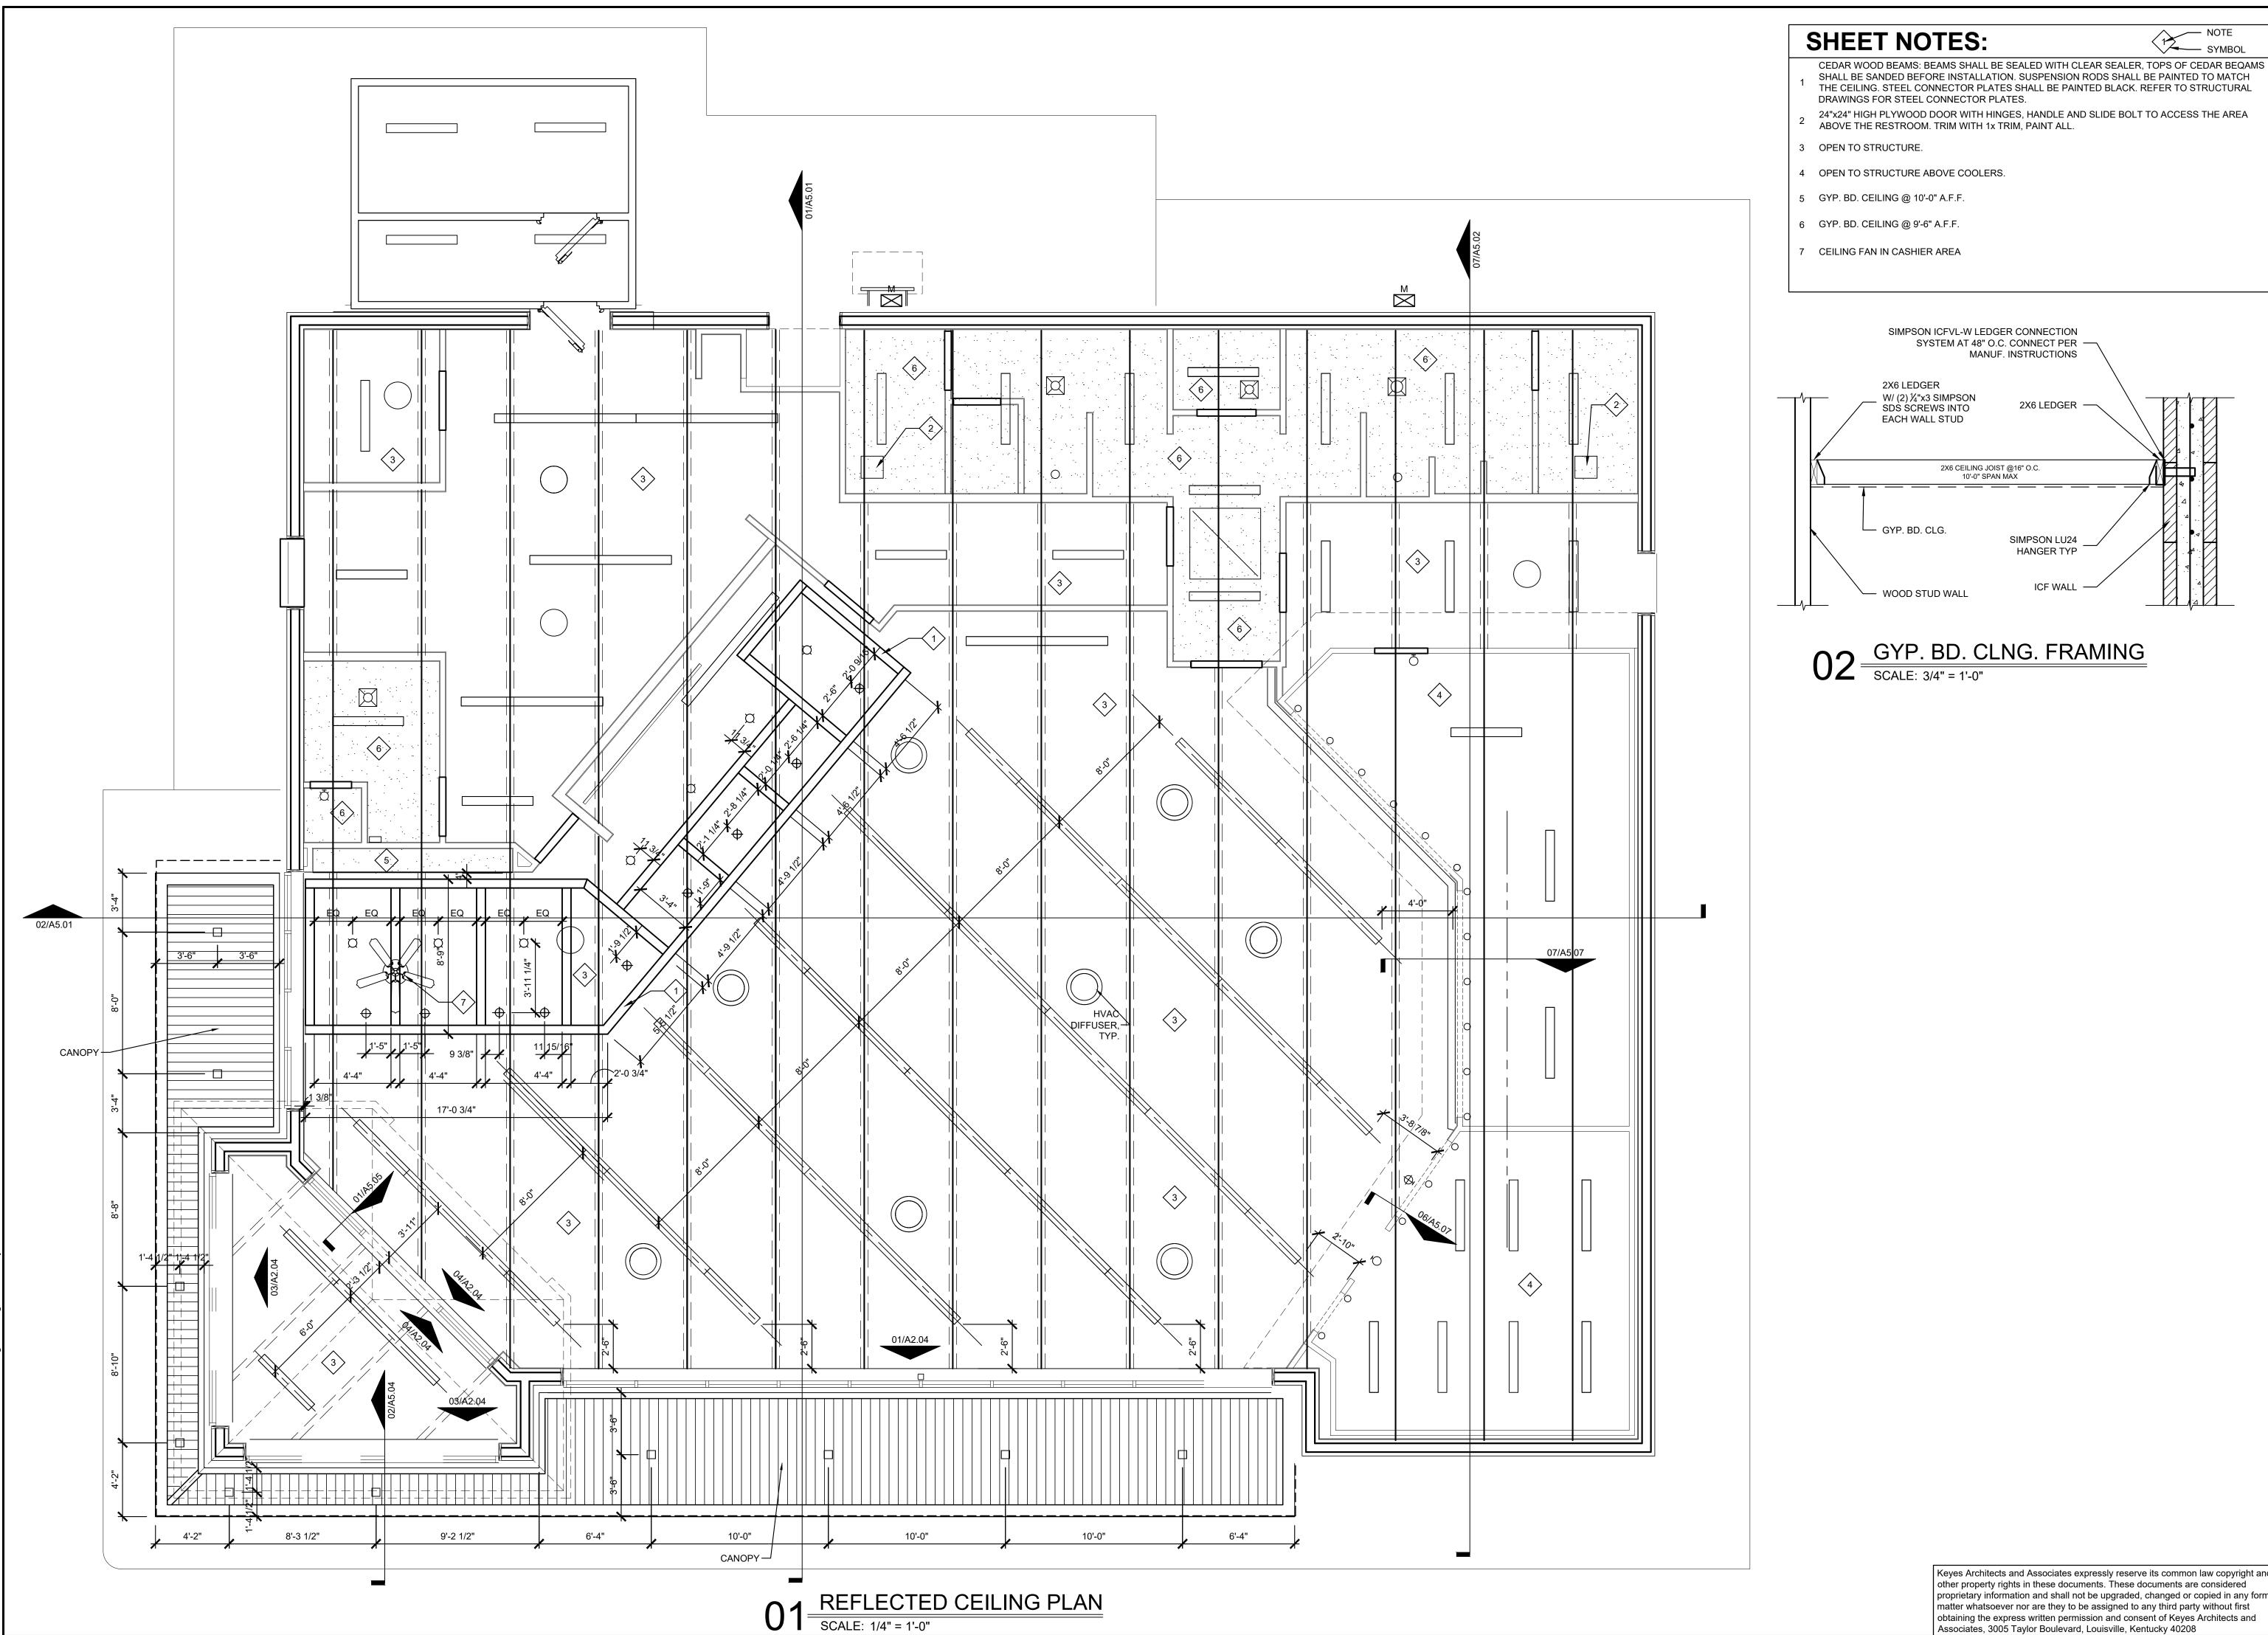
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SHEET NOTES:

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KP/NM/

PROJECT NO:

DATE: 05-02-2022

ABOVE THE RESTROOM. TRIM WITH 1x TRIM, PAINT ALL.

3 OPEN TO STRUCTURE.

4 OPEN TO STRUCTURE ABOVE COOLERS.

5 GYP. BD. CEILING @ 10'-0" A.F.F.

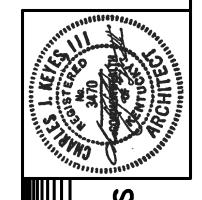
6 GYP. BD. CEILING @ 9'-6" A.F.F.

7 CEILING FAN IN CASHIER AREA

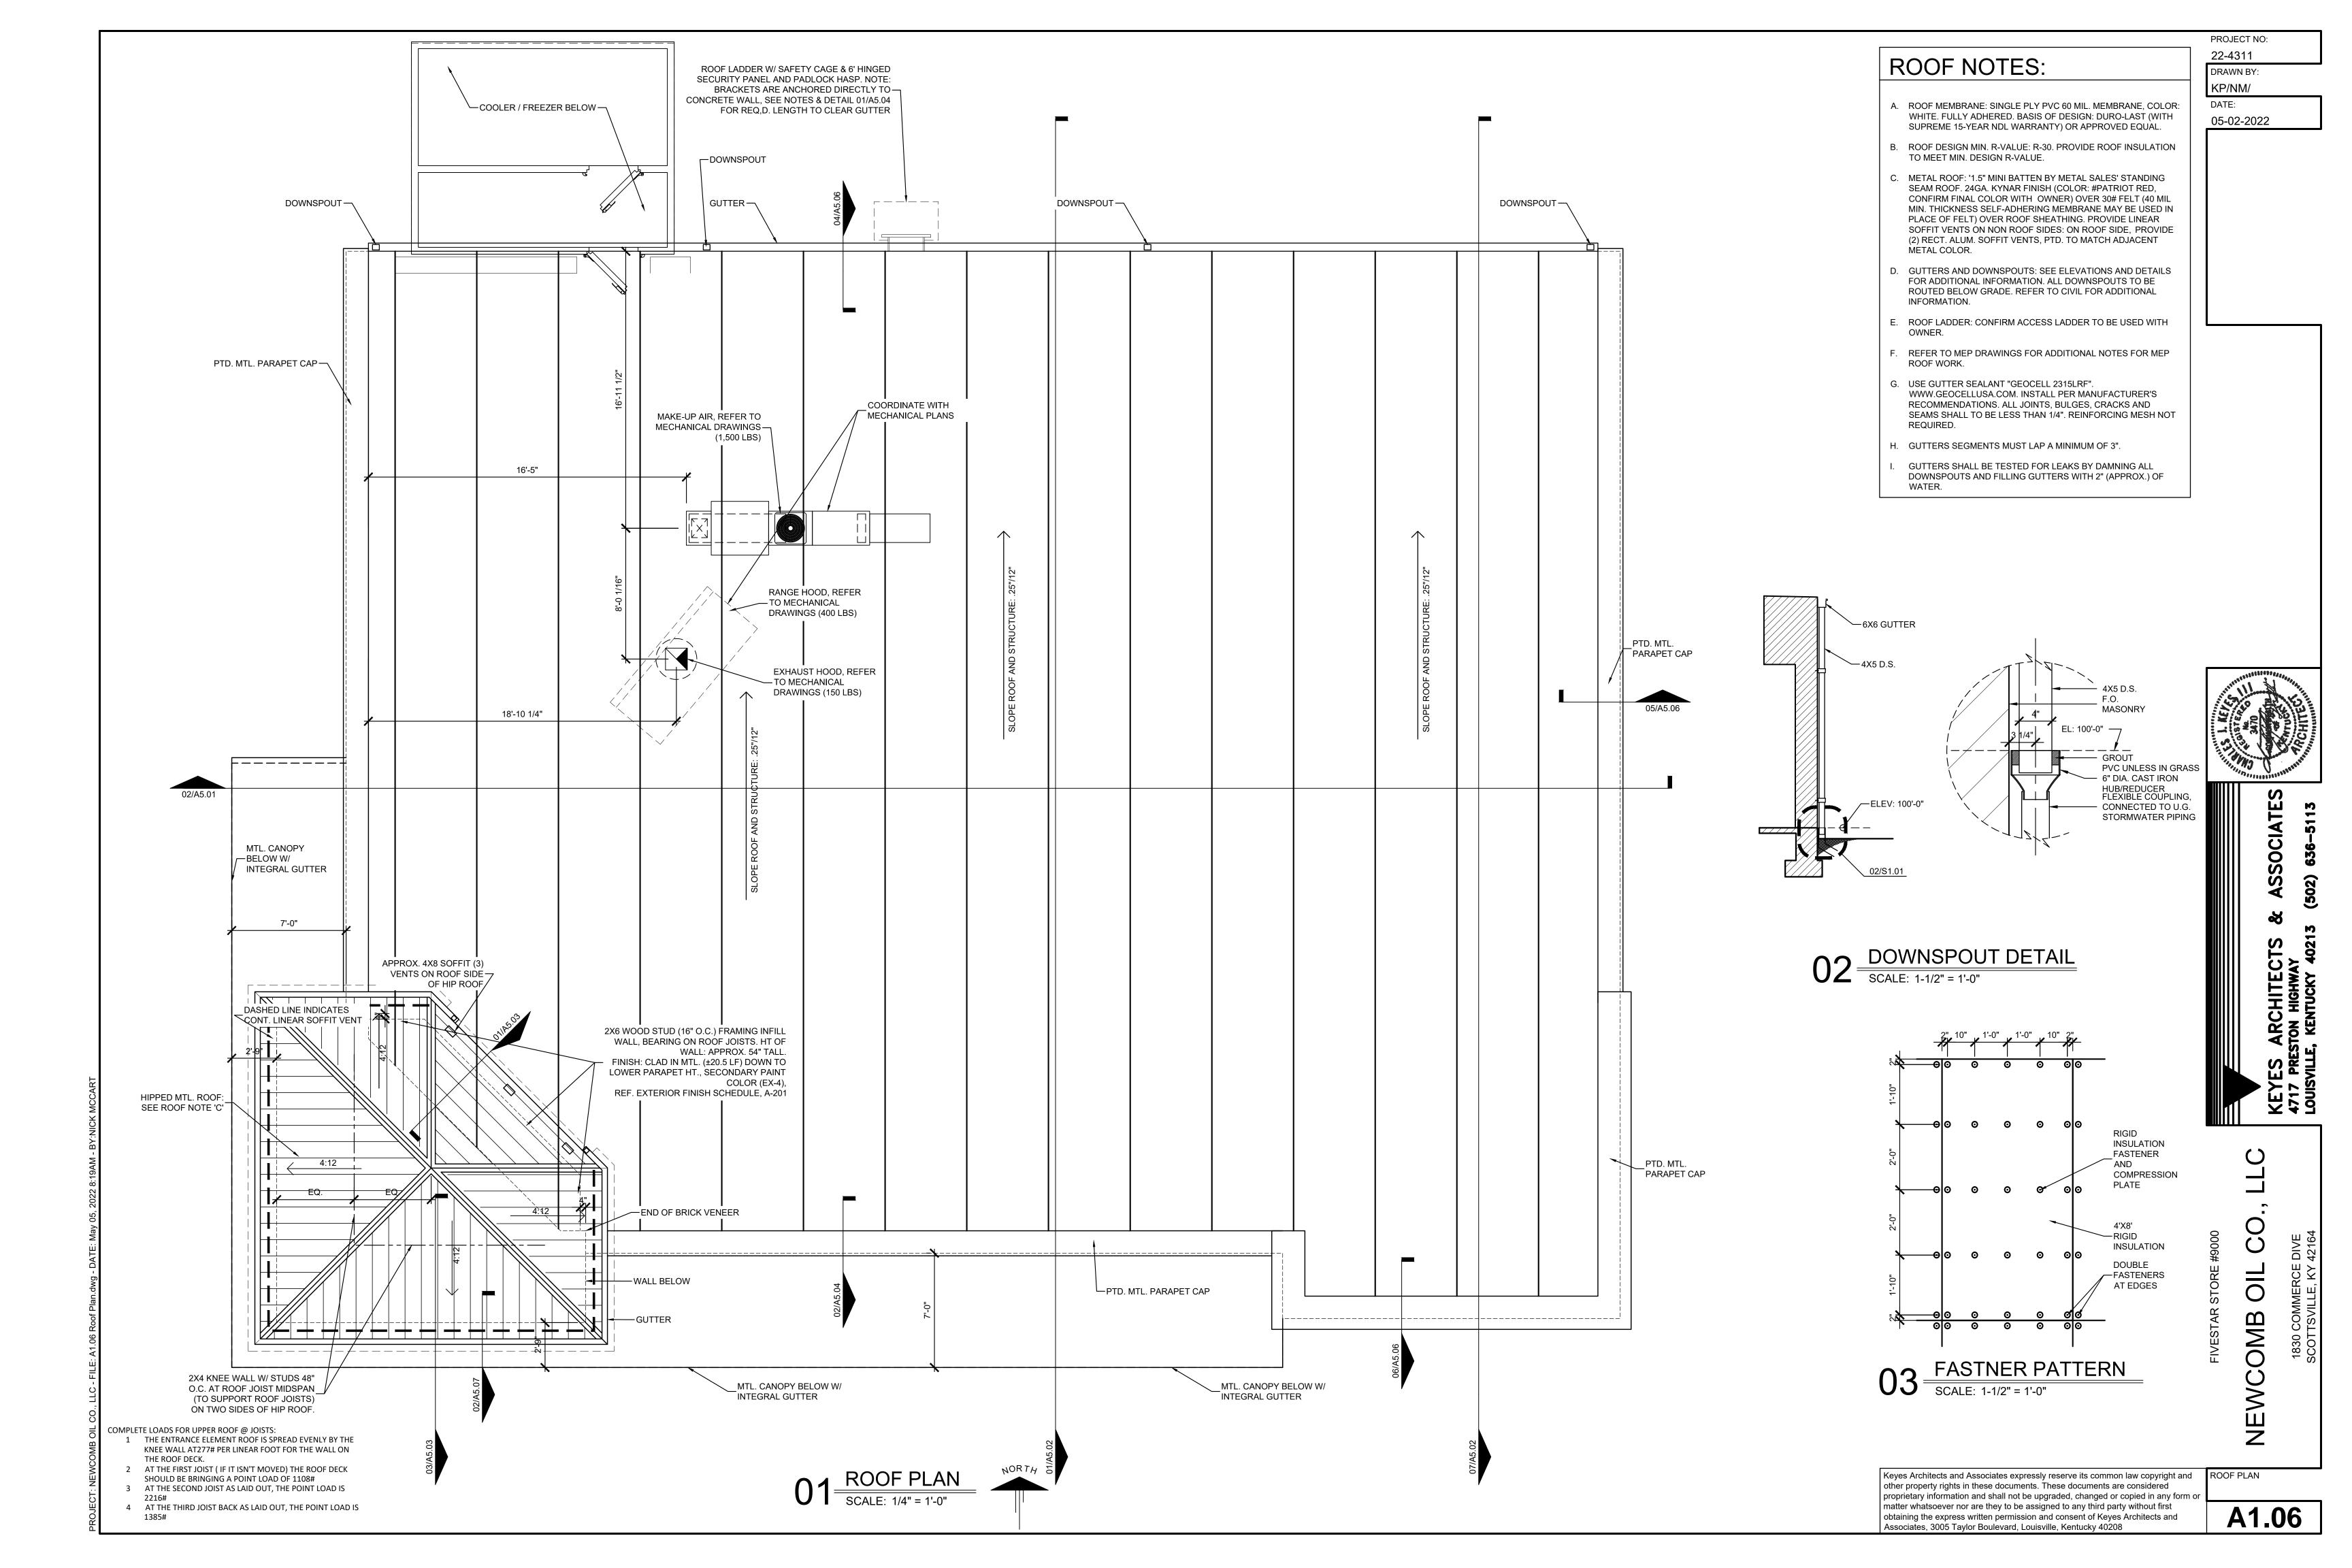
SIMPSON ICFVL-W LEDGER CONNECTION SYSTEM AT 48" O.C. CONNECT PER — MANUF. INSTRUCTIONS 2X6 LEDGER W/ (2) 1/4"x3 SIMPSON 2X6 LEDGER — SDS SCREWS INTO EACH WALL STUD 2X6 CEILING JOIST @16" O.C. 10'-0" SPAN MAX — GYP. BD. CLG. SIMPSON LU24 HANGER TYP ICF WALL -V WOOD STUD WALL

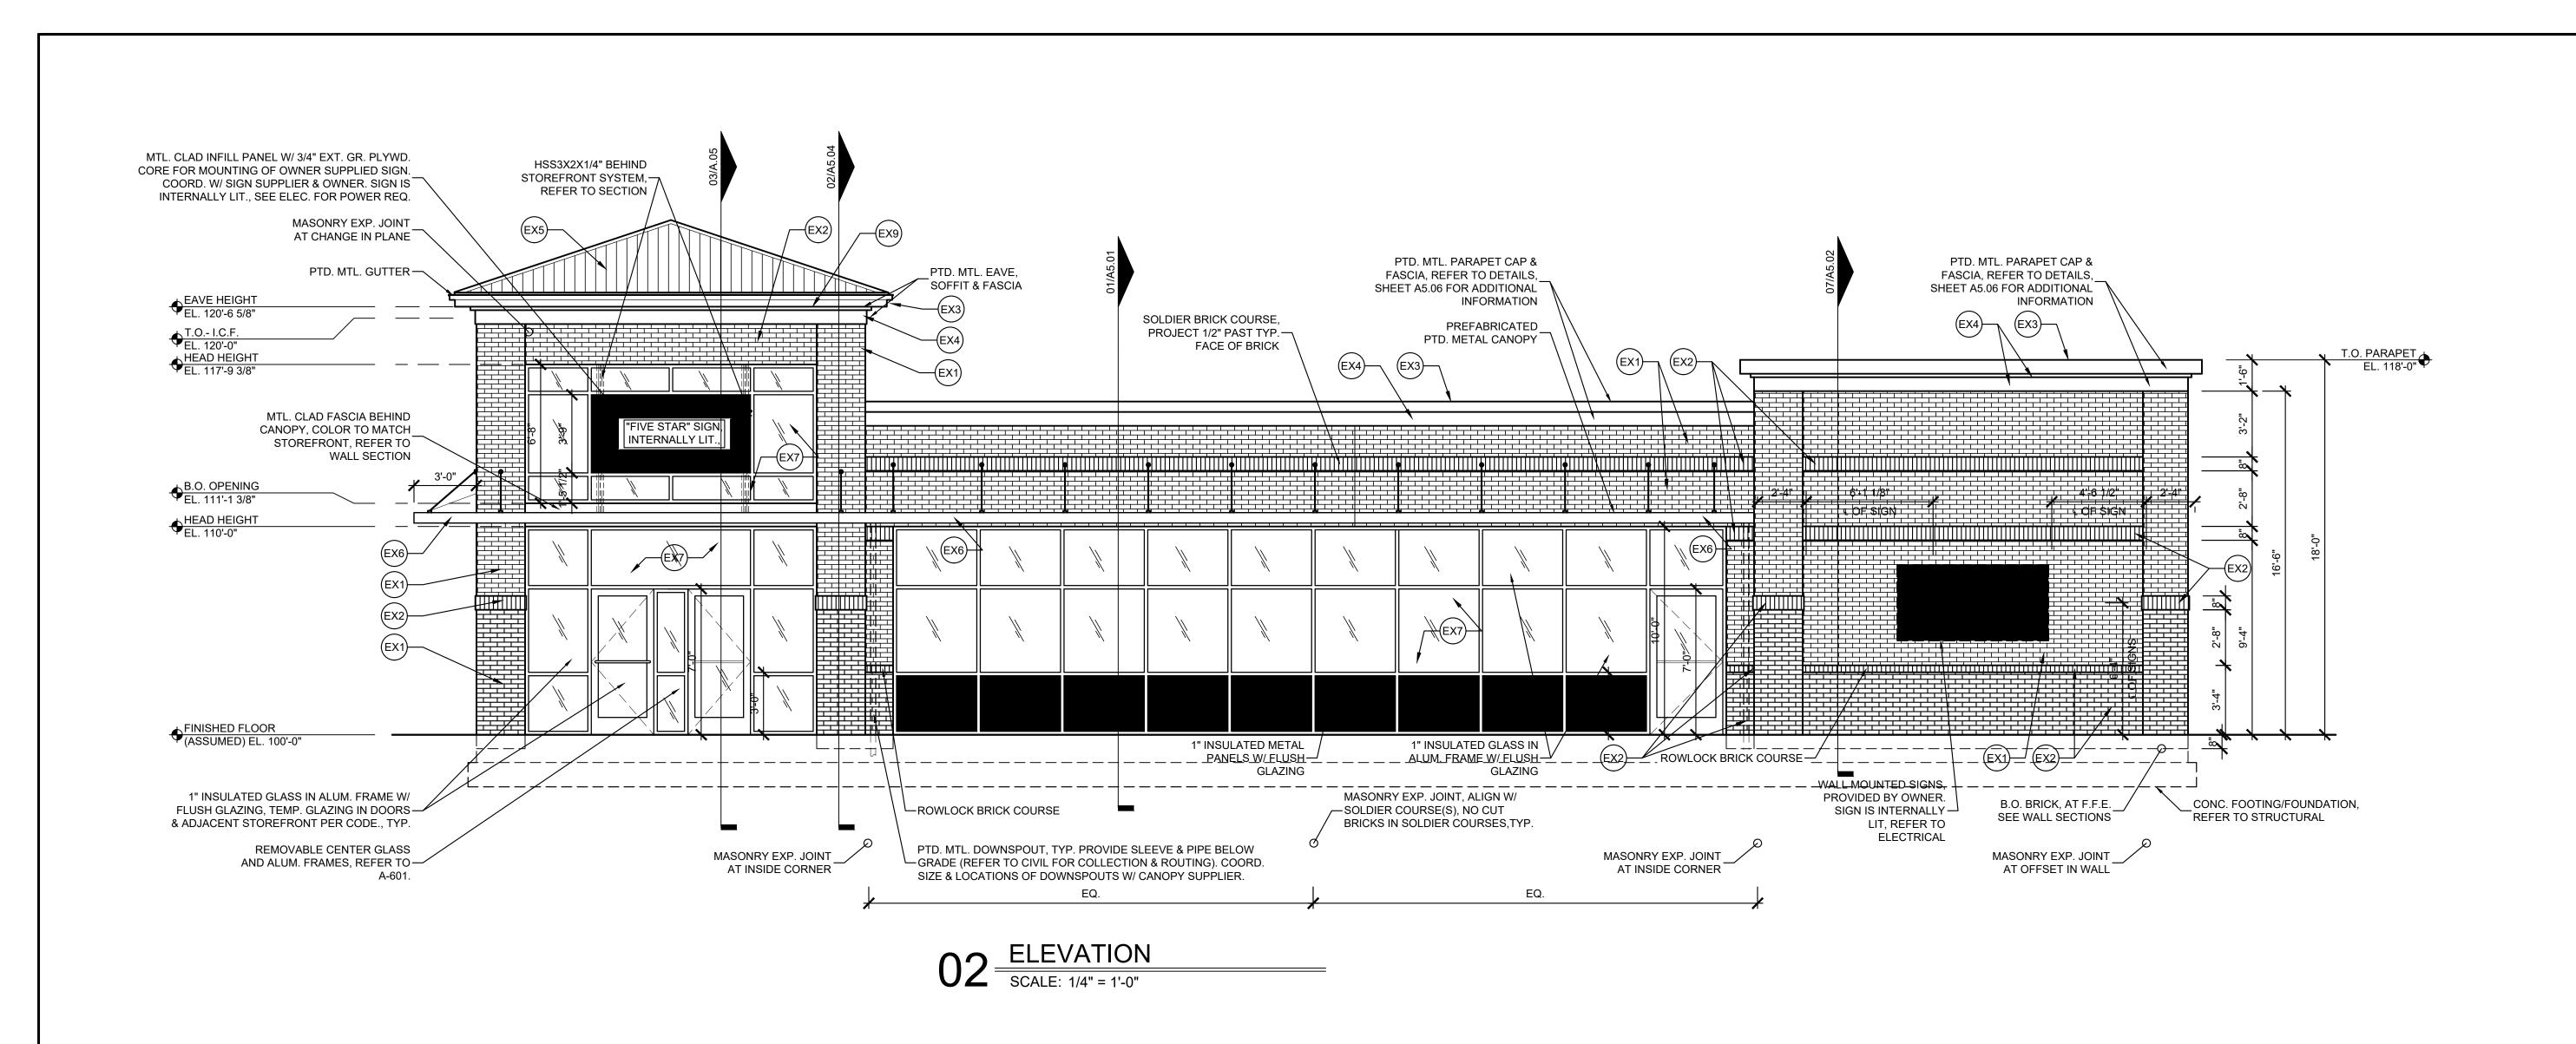
O2 GYP. BD. CLNG. FRAMING

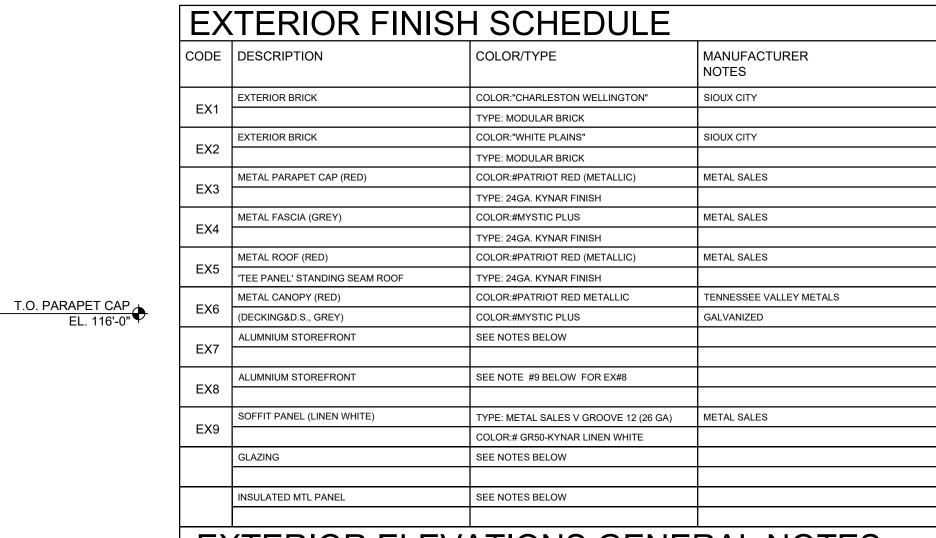
SCALE: 3/4" = 1'-0"



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EXTERIOR ELEVATIONS GENERAL NOTES

- PROVIDE LOW WEEP VENTS IN VENEER MASONRY, 24" O.C. MAX. USE 3/8" HONEYCOMB VENT MASONRY EXPANSION JOINTS: PROVIDE SANDED SEALANT (MATCH MORTAR) W/ COMPRESSIBLE BACKER. SEALANT TO COMPLY W/ ASTM C290,
- CLASS 50 SPECIFICATIONS.
- SIGNAGE: COORDINATE SIGN SIZE, POWER REQUIREMENTS, AND LAYOUT WITH SUPPLIER PRIOR TO INSTALLATION OF STOREFRONT. CANOPY: REFER TO STRUCTURAL FOR REQUIRED LOADING. CANOPY & DOWNSPOUTS SHOWN FOR REFERENCE. FINAL DESIGN & DETAILING BY CANOPY SUPPLIER. SUBMIT TO OWNER FOR APPROVAL.
- 6. ALL DOWNSPOUTS TO BE SLEEVED AND ROUTED BELOW GRADE. COORDINATE WITH CIVIL FOR COLLECTION AND MANAGEMENT OF WATER ON SITE.
 GUTTERS SHALL BE TESTED FOR LEAKS BY DAMNING ALL DOWNSPOUTS AND FILLING GUTTERS WITH 2" (APPROX.) OF WATER.
- REFER TO FINISH SCHEDULE FOR HM DOOR AND FRAME PAINT COLORS.
- BOTTOM ALUMINUM SILL SHALL MEASURE 4-13/16" INSTEAD OF 2-1/4". THIS IS TO ALLOW THE TILE ON THE RAISED FLOOR TO BUTT UP AGAINST THE SILL INSTEAD OF HAVING A TILE/GAP ISSUE.

ALUMINUM STOREFRONT: AS MANUFACTURED BY TRULITE
2" X 4-1/2" THERMALLY BROKEN, DARK BRONZE ANODIZED, CENTER GLAZED

STABILIZERS, EXPANDED POLYSTYRENE FOAM (EPS) CORE 5/8"

PROVIDE MATERIAL COLOR & FINISH SAMPLES FOR APPROVAL (BY OWNER)

FREEZER/

CONC. FOOTING/FOUNDATION,

REFER TO STRUCTURAL

COOLER BEYOND

FINISHED FLOOR (ASSUMED) EL. 100'-0"

INSULATED GLASS:
1" INSULATED, SOLAR BRONZE, (HEAT STRENGTHENED) OVER "GUARDIAN SUNGUARD SN-68". FULLY TEMPERED BOTH LIGHTS AS REQUIRED BY CODE.

INSULATED PANELS:
1" INSULATED, DARK BRONZE, "CITADEL GLAZEGUARD 1000 WR", • PRE-FINISHED TEXTURED ALUMINUM SKINS .010", HIGH DENSITY POLYPROPYLENE

SOLDIER BRICK COURSE,

OF BRICK

MASONRY EXP. JOINT

PROJECT 1/2" PAST TYP. FACE ___ PTD. MTL. PARAPET CAP & FASCIA --

B.O. BRICK, 8" BELOW

ADJACENT GRADE, MIN.—

SEE WALL SECTIONS

MTL. WALL PANEL CLADDING ON THIS ELEVATION/AREA, SEE WALL

—PTD. HIPPED MTL. ROOF BEYOND

-- PTD. MTL. PARAPET CAP & FASCIA

EX4

__ROWLOCK BRICK COURSE_ __ _ _ _ _ _ _ _ _ _

MASONRY EXP. JOINT-

SOLDIER BRICK COURSE,

-PROJECT 1/2" PAST TYP.

FACE OF BRICK

LIGHT FIXTURE, REFER TO

ROWLOCK BRICK COURSE

MASONRY EXP. JOINT

AT OFFSET IN WALL

CORNER BRICK, PROJECT 2"

PAST TYP. FACE OF BRICK

MASONRY EXP. JOINT

AT OFFSET IN WALL

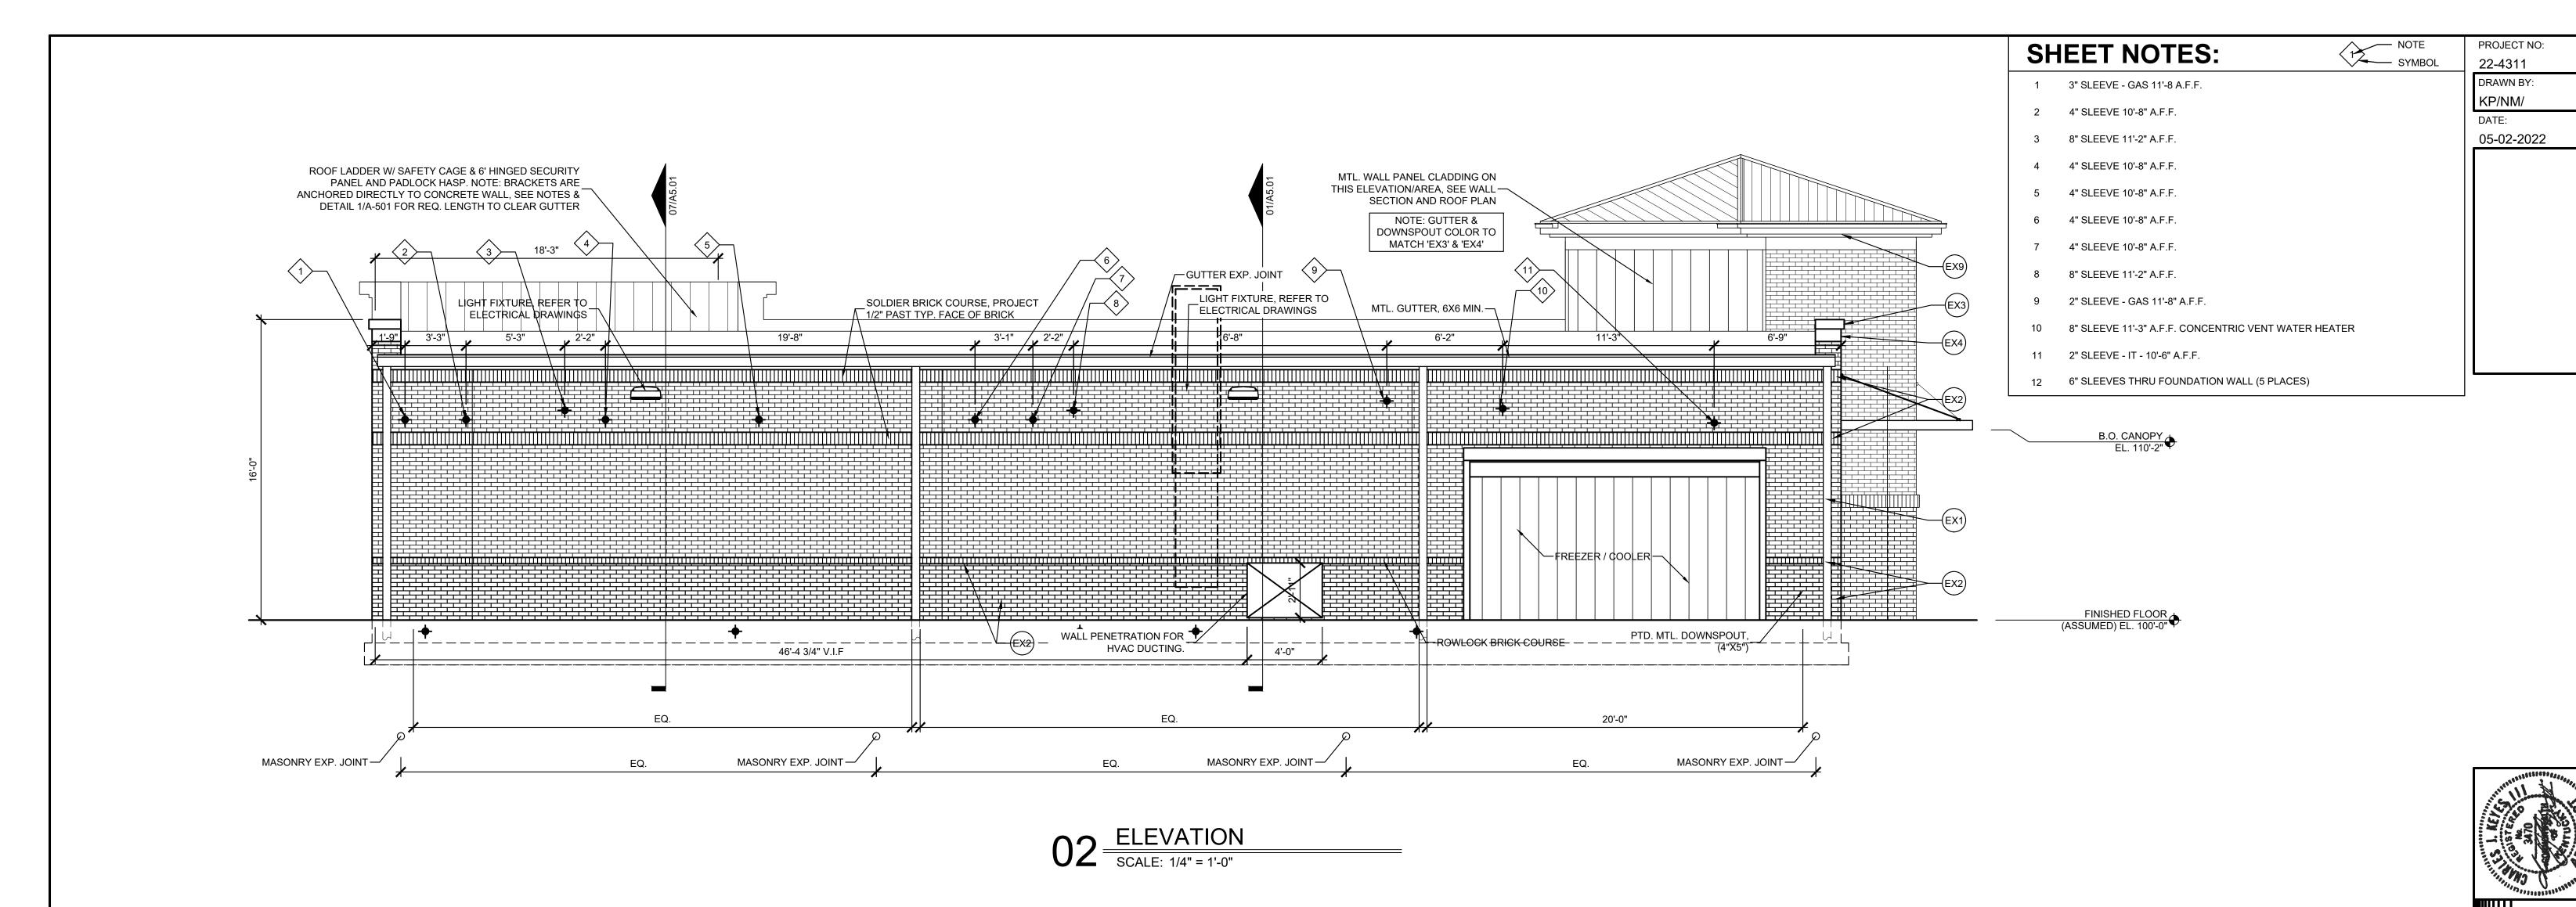
ELECTRICAL DRAWINGS

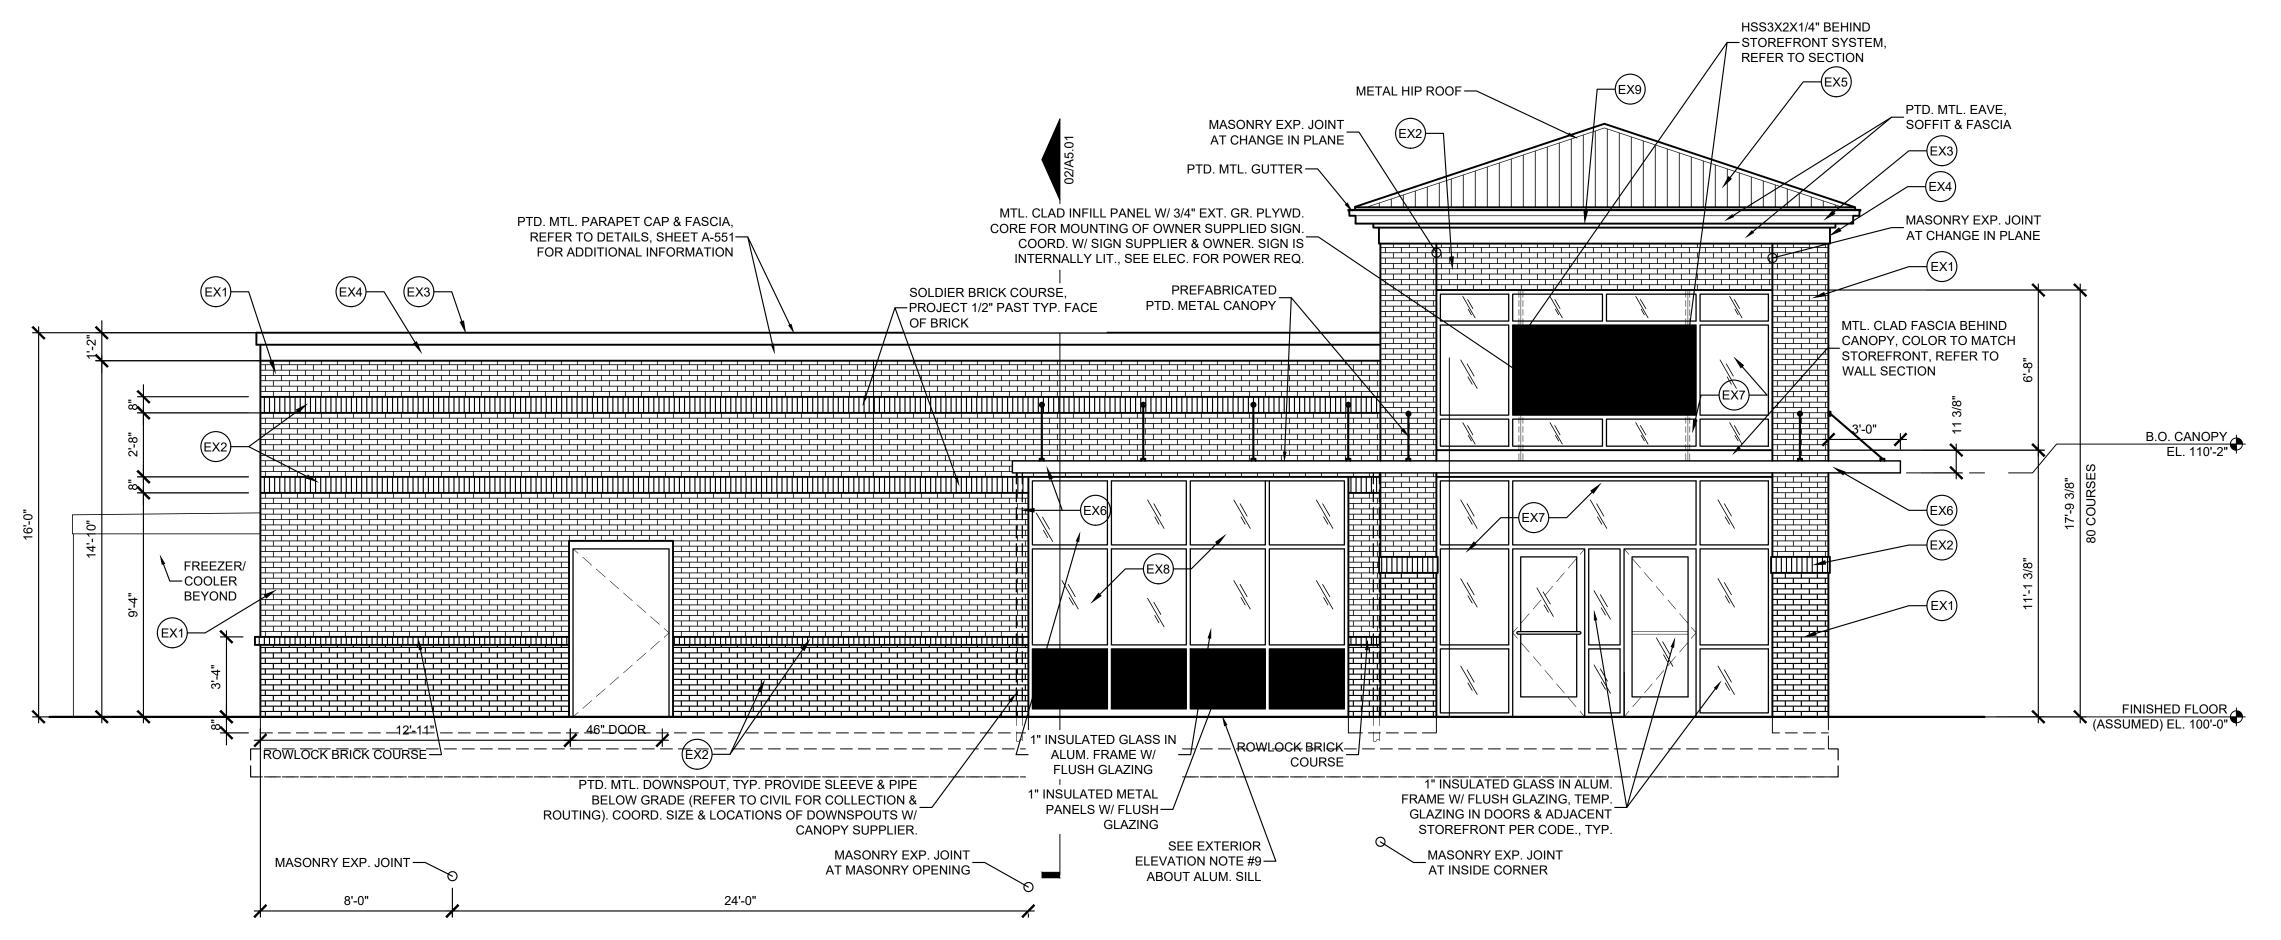
SECTION AND ROOF PLAN

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PROJECT NO: 22-4311 DRAWN BY: KP/NM\ DATE:

05-02-2022





CODE	DESCRIPTION	COLOR/TYPE	MANUFACTURER NOTES
	EXTERIOR BRICK	COLOR:"CHARLESTON WELLINGTON"	SIOUX CITY
EX1		TYPE: MODULAR BRICK	
=1/0	EXTERIOR BRICK	COLOR:"WHITE PLAINS"	SIOUX CITY
EX2		TYPE: MODULAR BRICK	
E\/0	METAL PARAPET CAP (RED)	COLOR:#PATRIOT RED (METALLIC)	METAL SALES
EX3		TYPE: 24GA. KYNAR FINISH	
EV.4	METAL FASCIA (GREY)	COLOR:#MYSTIC PLUS	METAL SALES
EX4		TYPE: 24GA. KYNAR FINISH	
EX5	METAL ROOF (RED)	COLOR:#PATRIOT RED (METALLIC)	METAL SALES
	'TEE PANEL' STANDING SEAM ROOF	TYPE: 24GA. KYNAR FINISH	
EX6	METAL CANOPY (RED)	COLOR:#PATRIOT RED METALLIC	TENNESSEE VALLEY METALS
	(DECKING&D.S., GREY)	COLOR:#MYSTIC PLUS	GALVANIZED
EV.7	ALUMNIUM STOREFRONT	SEE NOTES BELOW	
EX7			
ΓV0	ALUMNIUM STOREFRONT	SEE NOTE #9 BELOW FOR EX#8	
EX8			
ΓVΩ	SOFFIT PANEL (LINEN WHITE)	TYPE: METAL SALES V GROOVE 12 (26 GA)	METAL SALES
EX9		COLOR:# GR50-KYNAR LINEN WHITE	
	GLAZING	SEE NOTES BELOW	
	INSULATED MTL PANEL	SEE NOTES BELOW	

EXTERIOR ELEVATIONS GENERAL NOTES

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- 4. SIGNAGE: COORDINATE SIGN SIZE, POWER REQUIREMENTS, AND LAYOUT WITH SUPPLIER PRIOR TO INSTALLATION OF STOREFRONT.
 5. CANOPY: REFER TO STRUCTURAL FOR REQUIRED LOADING. CANOPY & DOWNSPOUTS SHOWN FOR REFERENCE. FINAL DESIGN & DETAILING BY CANOPY SUPPLIER. SUBMIT TO OWNER FOR APPROVAL.
- 6. ALL DOWNSPOUTS TO BE SLEEVED AND ROUTED BELOW GRADE. COORDINATE WITH CIVIL FOR COLLECTION AND MANAGEMENT OF WATER ON
- GUTTERS SHALL BE TESTED FOR LEAKS BY DAMNING ALL DOWNSPOUTS AND FILLING GUTTERS WITH 2" (APPROX.) OF WATER.
- REFER TO FINISH SCHEDULE FOR HM DOOR AND FRAME PAINT COLORS.
 BOTTOM ALUMINUM SILL SHALL MEASURE 4-13/16" INSTEAD OF 2-1/4". THIS IS TO ALLOW THE TILE ON THE RAISED FLOOR TO BUTT UP AGAINST THE SILL INSTEAD OF HAVING A TILE/GAP ISSUE.

ALUMINUM STOREFRONT: AS MANUFACTURED BY TRULITE
2" X 4-1/2" THERMALLY BROKEN, DARK BRONZE ANODIZED, CENTER GLAZED

INSULATED GLASS:

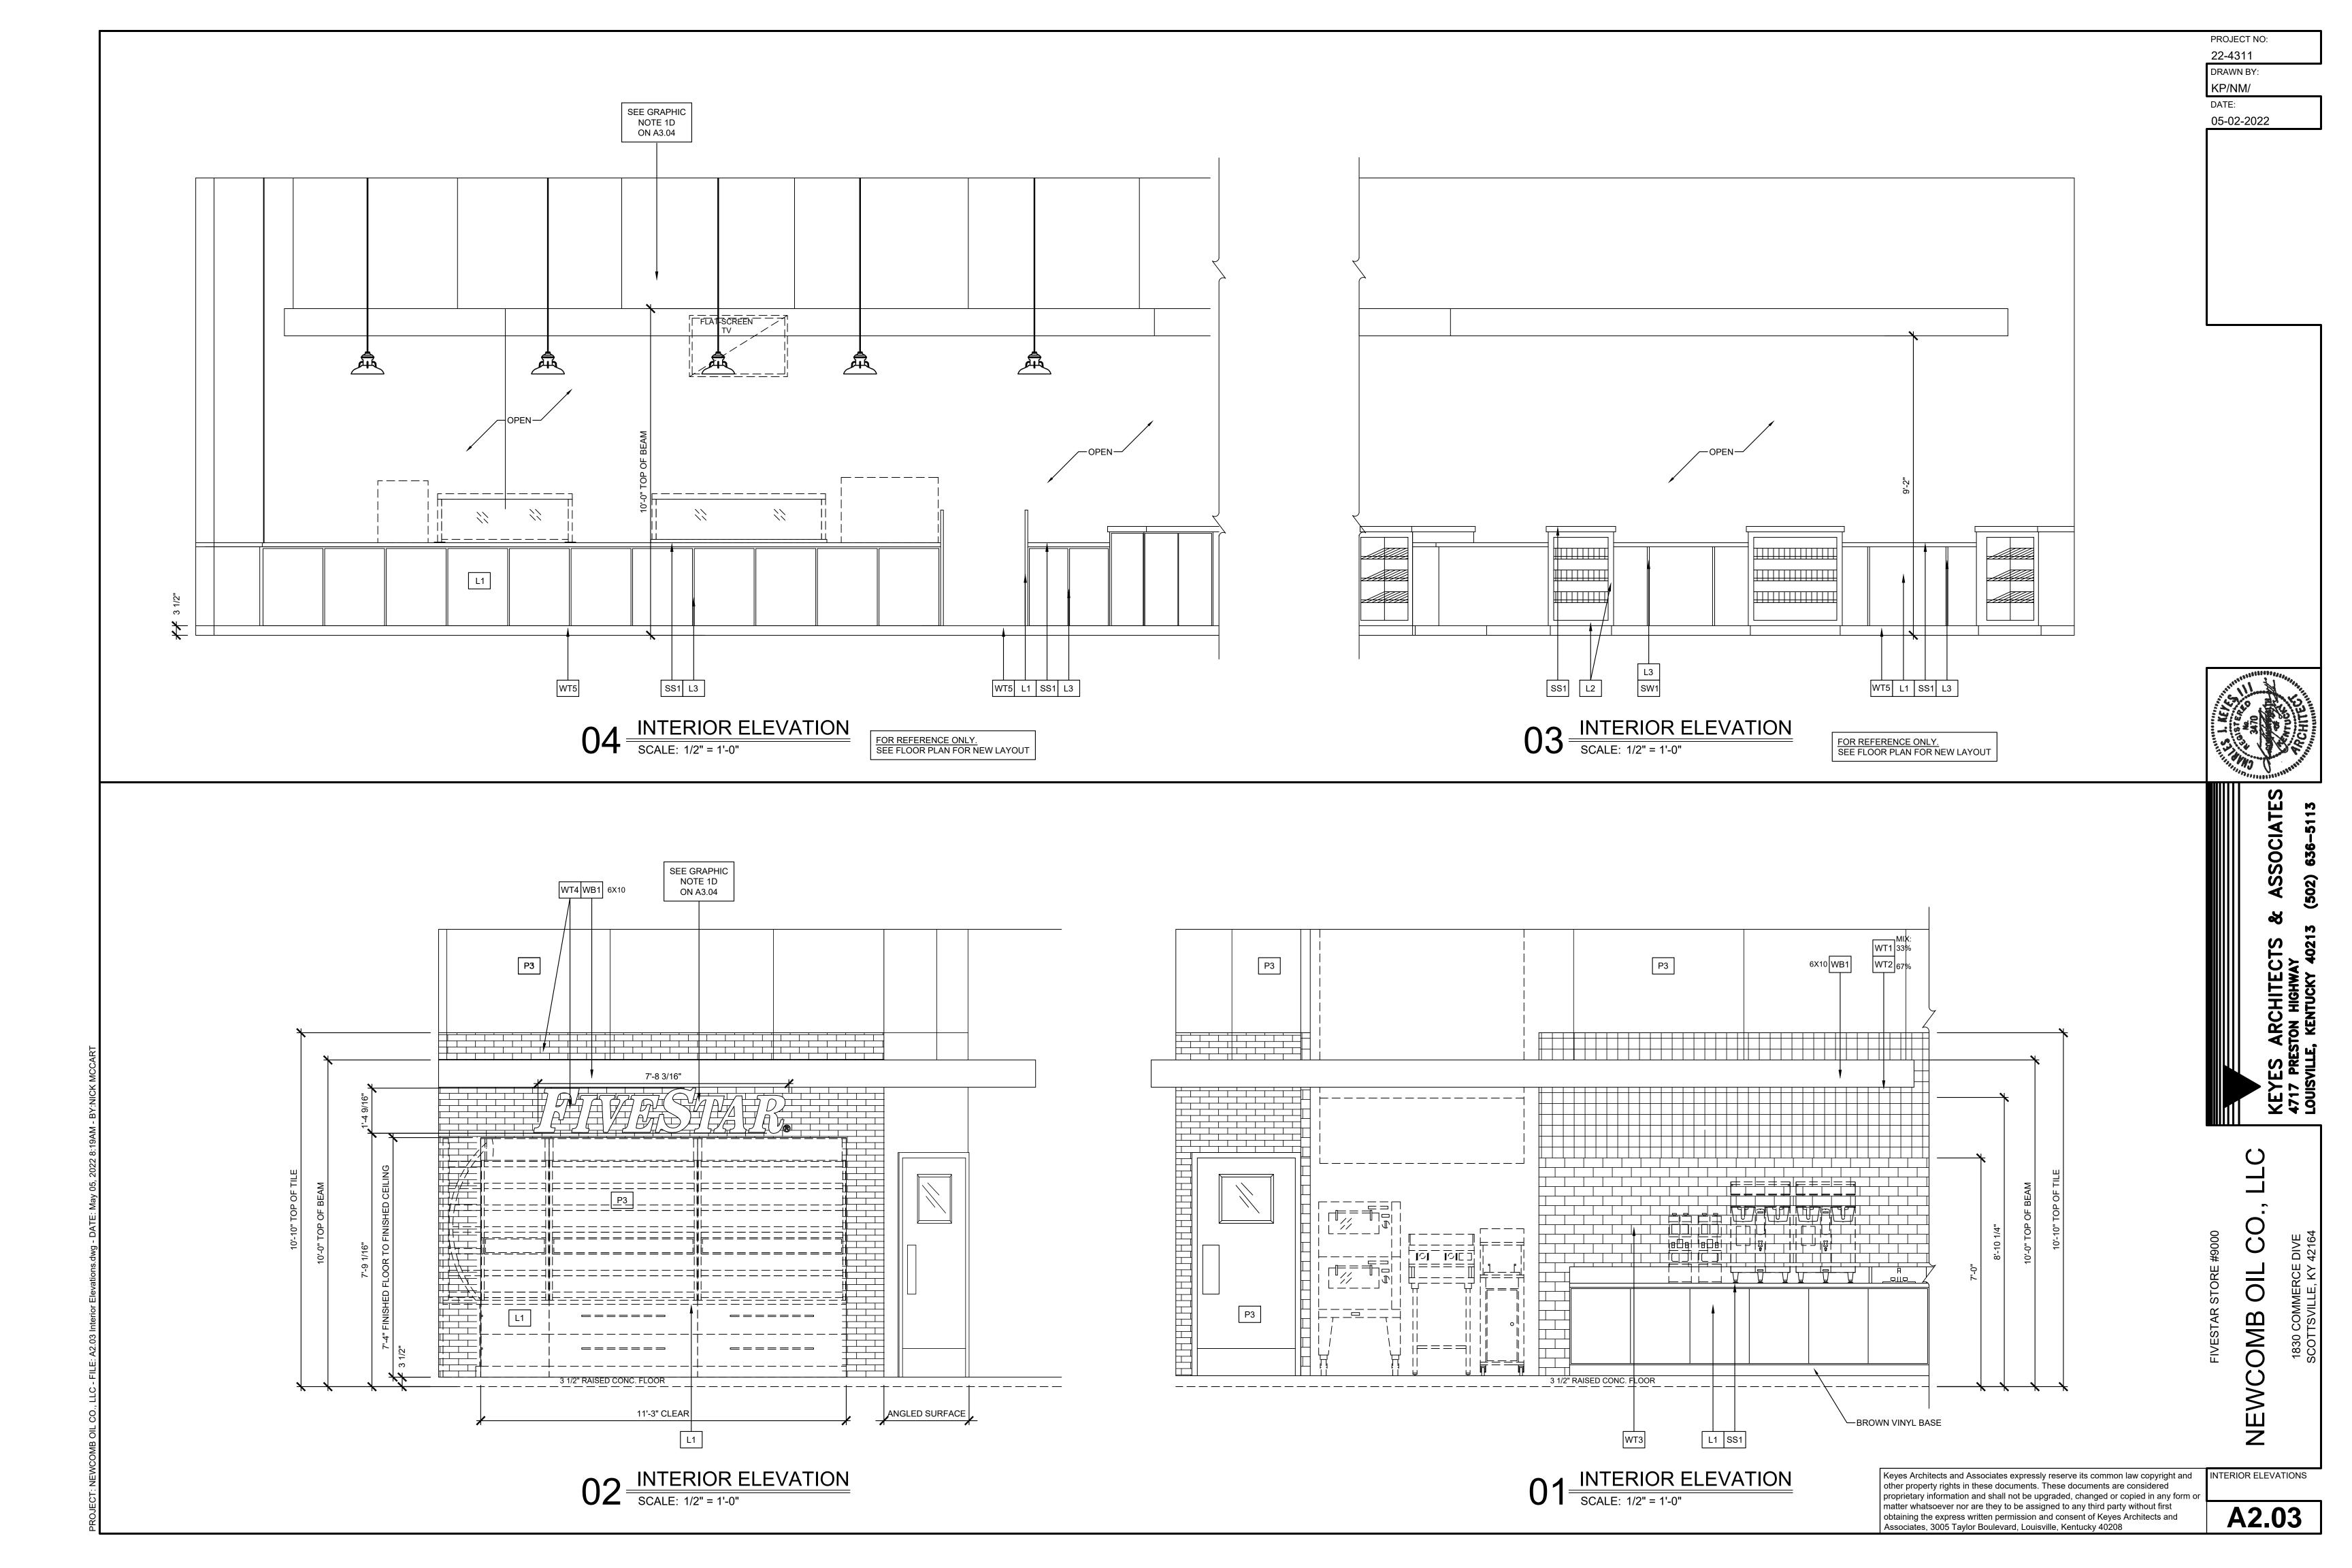
1" INSULATED, SOLAR BRONZE, (HEAT STRENGTHENED) OVER "GUARDIAN SUNGUARD SN-68". FULLY TEMPERED BOTH LIGHTS AS REQUIRED BY CODE.

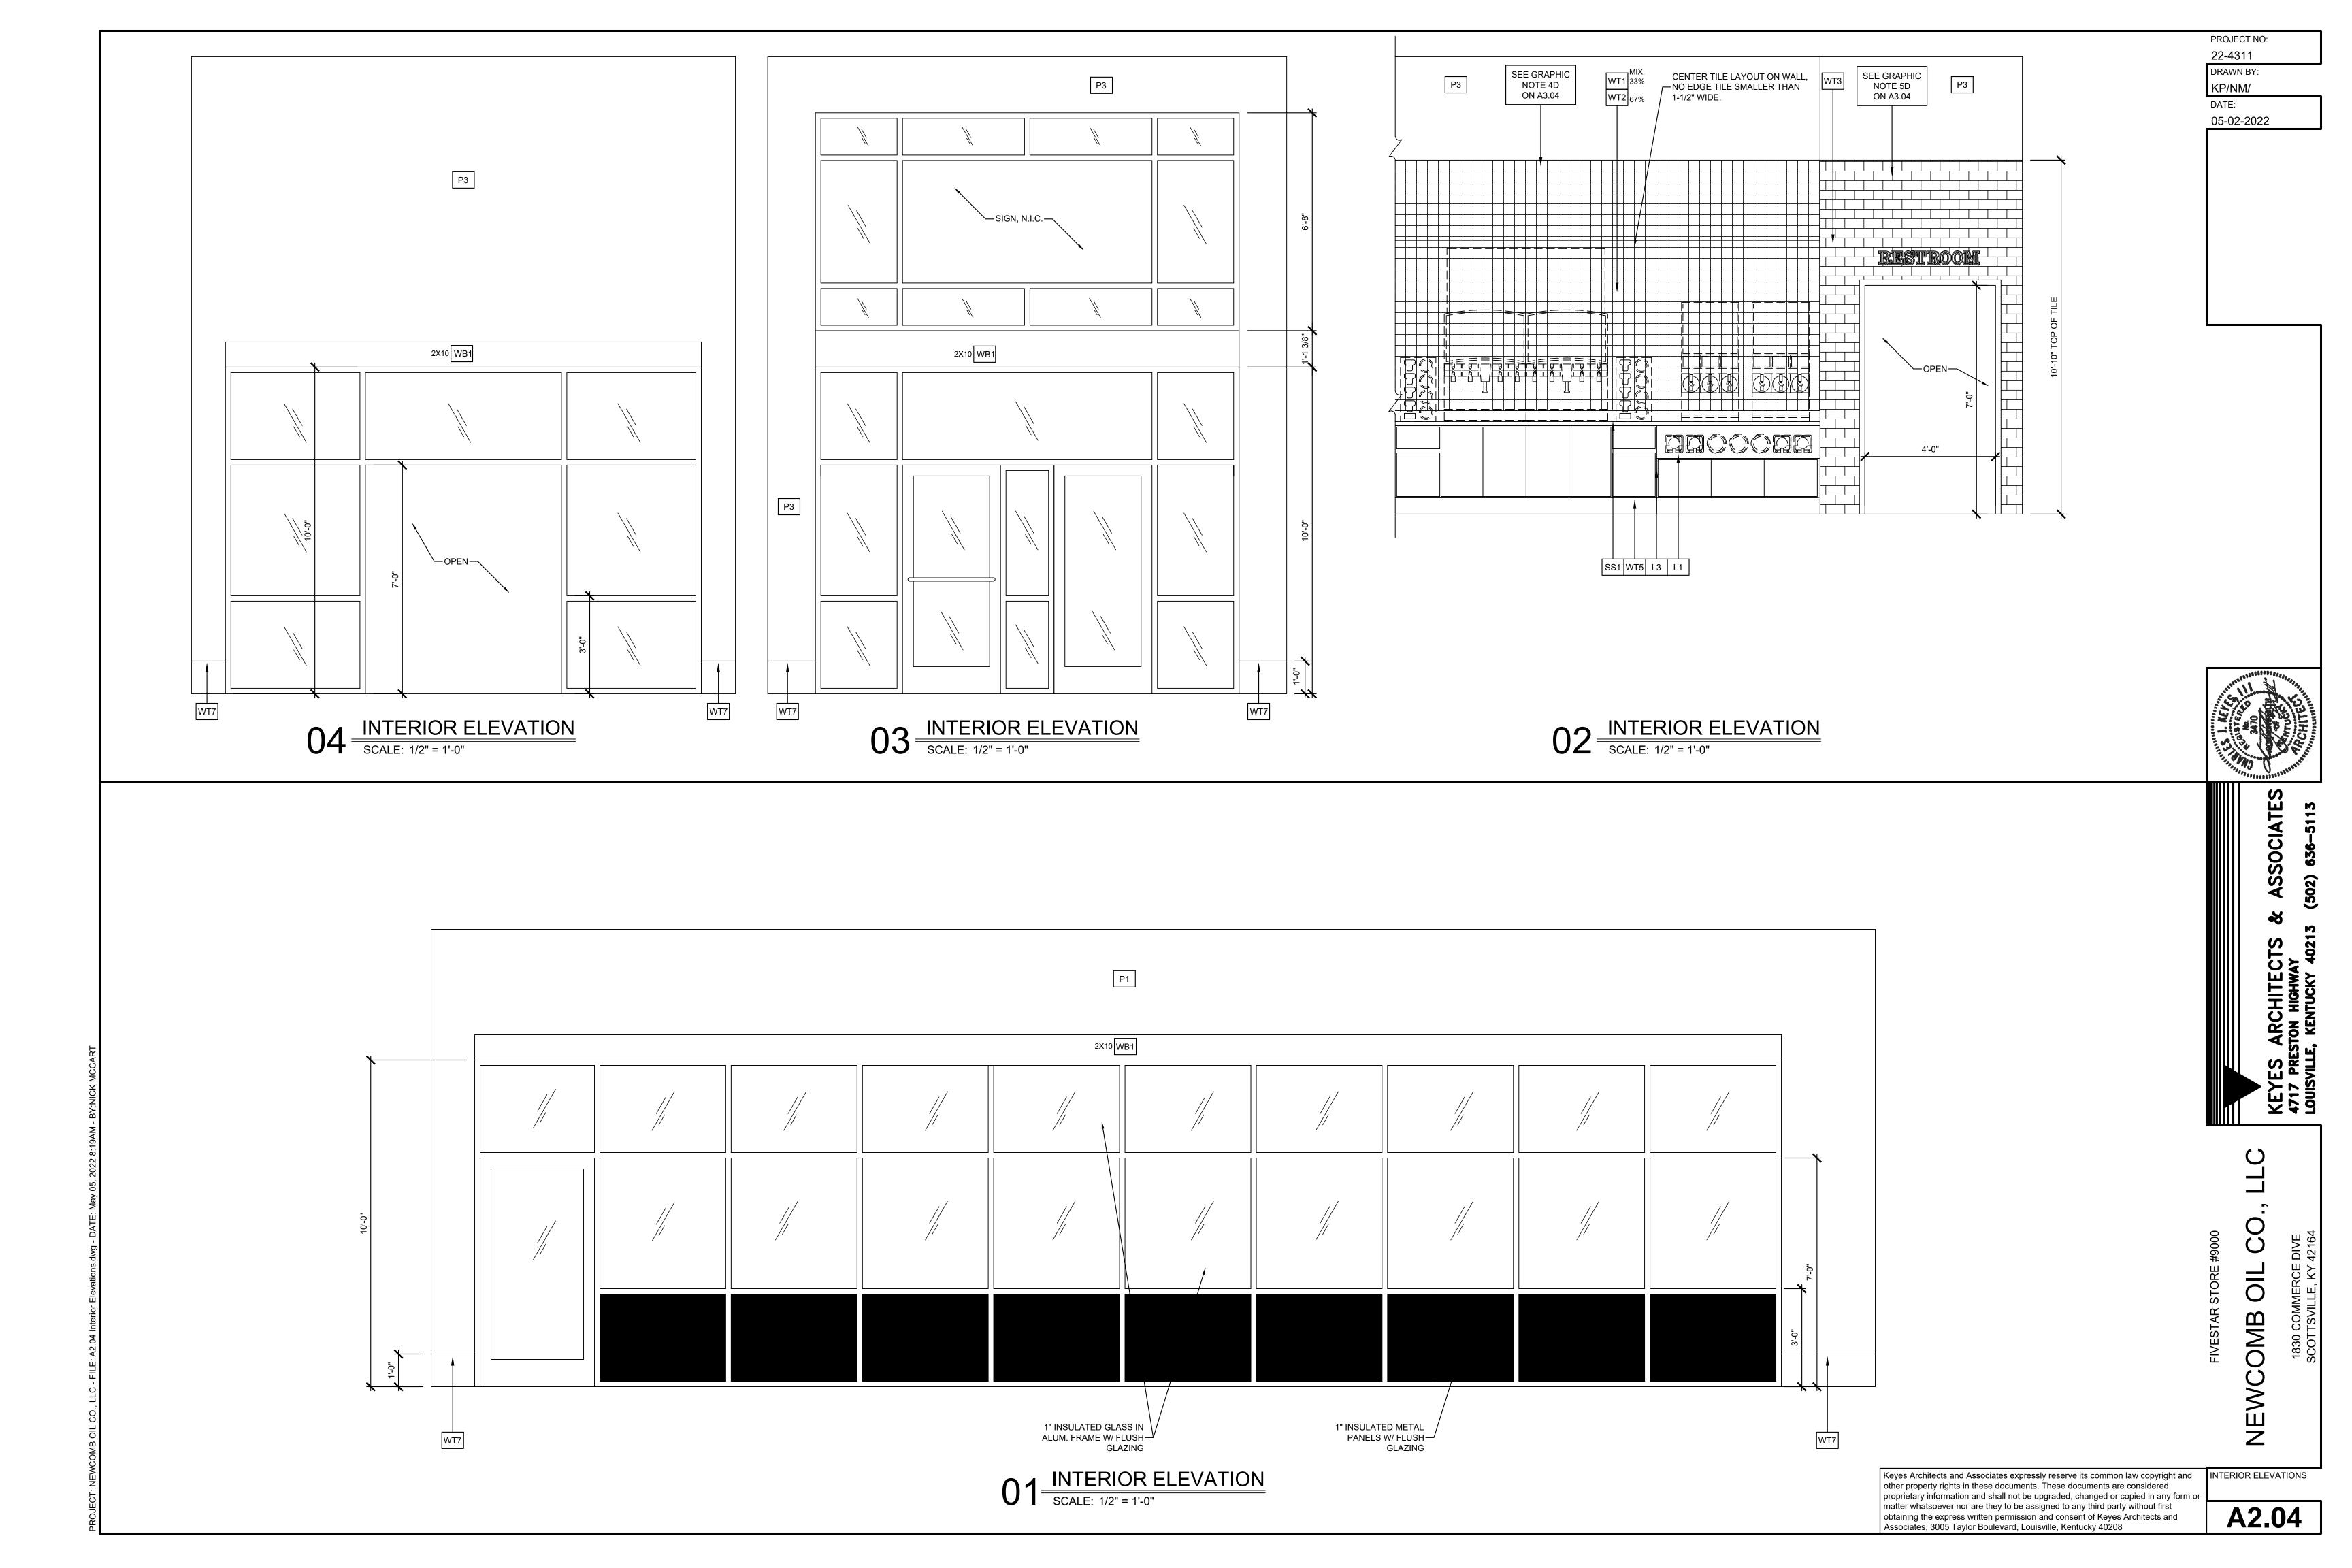
INSULATED PANELS:

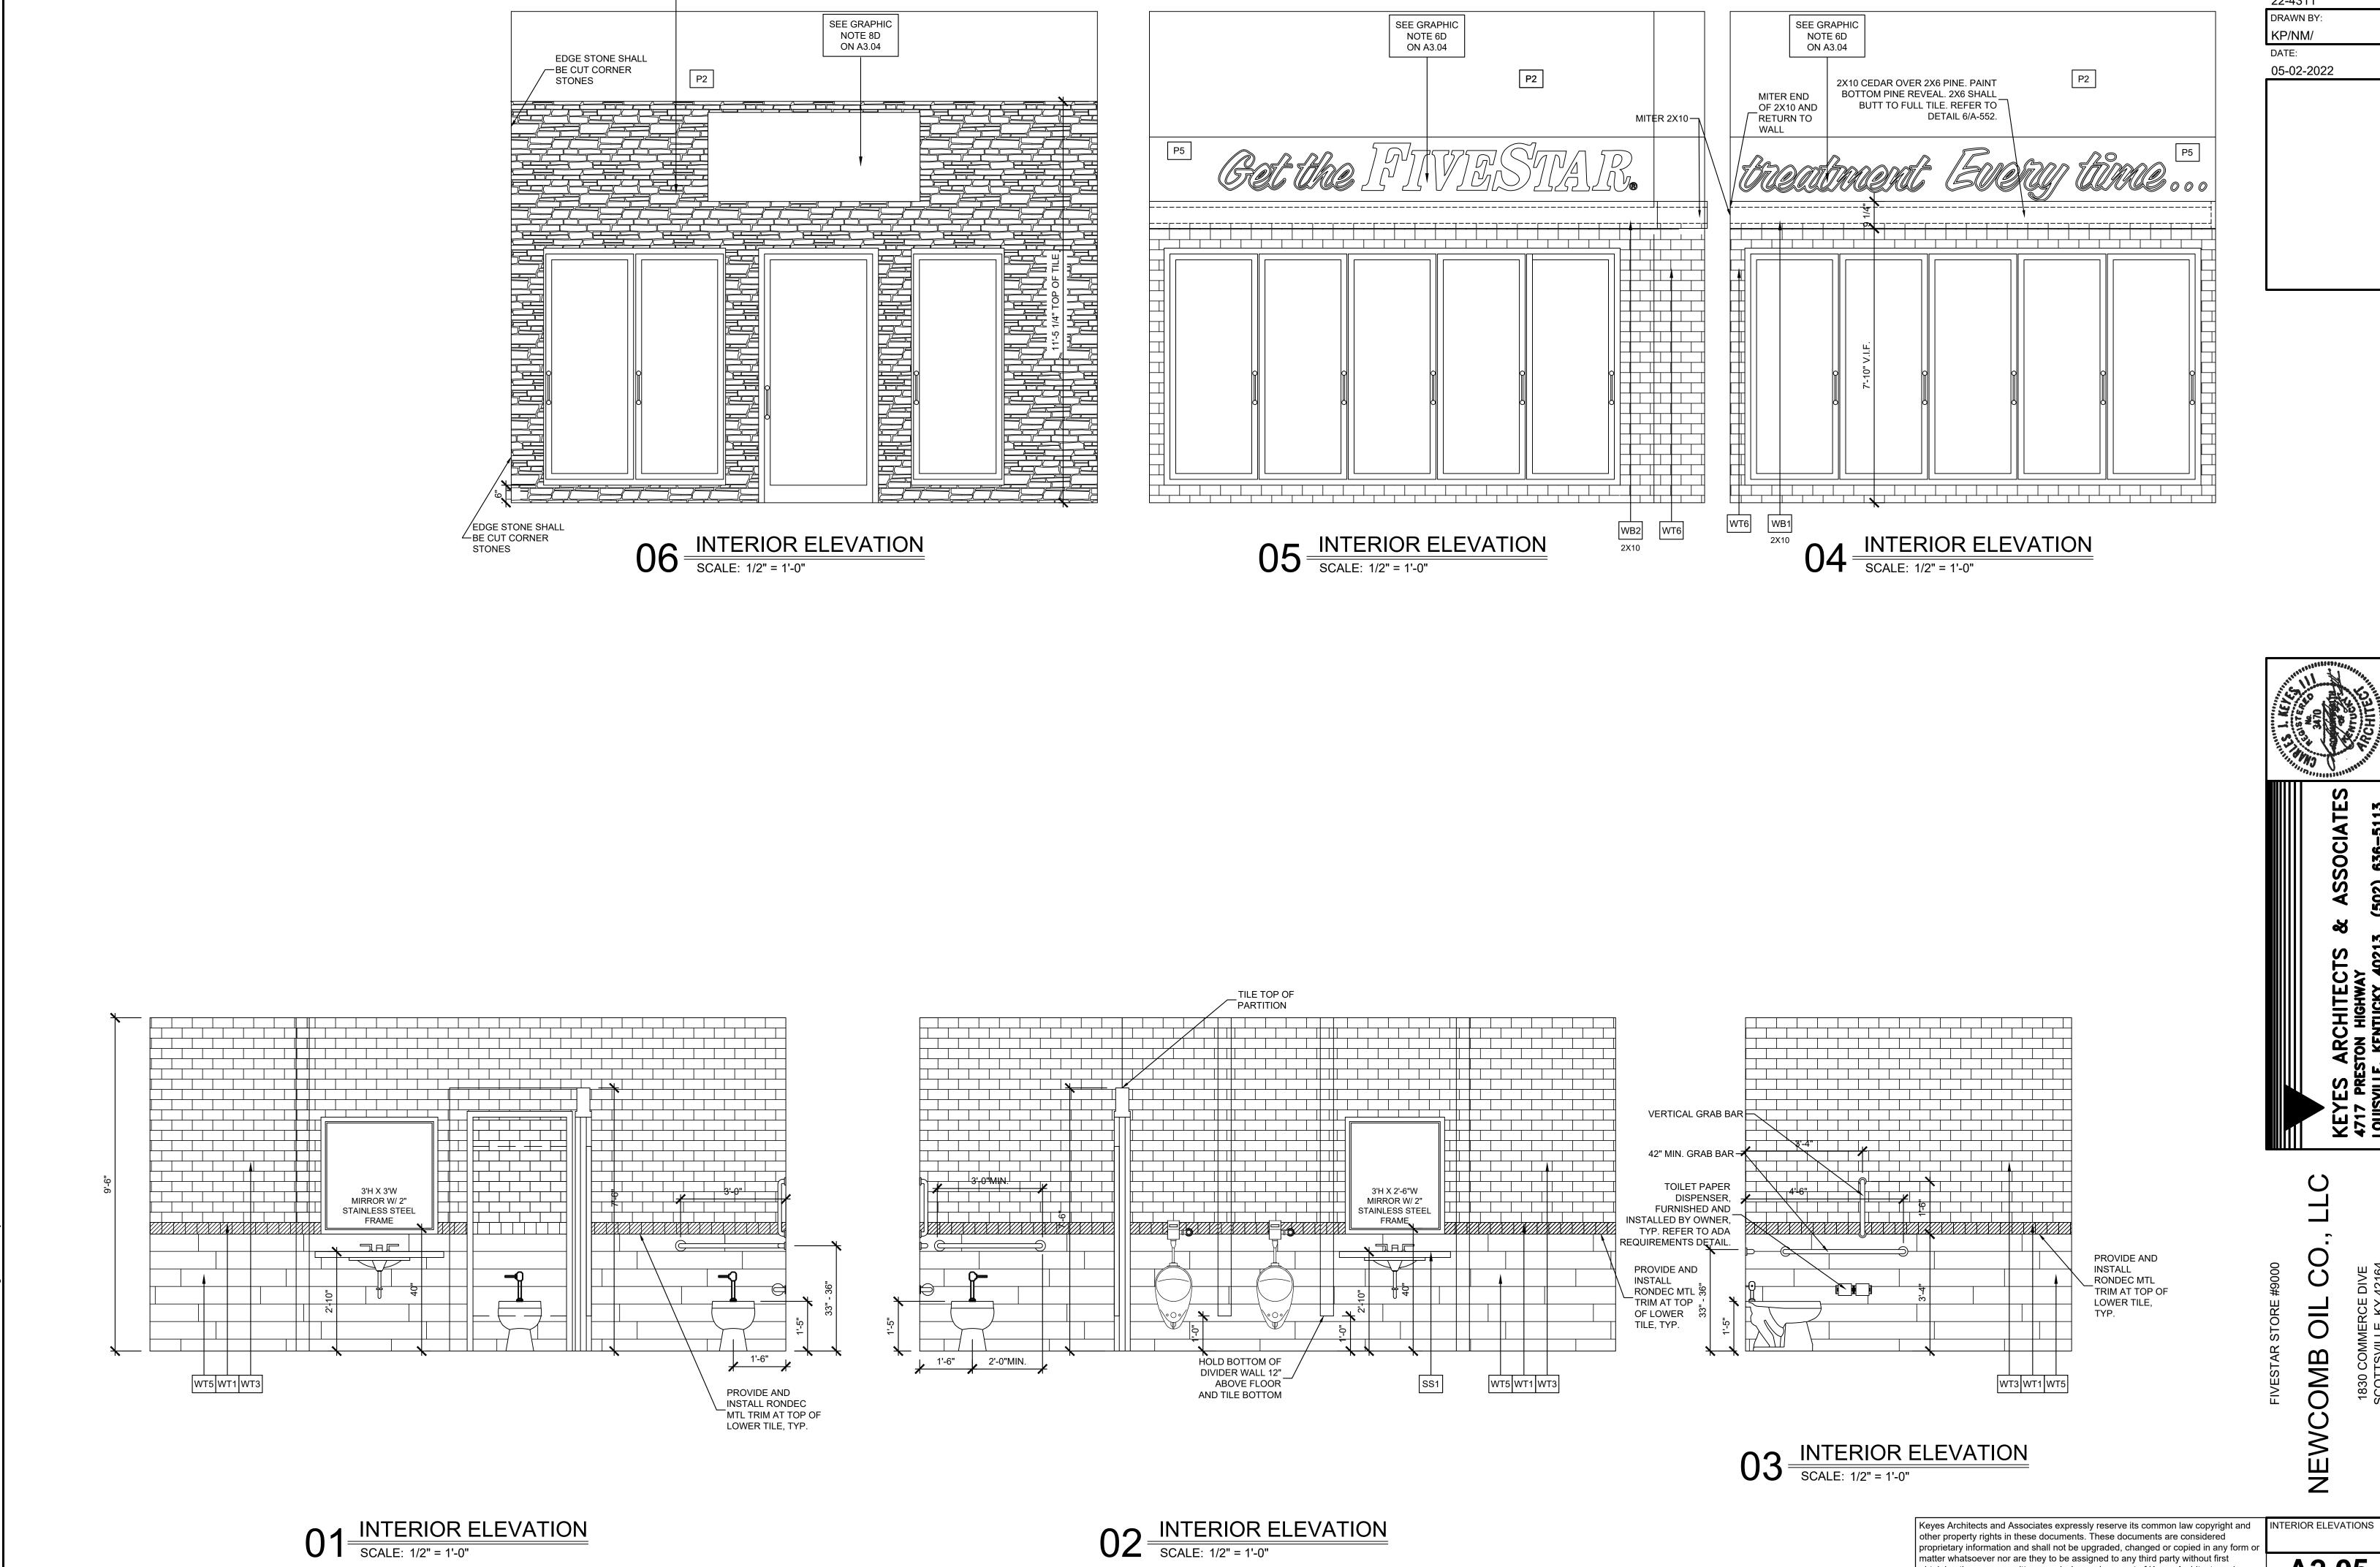
1" INSULATED, DARK BRONZE, "CITADEL GLAZEGUARD 1000 WR", • PRE-FINISHED TEXTURED ALUMINUM SKINS .010", HIGH DENSITY POLYPROPYLENE STABILIZERS, EXPANDED POLYSTYRENE FOAM (EPS) CORE 5/8"

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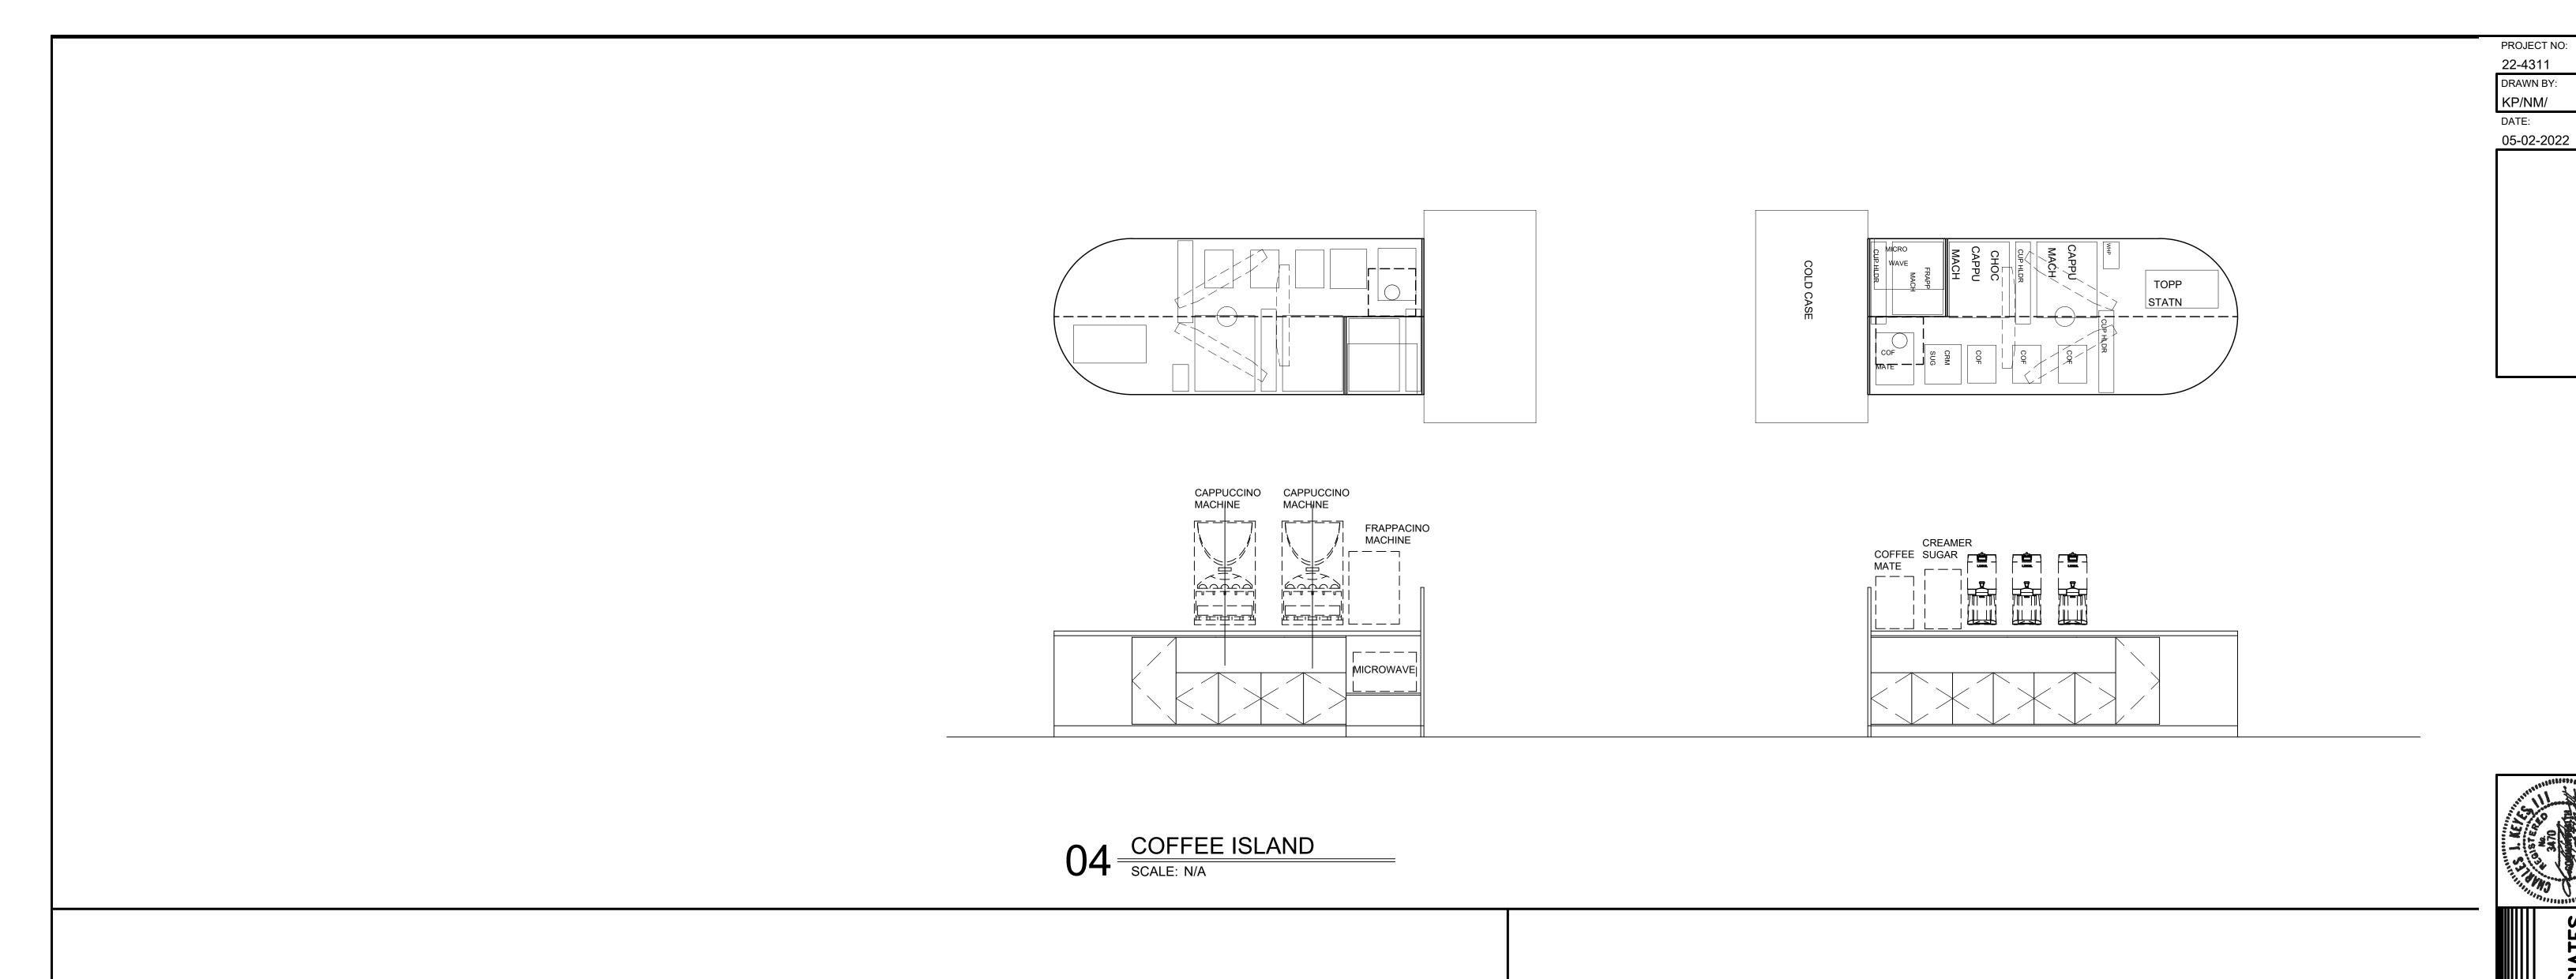


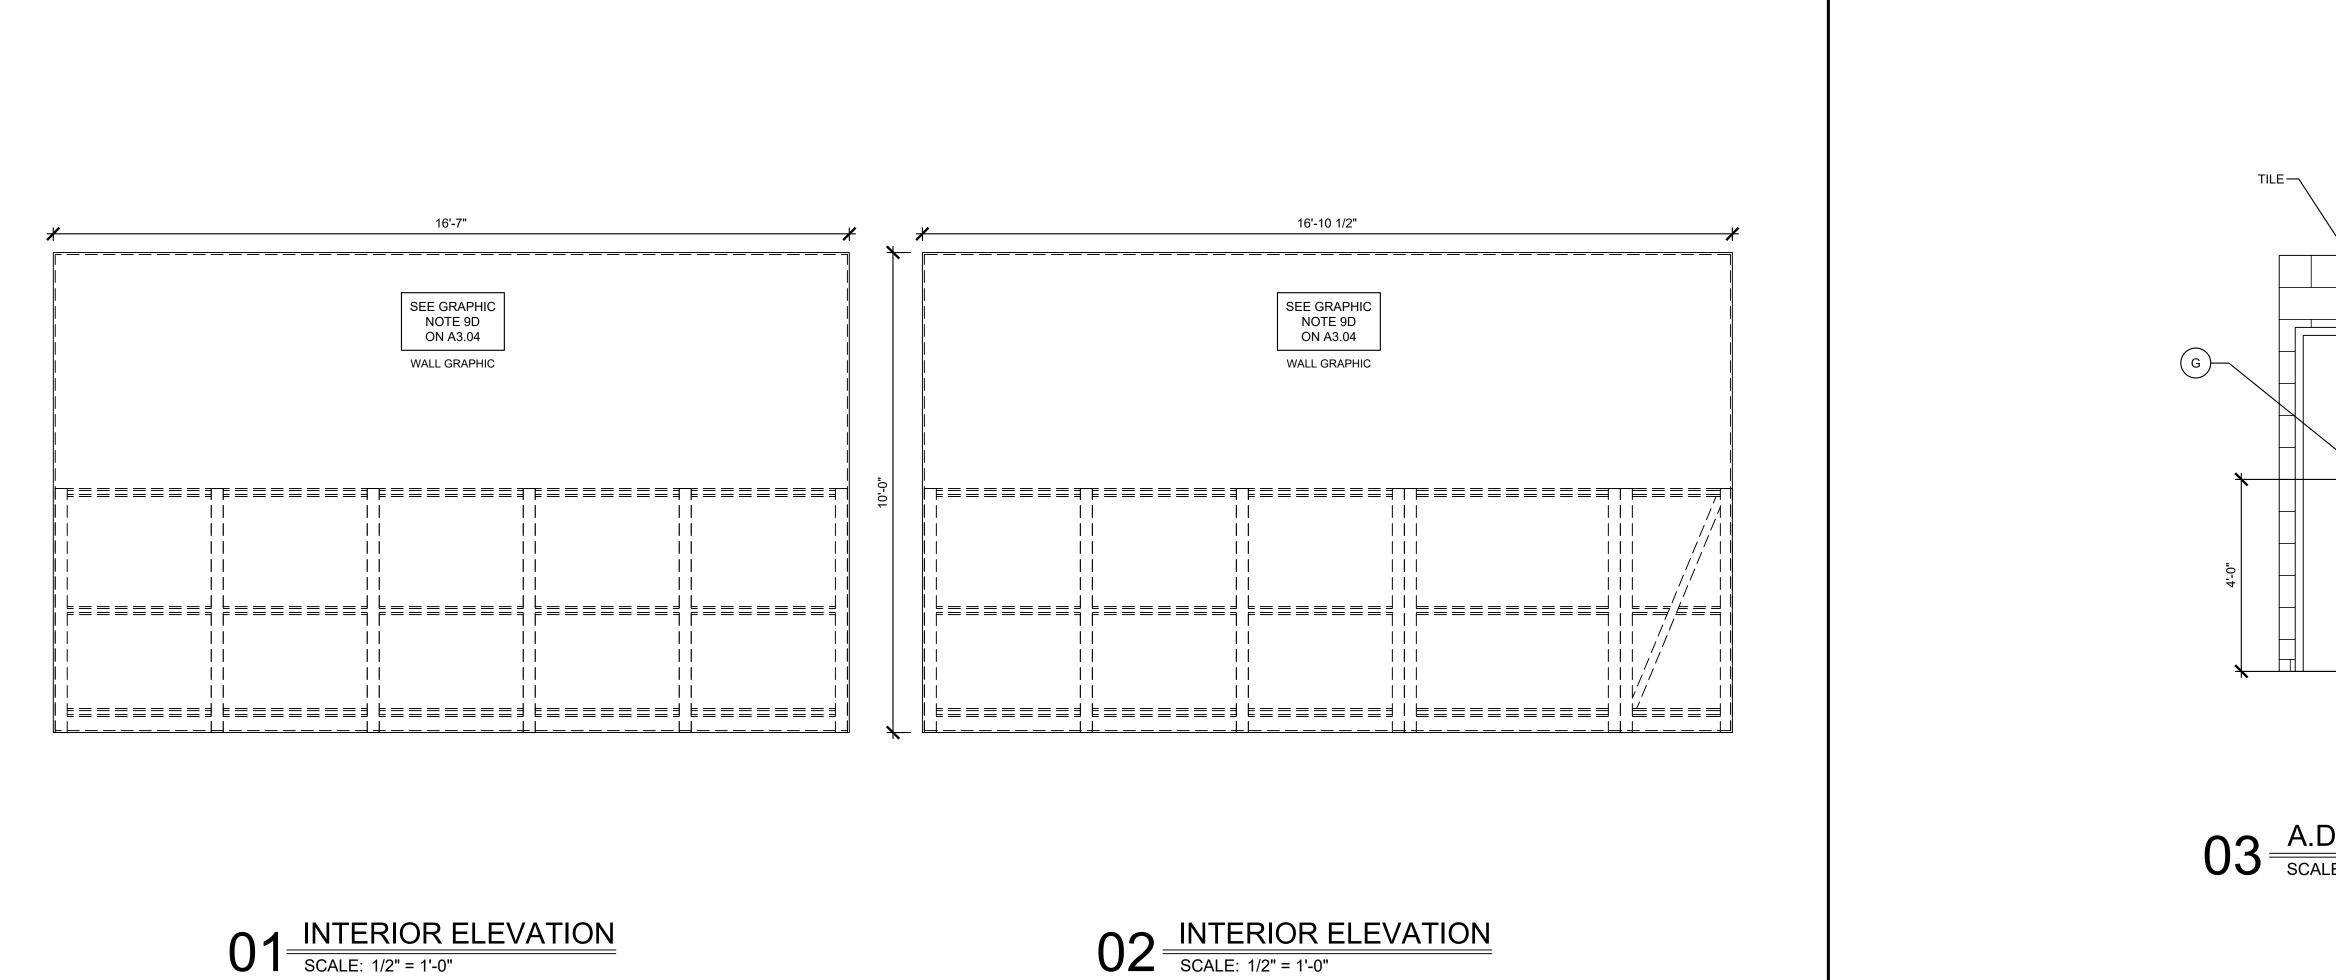


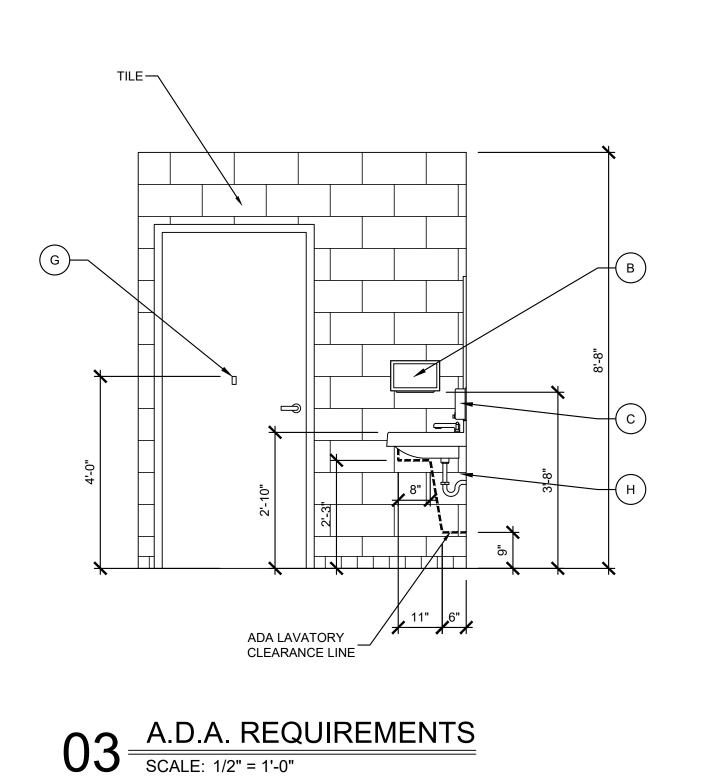
PROJECT NO: 22-4311

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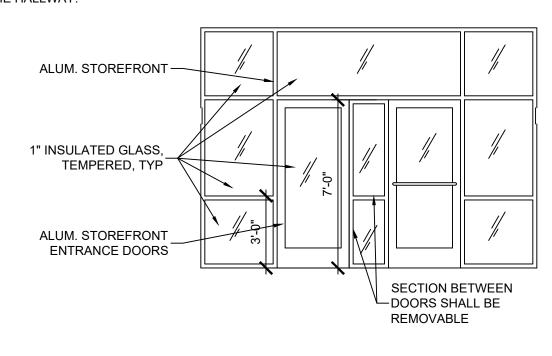


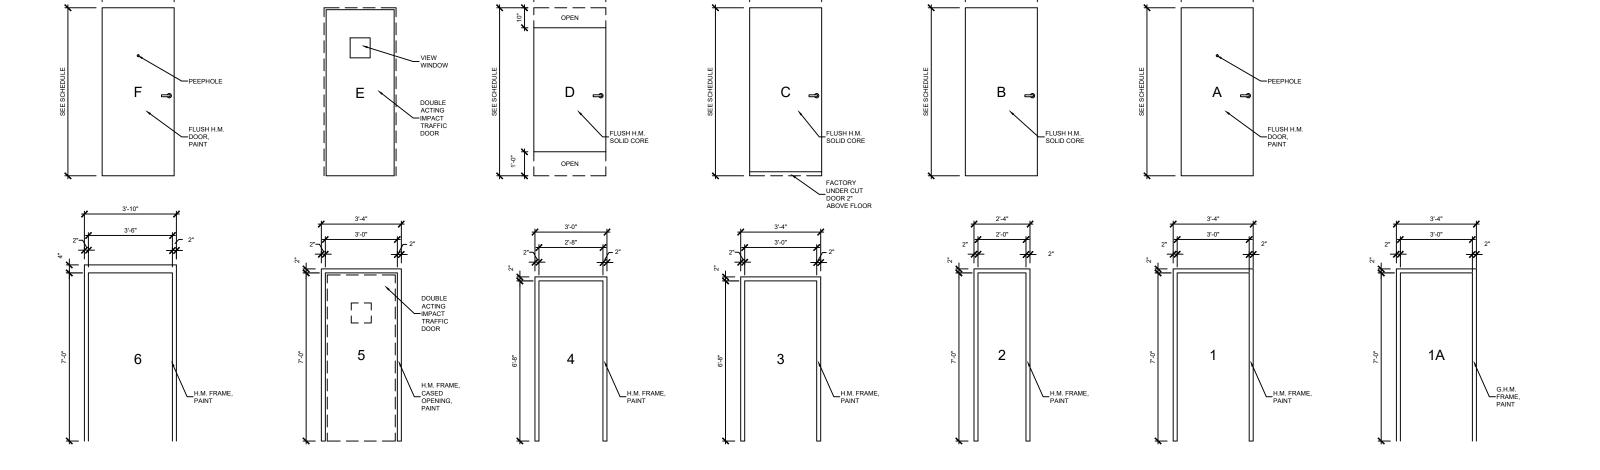
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	DOORS					FRAM	/IES					
DOOR / ROOM	SIZE	MATERIAL	TVDE	MATERIAL	TYPE	DEPTH	DETAILS		RATING	HRDW.	DEMARKS	
NO.	SIZE	IVIATERIAL	' ' ' ' '	IVIATERIAL	ITPE	DEPIN	HEAD	JAMB	SILL	RATING	SET	REMARKS
101 VESTIBULE	3'-0" x 7'-0" x 1-3/4"	ALUM.		ALUM.	-	-	-	-	-	-	-	HARDWARE BY DOOR MANUF CLEAR ANODIZED ALUM. PUSH BAR ON PUSH SIDE OF "OUT DOOR" - REFER TO NOTES FOR ADDITIONAL HARDWARE
102 VESTIBULE	3'-0" x 7'-0" x 1-3/4"	ALUM.		ALUM.	-	-	-	-	-	-	-	HARDWARE BY DOOR MANUF CLEAR ANODIZED ALUM. PUSH BAR ON PUSH SIDE OF "IN DOOR" - REFER TO NOTES FOR ADDITIONAL HARDWARE
103 VESTIBULE	3'-0" x 7'-0" x 1-3/4"	ALUM.		ALUM.	-	-	-	-	-	-	-	HARDWARE BY DOOR MANUF CLEAR ANODIZED ALUM. PUSH BAR ON PUSH SIDE OF "OUT DOOR" - REFER TO NOTES FOR ADDITIONAL HARDWARE
104 VESTIBULE	3'-0" x 7'-0" x 1-3/4"	ALUM.		ALUM.	-	-	-	-	-	-	-	HARDWARE BY DOOR MANUF CLEAR ANODIZED ALUM. PUSH BAR ON PUSH SIDE OF "IN DOOR" - REFER TO NOTES FOR ADDITIONAL HARDWARE
105 SALES	3'-6" x 7'-0" x 1-3/4"	ALUM.		ALUM.	-	-	-	-	-	-	-	HARDWARE BY DOOR MANUF CLEAR ANODIZED ALUM. PANIC DEVICE - REFER TO NOTES FOR ADDITIONAL HARDWARE
NOT USED	-	-		-	-	-	-	-	-	-	-	-
107 DELI	3'-0" x 7'-0" CASED OPENING	ALUM.	E	H.M.	5	-	-	-	-	-	-	ELIASON DOOR
108 DELI	3'-0" x 7'-0" CASED OPENING	ALUM.	E	H.M.	5	-	-	-	-	-	-	ELIASON DOOR
109 OFFICE	3'-0" x 7'-0" x 1-3/4"	H.M.	В	H.M.	1	-	-	-	-	-	-	LEVER, TRILOGY LOCK, HINGES, WALL STOP
110 OFFICE CLO.	2'-0" x 7'-0" x 1-3/4"	H.M.	С	H.M.	2	-	-	-	-	-	TRILOGY	LEVER, LOCK, PICK GUARD, HINGES, WALL STOP, UNDERCUT DOOR 1"
111 ELEC. RM.	3'-0" x 7'-0" x 1-3/4"	H.M.	В	H.M.	1	-	-	-	-	-	-	PANIC DEVICE, HINGES, CLOSER INSIDE, FLOOR STOP
112 HALLWAY	3'-0" x 7'-0" x 1-3/4"	H.M.	В	H.M.	1	-	-	-	-	-	TRILOGY	LEVER, LOCK, HINGES, CLOSER INSIDE, WALL STOP, FULL HEIGHT AND WIDTH S.S DOOR PROTECTION PLATE ON PUSH SIDE
113 W. RESTROOM	2'-4" x 6'-8" x 1-3/4"	H.M.	D	H.M.	4	-	-	-	-	-	-	OCCUPIED/UNOCUPPIED DEADBOLT, PUSH/PULL DRILLED TO ACCOMMODATE DEADBOLT, HINGES
114 W. RESTROOM	3'-0" x 6'-8" x 1-3/4"	H.M.	D	H.M.	3	-	-	-	-	-	-	OCCUPIED/UNOCUPPIED DEADBOLT, PUSH/PULL DRILLED TO ACCOMMODATE DEADBOLT, (1) HINGE, (1) SPRING HINGE
115 CLOSET	3'-0" x 7'-0" x 1-3/4"	H.M.	В	H.M.	1	-	-	-	-	-	-	PASSAGE LEVER SET, HINGES, CLOSER WITH 90° STOP AND MOUNTED INSIDE CLOSET
116 M. RESTROOM	3'-0" x 6'-8" x 1-3/4"	H.M.	D	H.M.	3	-	-	-	-	-	-	OCCUPIED/UNOCUPPIED DEADBOLT, PUSH/PULL DRILLED TO ACCOMMODATE DEADBOLT, (1) HINGE, (1) SPRING HINGE
117 STORAGE	3'-0" x 7'-0" x 1-3/4"	H.M.	В	H.M.	1	-	-	-	-	-	-	PULL, CLOSER INSIDE, HINGES, CLOSER STOP AT 110°, FULL HEIGHT AND WIDTH S.S DOOR PROTECTION PLATE ON PUSH SIDE
118 STORAGE	3'-0" x 7'-0" x 1-3/4"	G.H.M.	А	G.H.M.	1A	-	-	-	-	-	-	GALV, INSUL, PANIC DEVICE (NO HARDWARE OUTSIDE), SCREW ON WEATHER STRIPPING & SWEEP, THRESHOLD, PEEP HOLE, HINGES, CLOSER, 4" HEAD
119 DISHWASHING	3'-6" x 7'-0" x 1-3/4"	G.H.M.	F	G.H.M.	6	8 1/2"	-	-	-	_	-	GALV, INSUL, PANIC DEVICE (NO HARDWARE OUTSIDE), SCREW ON WEATHER STRIPPING & SWEEP, THRESHOLD, PEEP HOLE, HINGES, CLOSER, 4" HEAD

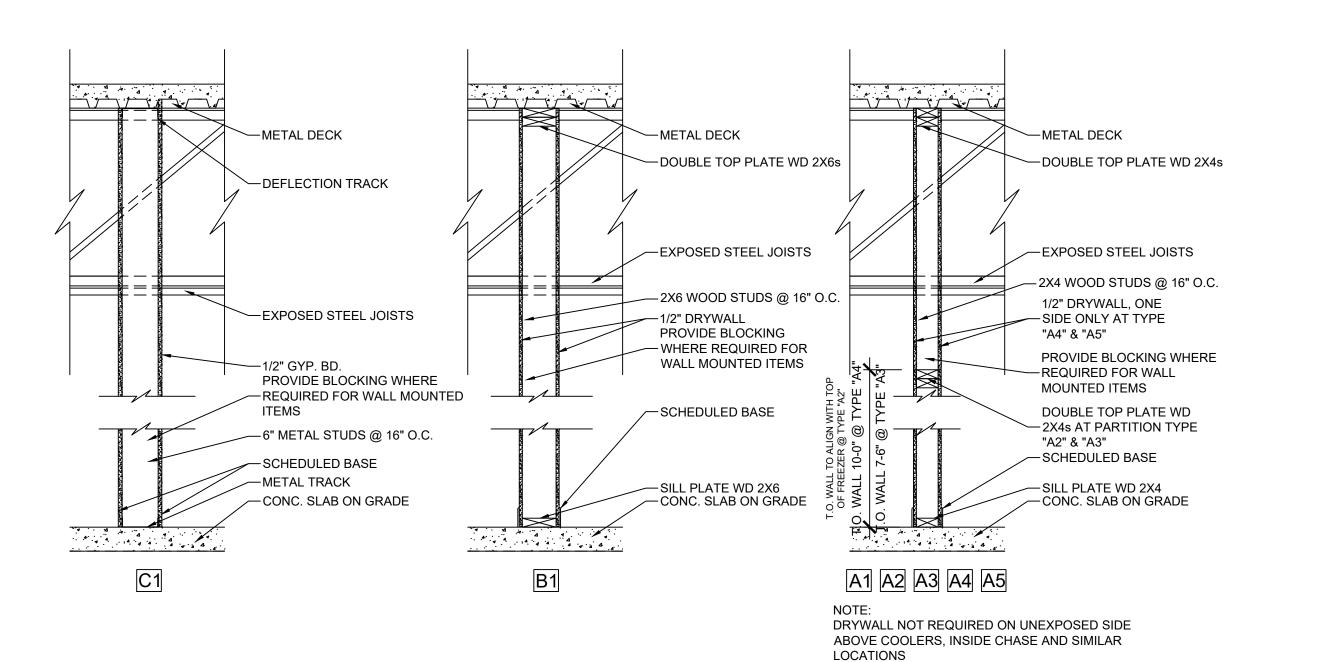
NOTES:

- 1. GLASS SHALL BE TEMPERED WHERE REQUIRED BY CODE.
- 2. VERIFY ALL WALL DEPTHS, REQUIRED FRAME DEPTHS AND FRAME DIMENSIONS IN THE FIELD.
- 3. DOOR 118 SHALL HAVE A THRESHOLD, PEEPHOLE, PICK GUARD AND WEATHER STRIPPING.
- 4. DOORS 101, 102, 103 AND 104 SHALL BE KEYED ALIKE. PUSH BAR ON IN AND OUT.
- 5. DOORS 109 AND 115 SHALL BE KEYED ALIKE 6. DOOR 110 OFFICE CLOSET SHALL BE KEYED SEPARATELY
- 7. ALL DOORS SHALL HAVE 3 HINGES EXCEPT FOR ENTRANCE DOORS, REFER TO NOTES BELOW
- 8. ALL HINGES ARE BALL BEARING
- 9. ALL CLOSURES ARE MEDIUM DUTY
- 10. ALL LEVER SETS ARE MEDIUM DUTY
- 11. DOOR HARDWARE SHALL MEET HANDICAP REQUIREMENTS
- 12. ALL DOORS SHALL HAVE DOOR SILENCERS AND DOOR STOPS INCLUDING RESTROOM STALL DOORS.
- 13. HARDWARE FOR ALUM. DOORS 101, 102, 103, 104 AND 105 PROVIDED BY MANUFACTURER. HINGES (1 ½ PAIR OF BUTT HINGES FOR DOOR 105, CONTINUOUS HINGES FOR DOORS 101, 102, 103 AND 104), DEADLOCK, WITH 5 PIN CYLINDER (KEYED ALIKE), (BOTH SIDES, KBC 1010.1.9.3), GRADE 1, ADA. CLOSER, WITH ADJUSTABLE SPRING TENSION, ADA THRESHOLDS (GROUTED SOLID), WEATHER STRIP, & BOTTOM RAIL SWEEP. REFER TO SCHEDULE FOR PUSH BARS AND PANIC DEVICE. NO PULLS ON ALUM DOORS.
- 14. NOTE: WHILE BUILDING IS BEING OCCUPIED SIGN SHALL BE WITH 1" LETTERS HIGH THAT READS "THIS DOOR IS TO REMAIN UNLOCKED WHEN THIS SPACE IS OCCUPIED"
- 15. CLOSERS ON DOORS INTO STORAGE AND RESTROOMS SHALL BE INSTALLED ON STORAGE AND RESTROOM SIDE SO THAT THEY ARE NOT VISIBLE FROM THE HALLWAY.





01 DOOR DETAILS SCALE: 1/4" = 1'-0"



O2 PARTITION DETAILS

SCALE: 3/4" = 1'-0"

PROJECT NO: 22-4311 DRAWN BY:

05-02-2022

KP/NM/

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	DESCRIPTION / LABEL	COLOR	MANUFACTURER
ODE	AREA / SUBSTRATE	PRODUCT # OR SERIES	CONTACT
	SUPERPAINT INT. LATEX SATIN / PRIMER	#SW7506 LOGGIA	SHERWIN WILLIAMS
P1	SALES FLR. & STORAGE ROOM WALLS / DRYWALL	A87W01151	G.I.E. WIN WILLS AND
	SUPERPAINT INT. LATEX SATIN / FINISH	#SW6221 MOODY BLUE	SHERWIN WILLIAMS
P2	ACCENT ABOVE COOLER WALL / DRYWALL	A87W01153	OTILITATIVITY WILLIAMS
	SUPERPAINT INT. LATEX SATIN / FINISH		SHERWIN WILLIAMS
P3	FRONT DOOR WALL / DRYWALL	#SW7598 SIERRA REDWOOD	SHERWIN WILLIAWS
		A87W01153	SHERWIN WILLIAMS
P4	PRO INDUST. PRECATAL. WATERBASED EPOXY EG-SHEL / FINISH	#SW7515 HOMESTEAD BROWN	SHERWIN WILLIAWS
	DOOR JAMBS / STEEL	B53T01154	CHEDWINIMH LIAMO
P5	SUPERPAINT INT. LATEX SATIN / FINISH	#SW6395 ALCHEMY	SHERWIN WILLIAMS
	ABOVE WALK-IN COOLER / DRYWALL	A87W01153	OUEDWIN MULLIANO
P6	PRO INDUSTRIAL URETHANE ALKYD ENAMEL GLOSS / FINISH	#SW7598 SIERRA REDWOOD	SHERWIN WILLIAMS
	EXTERIOR METAL DOORS / STEEL	B54T01154	
P7	CHB INTERIOR LATEX FLAT	WHITE	SHERWIN WILLIAMS
	CEILING: DRYWALL	B30WC4051	
P8	WATERBOURNE ACRYLIC DRY FALL FLAT WHITE	WHITE	SHERWIN WILLIAMS
	CEILING: OPEN AREA/GALVANIZED	B42W00181	
P9	PRO INDUSTRIAL URETHANE ALKYD ENAMEL GLOSS / FINISH	#SW7598 SIERRA REDWOOD	SHERWIN WILLIAMS
	BATHROOM DOORS - STALL	B54T01154	
P10	PRO INDUSTRIAL URETHANE ALKYD PRIMER	WHITE	SHERWIN WILLIAMS
	AC TRUCK LINES - PRIMER	B66W310	
P11	PRO INDUSTRIAL URETHANE ALKYD ENAMEL GLOSS / FINISH	WHITE	SHERWIN WILLIAMS
-11	AC TRUCK LINES - FINISH	K46W01151	
004	1/2" SOLID SURFACING	COLOR: SERENE SAGE	CORIAN
SS1		COLLECTION: TERRA	800.426.7426
	PLASTIC LAMINATE ARTISAN FINISH	#6206-43	FORMICA
L1		PLANKED DELUXE PEAR	1.800.FORMICA
	PLASTIC LAMINATE CASHMERE FINISH	#P-260 CA	ARBORITE
L2	TEXAMINATE OF THE PROPERTY OF	TATAMI SABI	800.361.8712
	PLASTIC LAMINATE CASHMERE FINISH	#P-354 CA	ARBORITE
L3	PLACTIC LAWINATE CACHWILINE FINIOTI		800.361.8712
	0 V 40 0 V 40 0 4 V 40 W00D DEAMO	TATAMI KOKOA	
VB1	6 X 10, 2 X 10 & 4 X 10 WOOD BEAMS	CLEAR SEALER	SHERWIN WILLIAMS
		710520000	BY GENERAL CONTRACTOR
MS1	MANUFACTURED STONE VENEER	SERIES: STACKED STONE	ELDORADO STONE
		COLOR: DRY CREEK	800.925.1491
NT1	4 X 4 GLAZED PORCELAIN CERAMIC TILE	#Q093 FIREBRICK	DALTILE
	WALL TILE	#145 LIGHT SMOKE	
VT2	4 X 4 GLAZED PORCELAIN CERAMIC TILE	#0190 ARCTIC WHITE	DALTILE
	WALL TILE	#145 LIGHT SMOKE	
NT3	4 X 8 GLAZED PORCELAIN CERAMIC TILE	#0190 MOD ARCTIC WHITE	DALTILE
	WALL TILE	#145 LIGHT SMOKE	
NT4	9/16" FIRED BRICK FLATS	#410 LINCOLN HERITAGE	EVOLUTION BRICK
W14	WALL TILE	#543 DRIFTWOOD	
	6 X 36 COLORBODY PORCELAIN TILE	#HH03 TEAK	DALTILE
NT5	WALL/FLOOR TILE	#145 LIGHT SMOKE	
	4 X 8 GLAZED PORCELAIN TILE	CUSTOM COLOR - QTC1481P 4x8 QT01	DALTILE
WT6	WALL TILE	#09 NATURAL GREY	
	12 X 12 COLORBODY PORCELAIN TILE	#VL78 ACCEN\T BROWN	DALTILE
NT7	COVEBASE TILE	#145 LIGHT SMOKE	
	FINISHING & EDGE-PROTECTION PROFILES	FINISH: AT SATIN NICKEL ANODIZED ALUM	SCHLUTER SYSTEMS _SCHLUTER.0
WT9			
V 1 J	FOR WALLS	- DESIGNLINE 1/4"	1.800.472.4588
	USED ON ALL HIGH ABUSE CORNERS W/TILE	- RONDEC 1/4"	
RP-1	MARLITE AT 10'-0"	STANDARD COLOR	MARLITE
	WALL COVERING		
	•		i .

INTERIOR GENERAL NOTES:

- 1. ROUTE ALL ELECTRICAL COMPONENTS TO DECORATIVE LIGHTING OUT OF CUSTOMER'S VIEW.
- 2. USE ALUMINUM KICK PLATES ON BOTH THE INSIDE AND OUTSIDE OF REST ROOM DOORS. (BY OWNER)
- 3. ALL FIXTURES ON DOORS TO BE US26D DULL CHROMIUM UNLESS OTHERWISE SPECIFIED. 4. MAIN SALES CABINET TO BE FINISHED IN (L1) ON EMPLOYEE SERVICE SIDE AND SUPPORT AREAS.
- 5. COOLER DOORS TO BE FACTORY FINISH BLACK FRAMES.
- 6. SALES FLOOR GONDOLAS TO BE FACTORY FINISHED BLACK. 7. ALL FLOOR TILE GROUT TO HAVE "GROUT BOOST."
- 8. EXPOSED DUCTWORK MUST BE PRIMED AND PAINTED BEFORE CEILING IS PAINTED.
- 9. CONTRACTOR SHALL CAULK DOOR JAMBS INSIDE RESTROOMS WITH SANDED CAULK PROVIDED BY LOUISVILLE TILE. ALL OTHER DOOR JAMBS AND MARLITE TO
- BE CAULKED WITH SHERWIN WILLIAMS POWER HOUSE 60 YR, COLOR: TO MATCH GROUT
- 10. ALL GYPBD WALLS SHALL BE PAINTED. 11. PAINT EXPOSED STRUCTURE
- 12. PROVIDE AND INSTALL RONDEC MTL TRIM AT ALL OUTSIDE TILE CORNERS AND WHERE NOTED ON INTERIOR ELEVATIONS.
- 13. "GROUT BOOST" TO BE USED TO MIX GROUT INSTEAD OF WATER.
- 14. ALL EXTERIOR BOLLARDS SHALL BE PAINTED BY NEWCOMB OIL CO
- 15. INSTALL WHITE CAULK AT ALL WALL TO CEILING JOINTS
- 16. TOP OF "WT5" TILE SHALL BE APPROXIMATELY 41" ABOVE FINISH FLOOR TO PREVENT THIN CUT TILE AT FLOOR AND CEILING. THE 41" DIMENSION CAN BE ADJUSTED SLIGHTLY TO ACHIEVE NO LESS THAN HALF A TILE AT THE FLOOR AND CEILING.



0005	DESCRIPTION - REFER TO INTERIOR RENDERINGS FOR OVERALL GRAPHIC APPEARANCE.
CODE	CONTACT PARAGON FOR ORIGINAL ARTWORK.
1D	"FIVE STAR" SIGN: THE TEXT IS TO BE 1" DIMENSIONAL TEXT & BACKLIT IN WHITE LED HALO LIGHTING.
טו	THE TEXT IS TO BE PAINTED ON ALL SIDES.
3D	"COFFEE BREW" SIGN/GRAPHIC: THE BACKGROUND CIRCLE IS TO BE HUNG FROM THE CEILING BY A CHAIN LINK.
35	THE "COFFEE BREW" TEXT IS TO BE BACKLIT IN RED LED HALO. THE CUP IS TO BE 3D AND PROTRUDING FROM THE CIRCLE.
4D	"FREEZE & FOUNTAIN" SIGN: THE BACKGROUND BAND IS TO BE A BRUSHED STAINLESS STEEL METAL.
	THE "FREEZE & FOUNTAIN" TEXT ARE TO BE BACKLIT IN BLUE LED HALO LIGHTING.
5D	"RESTROOM", "MENS", & "WOMENS" SIGNS: THE "RESTROOM" TEXT IS TO BE 1/2" THICK DIMENSIONAL & PAINTED ON ALL SIDES.
	THE MENS & WOMENS TEXT IS TO BE 1/4" THICK DIMENSIONAL AND FACED IN A BRUSHED STAINLESS STEEL LAMINATE.
6D	"GET THE FIVE STAR TREATMENT EVERY TIME" SIGN: THE TEXT IS TO BE 2" THICK DIMENSIONAL TEXT AND PAINTED ON
	ALL SIDES. THE LETTERS ARE TO BE BACKLIT IN YELLOW LED HALO LIGHTING.
7D	"ATM" SIGN: THE TEXT IS TO BE 1/2" THICK DIMENSIONAL TEXT AND OUTLINED IN BRUSHED STAINLESS STEEL.
. –	NOTE: NOT IN ELEVATIONS - TO BE PROVIDED AS NECESSARY. BY OWNER.
	"THE BEER CAVE" SIGN/GRAPHIC: THE BACKGROUND OVAL IS TO BE MADE OF BRUSHED STAINLESS STEEL (OR ALUMINUM).
8D	"THE BEER CAVE" TEXT IS TO BE 2" THICK DIMENSIONAL TEXT AND PAINTED ON ALL SIDES.
OD	THE 3 SNOW FLAKES ARE TO BE AT 3 DIFFERENT DEPTHS AND THE ARE TO HAVE BLUE LED HALO LIGHTING PLACED BEHIND
	EACH INDIVIDUAL CIRCLE.
9D	ICE WALL GRAPHIC: IS TO BE A DIGITALLY PRINTED WALL GRAPHIC WRAP TO BE APPLIED TO THE INTERIOR WALLS OF THE
0D	BEER CAVE. MAKE SURE ALL ASSEMBLY ELEMENTS ARE ADAPTABLE FOR CONSTANT COLD TEMPERATURES.

GRAPHIC GENERAL NOTES

- 1. DETERMINE ALL GRAPHIC APPLICATIONS BY USING FIELD DIMENSIONS ONLY.
- 2. NO GRAPHIC SUBSTITUTIONS ARE ALLOWED WITHOUT PARAGON SOLUTIONS OR OWNERS CONSENT.
- 3. REVIEW ALL FINAL PRODUCTION DRAWINGS WITH PARAGON SOLUTIONS PRIOR TO PRODUCTION.
- 4. PROVIDE INSTALLATION COSTS UNLESS OTHERWISE NOTED.

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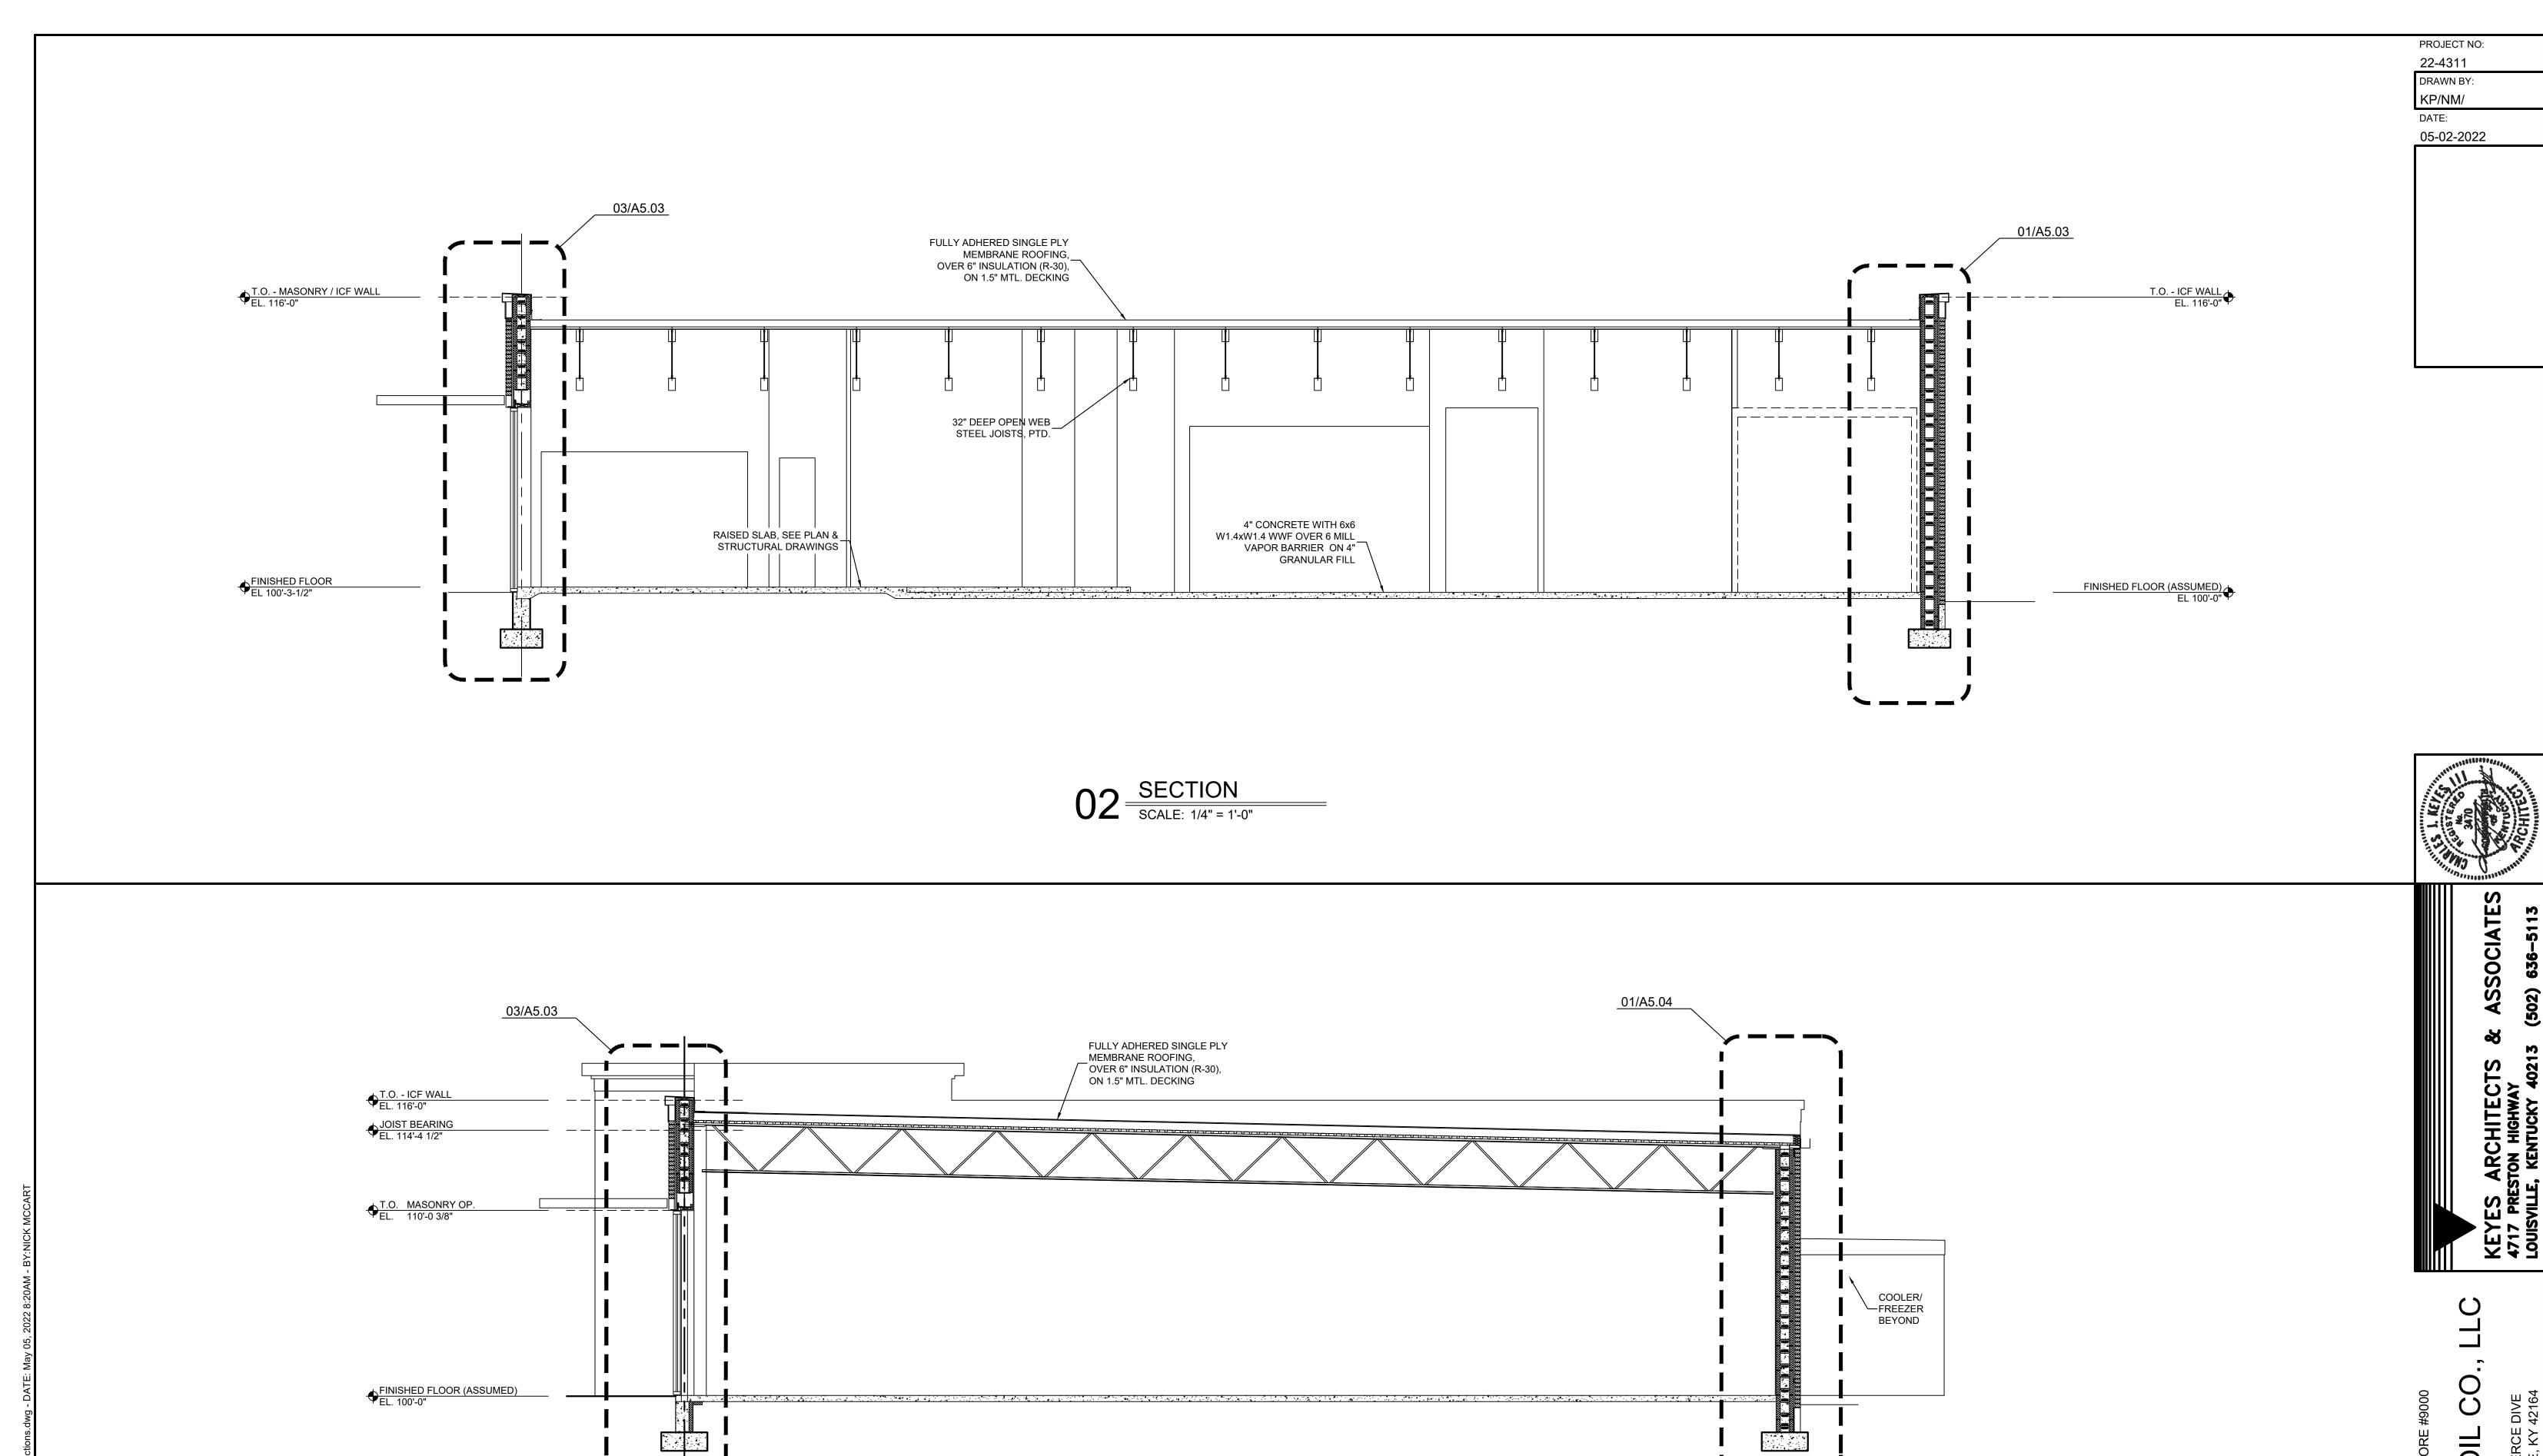
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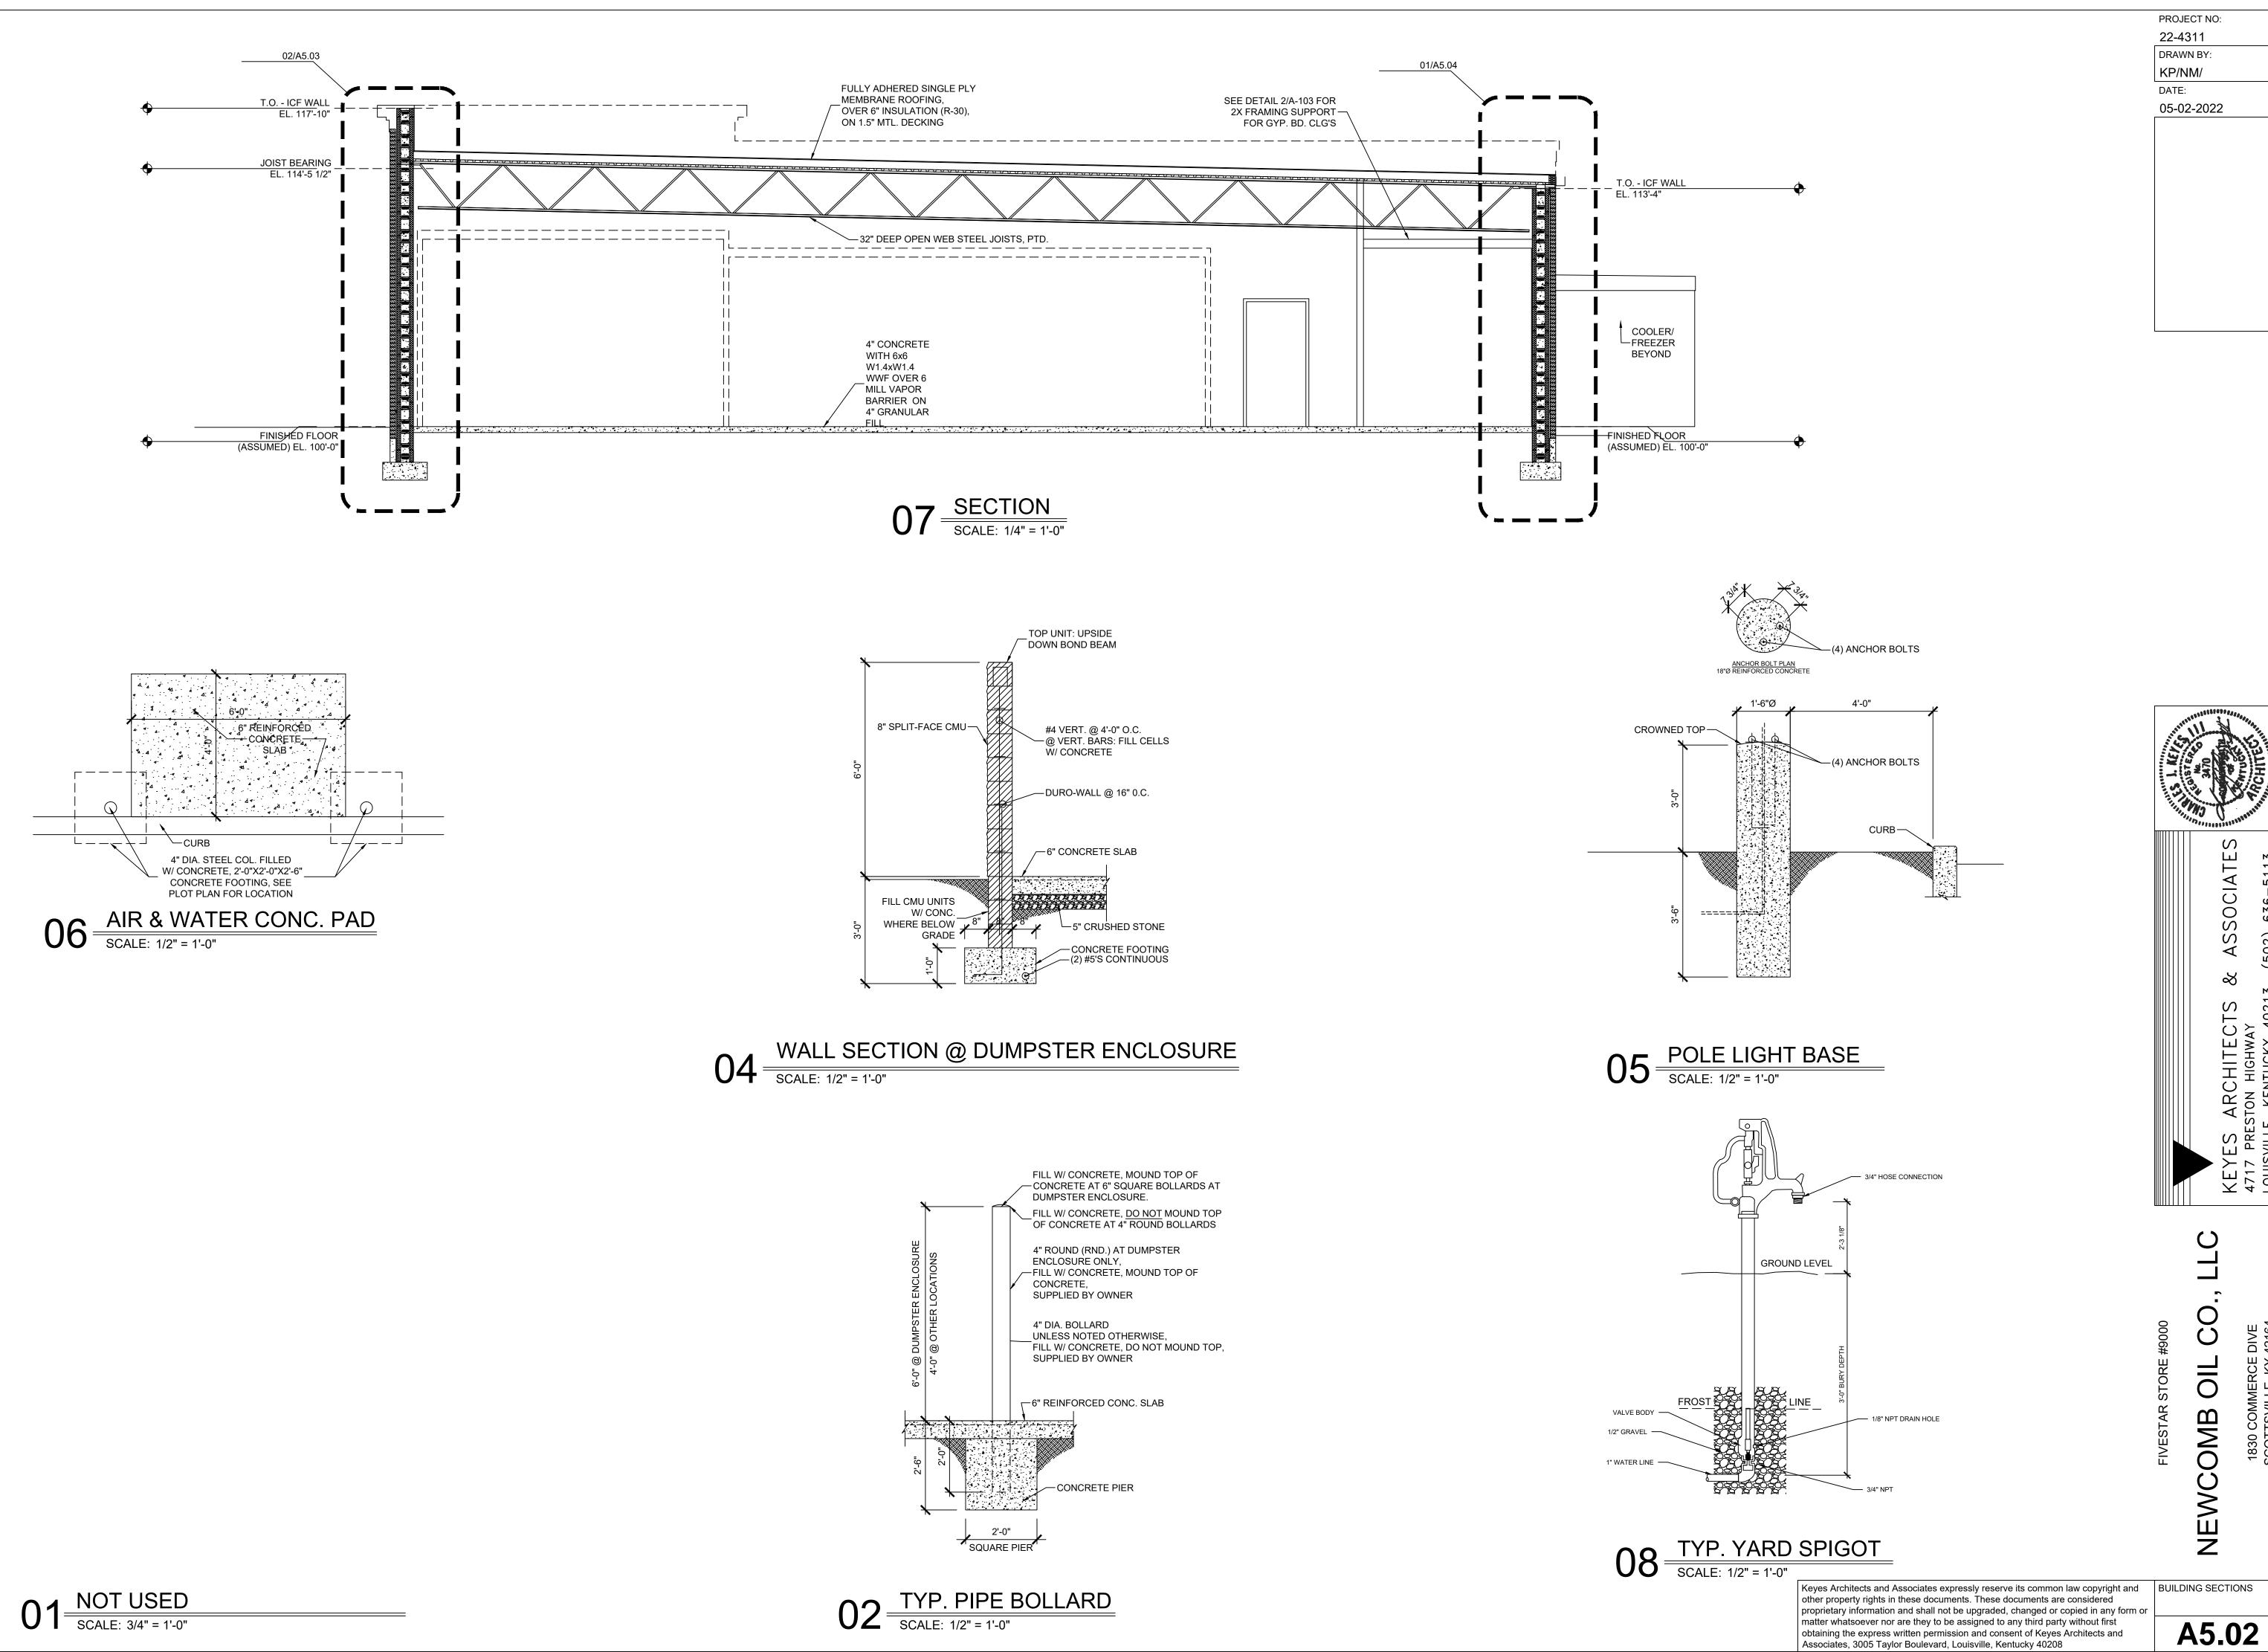
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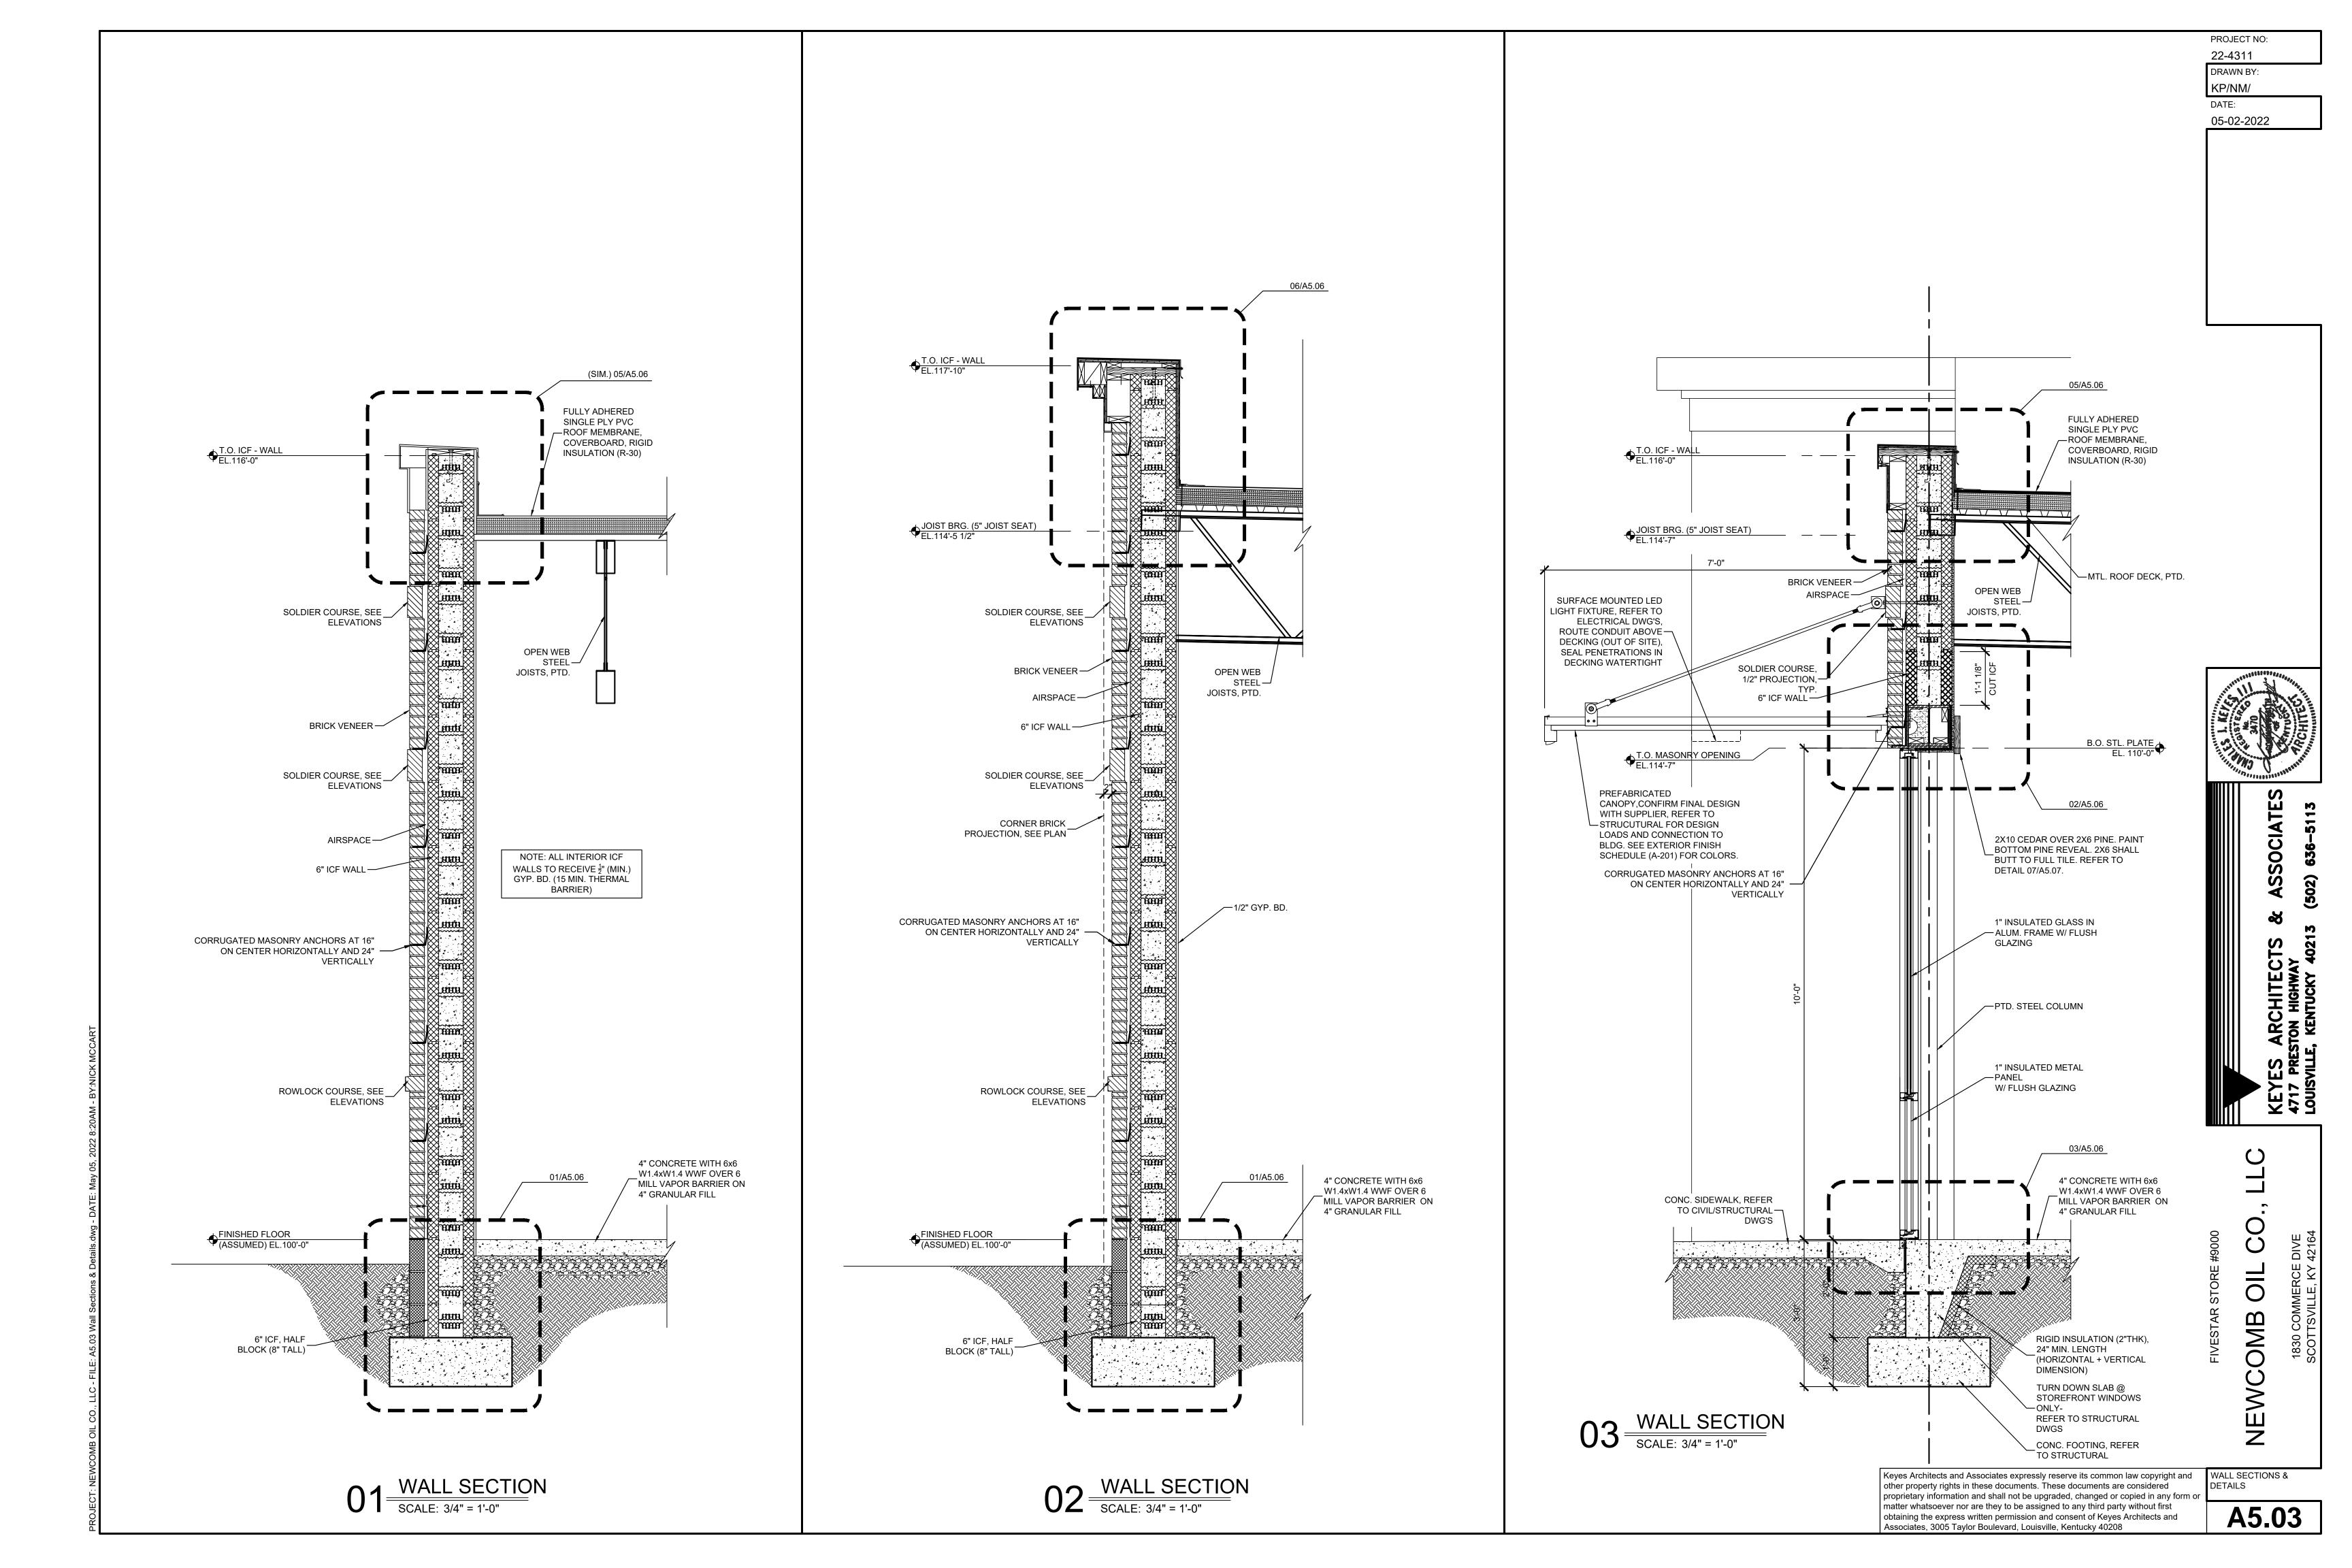


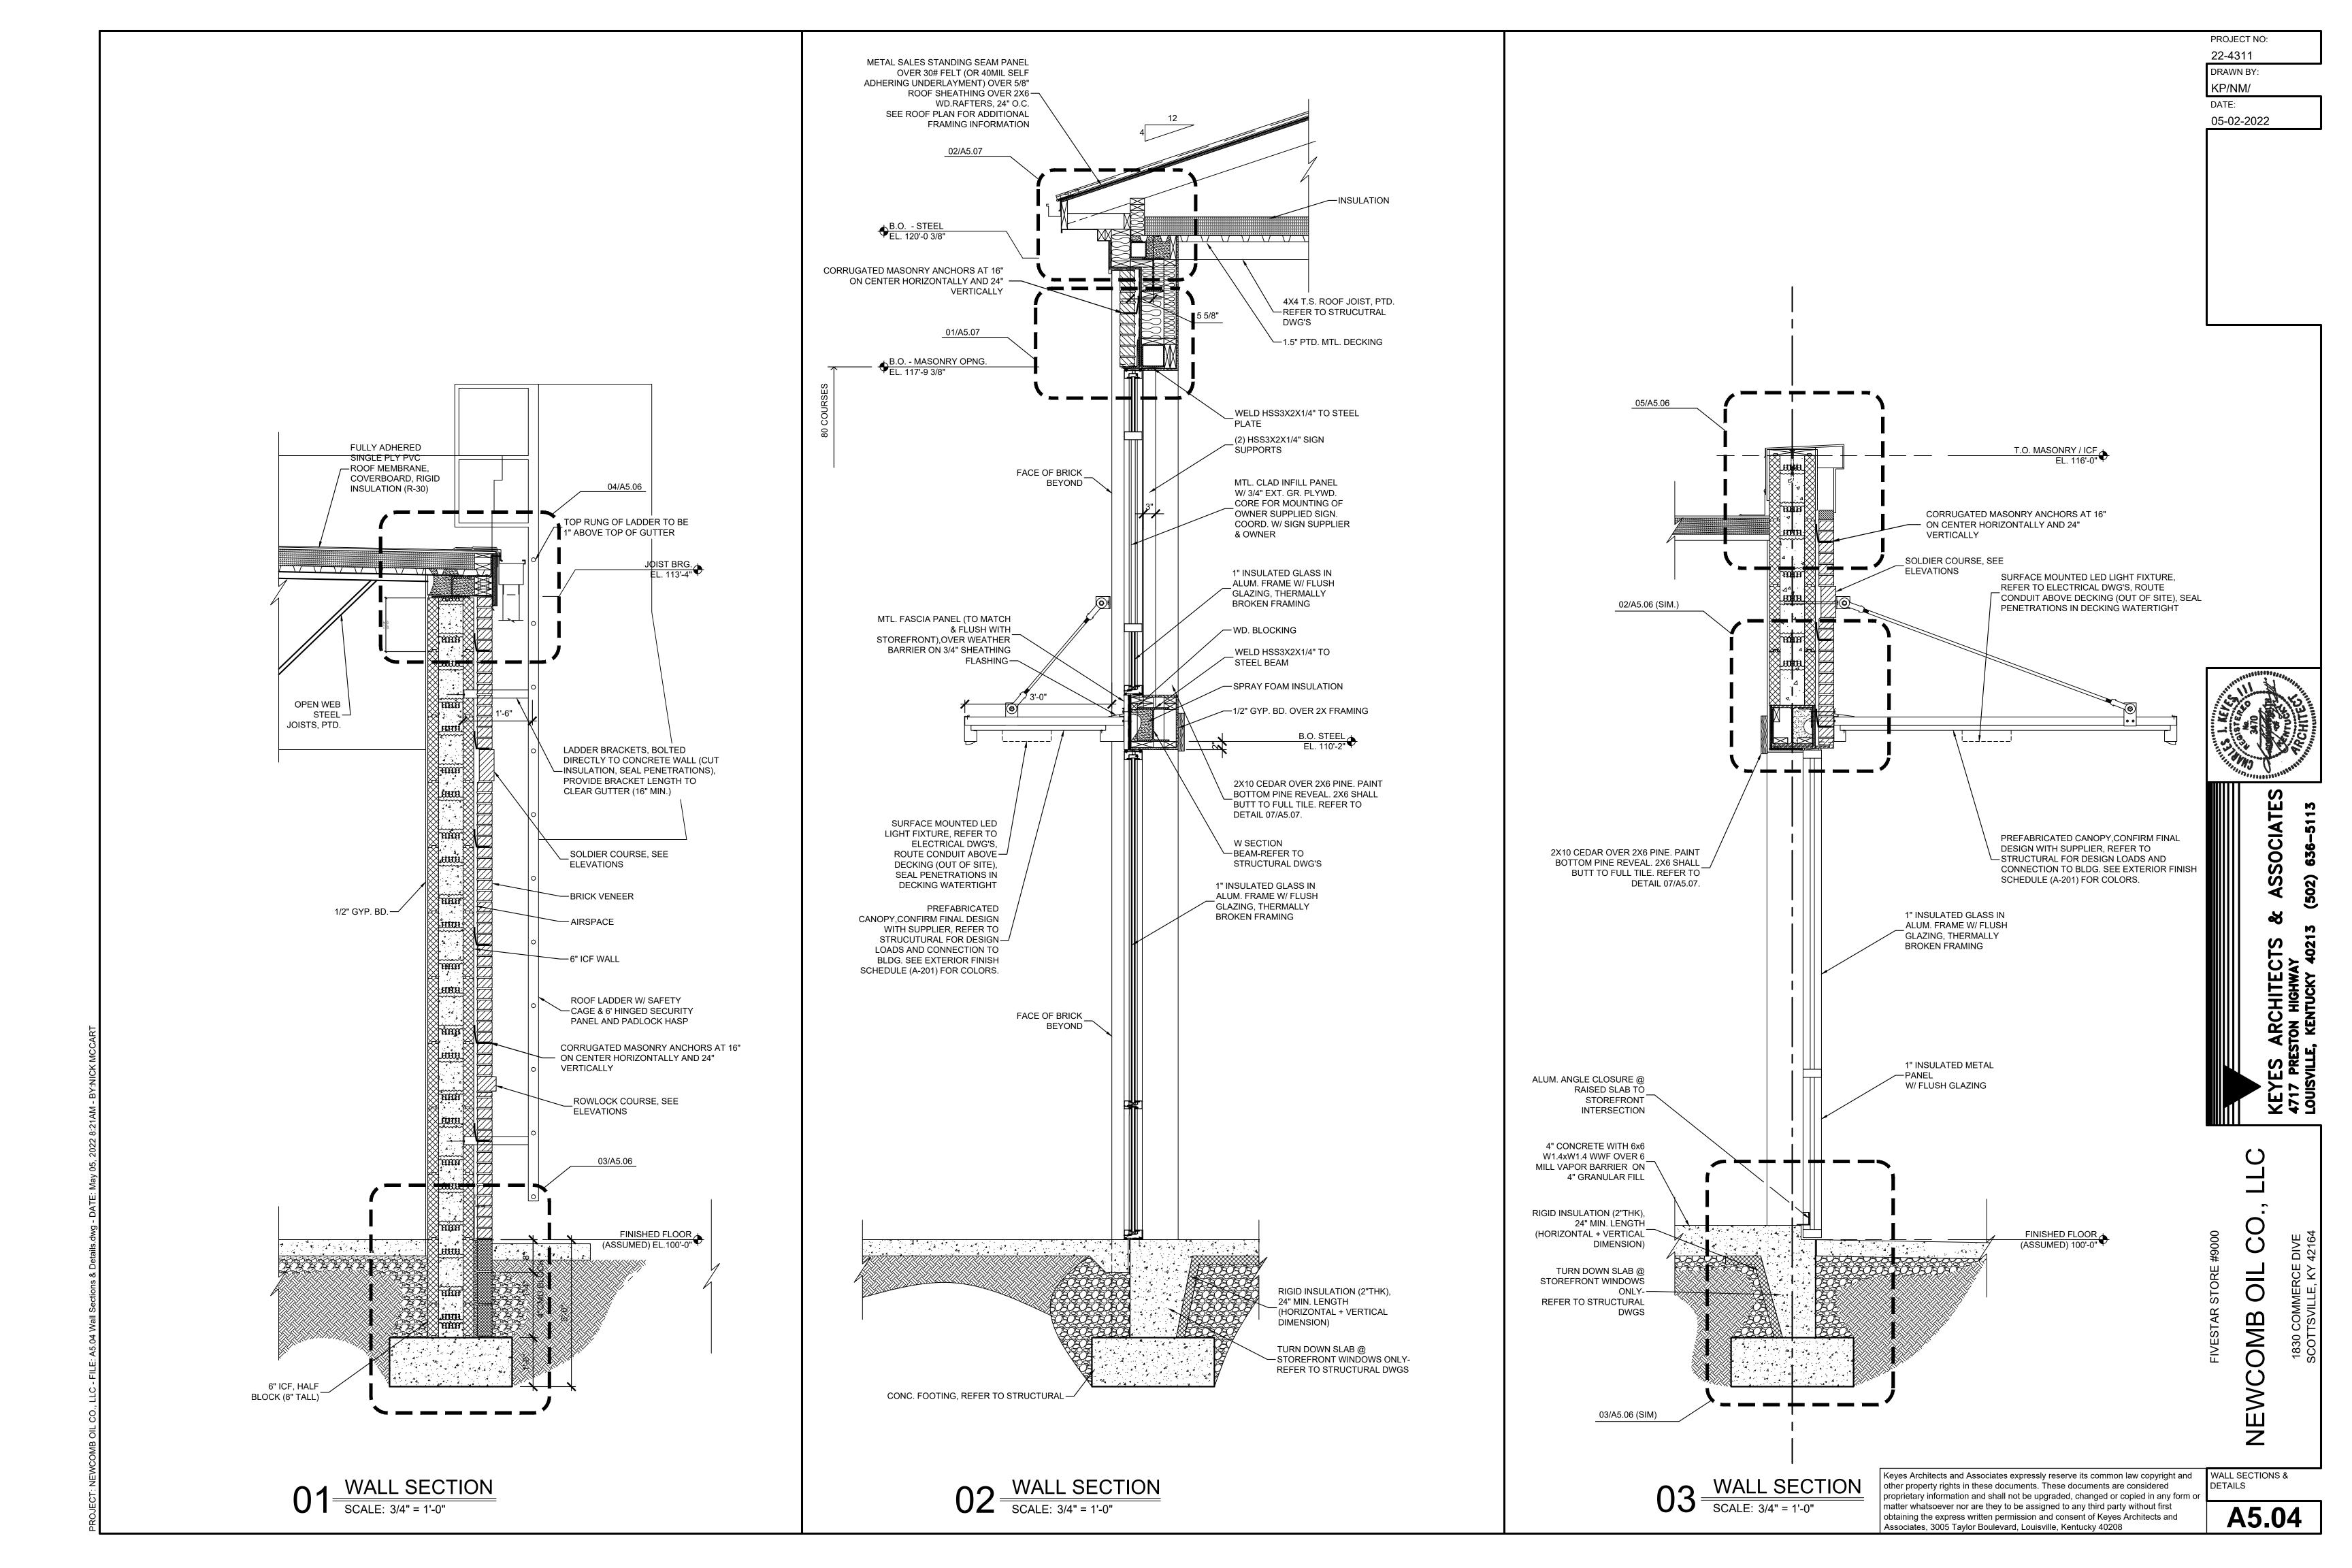
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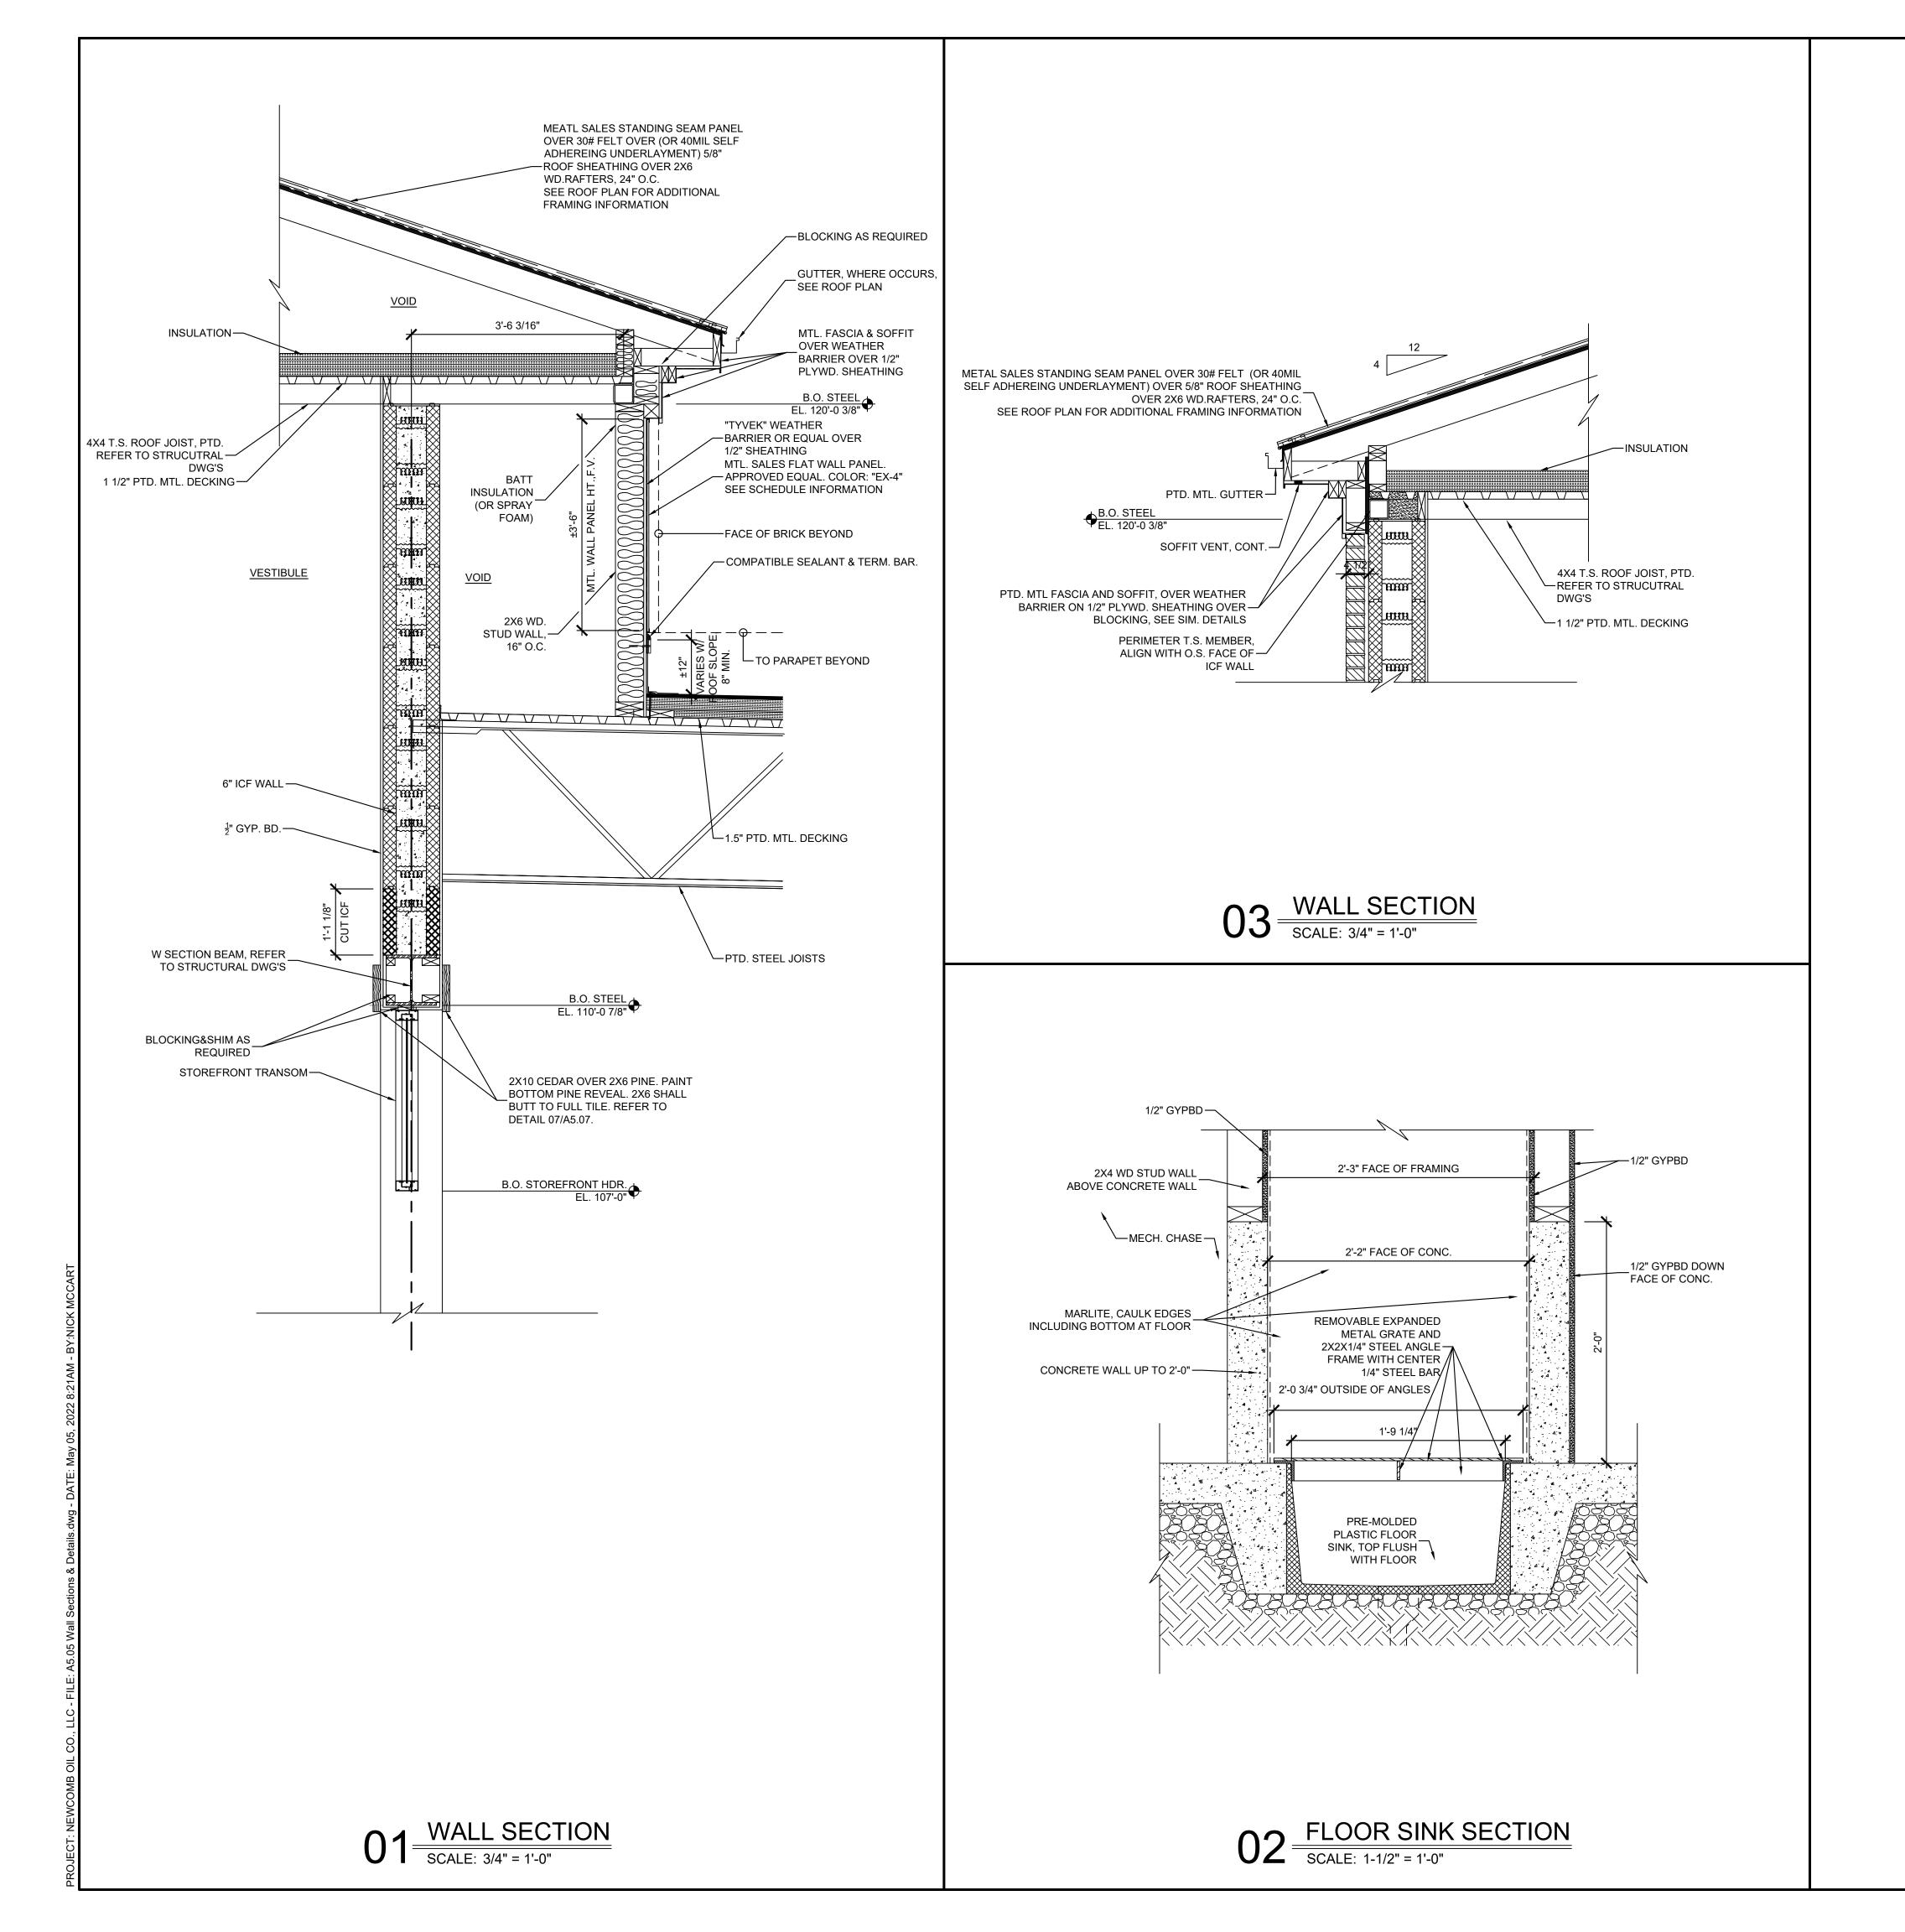
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LE, KENTUCKY 40213

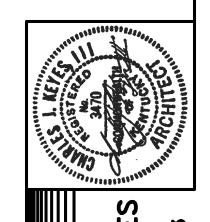
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