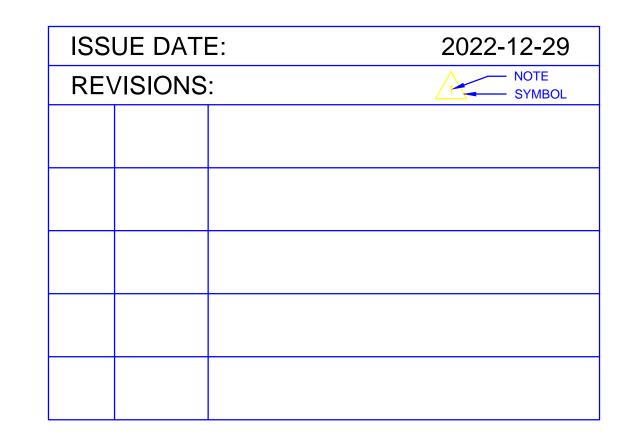
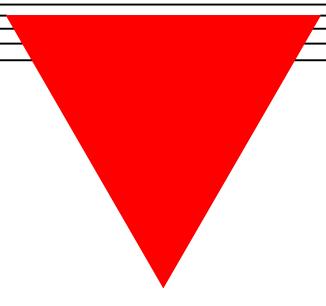
BLEND-PAK ADDITION

10039 HIGHGROVE RD.
BLOOMFIELD, KY





ARCHITECT:

KEYES ARCHITECTS AND ASSOCIATES

4717 PRESTON HIGHWAY

LOUISVILLE, KENTUCKY 40213

PH: (502) 636-5113

CONTACT: ANDREW SKINNER

EMAIL: ASKINNER@KEYESARCHITECTS.COM

ARCHITECT: CHARLES J. KEYES III

OWNER:

BLEND-PAK, INC. 10039 HIGHGROVE RD. BLOOMFIELD, KY 40008 (502)252-8000

CONTRACTOR:

BCD INC.

1962 FILIATREAU LN

BARDSTOWN, KY 40004

(502)348-2305

JASON HARROD

JHARROD@BARDSTOWN.COM

PROJECT INFORMATION KENTUCKY BUILDING CODE (KBC ADAAG 2010/ ANSI A117.1 2009 ACCESSIBILITY CODE **ENERGY CODE** IECC 2012 <u>USE AND OCCUPANCY:</u> S-2 WAREHOUSE STORAGE CONSTRUCTION TYPE: II-B **BUILDING INFORMATION** 28,846 s.f. **EXISTING BUILDING:** 5,949 s.f. **BUILDING ADDITION: NEW BUILDING:** 44,695 s.f. TOTAL BUILDING SIZE: FIRE SUPPRESSION:

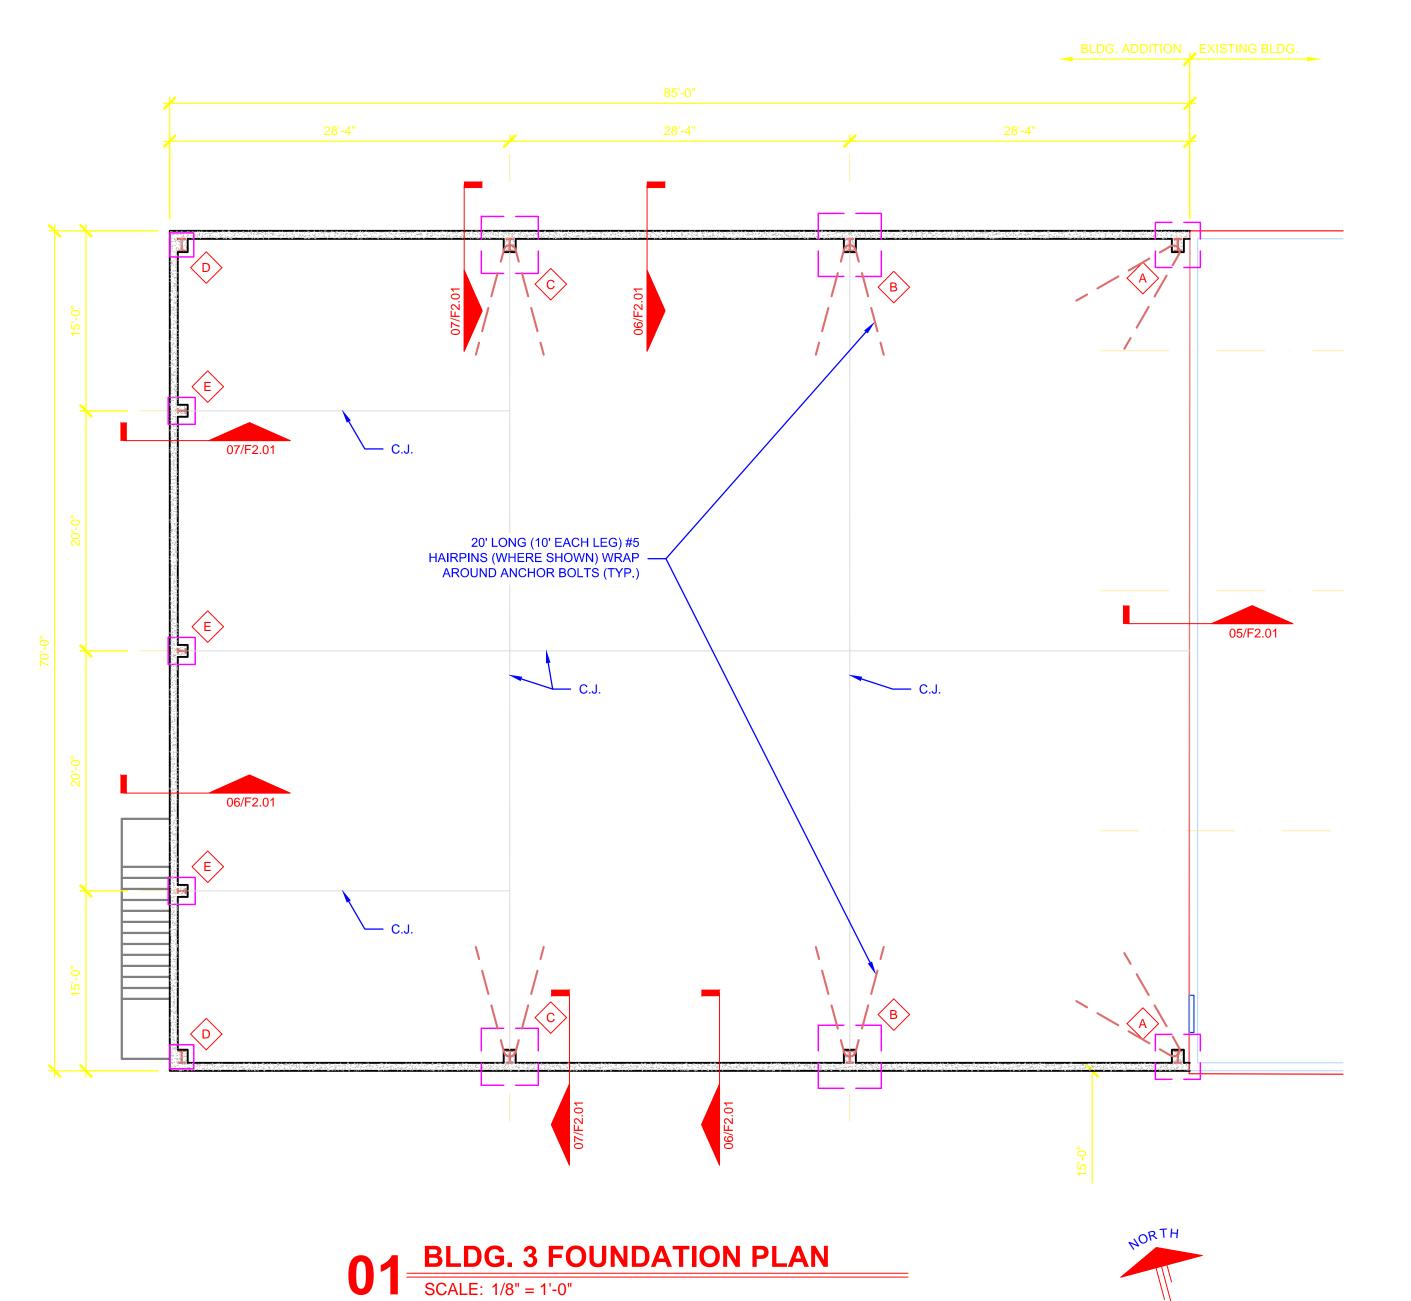
OCCUPANCY ALLOWANCE

FUNCTION OF SPACE ALLOWANCE AREA OCCUPANCY

TOTAL OCCUPANCY ALLOWANCE:

Sheet List Table

Sheet Number	Sheet Title						
T1.01	Title Sheet						
Demolition Plans & Details							
D1.01	Demolition Plan						
Foundation Plans &	Details						
F1.01	Foundation Plan						
F1.02	Foundation Plan						
F2.01	Foundation Details						
Life Safety Plans							
LS1.01	Life Safety Plan						
Floor Plans							
A1.01	Floor Plan						
Exterior Elevations							
A2.01	Exterior Elevations						
Schedules and Stan							
A3.01	Commercial ADA-Ansi						
	Guidelines Accessibility Site Details						
A3.02 A3.03	Schedules						
Details & Sections	Concadics						
A5.01	Wall Sections and Details						
A6.01	Door Details						
A6.02	Window Details						
Specifications							
SP1.01	Specifications						
SP1.02	Specifications						
SP1.03	Specifications						
SP1.04	Specifications						



FOOTING SCHEDULE									
TYPE	SIZE	REINFORCING	MIN. PIER	DETAILS	REMARKS				
Α	3'-9" x 3'-9" x 1'-3"	(5) #5 BARS E.W. BTM.	12" x 24"	##/F#.##	1				
В	5'-3" x 5'-3" x 1'-3"	(7) #5 BARS E.W. BTM.	12" x 24"	##/F#.##	2				
С	4'-9" x 4'-9" x 1'-3"	(6) #5 BARS E.W. BTM.	12" x 24"	##/F#.##	3				
D	2'-0" x 3'-0" x 1'-3"	#5 BARS @ 12" E.W. BTM.	12" x 24"	##/F#.##	4				
Е	2'-3" x 2'-3" x 1'-3"	(3) #5 BARS E.W. BTM.	12" x 24"	##/F#.##	5				
F	3'-0" x 3'-0" x 1'-3"	(4) #5 BARS E.W. BTM.	12" x 24"	##/F#.##	6				

3. COMBINATION FOOTING-MULTIPLE COLUMNS.

4. VERIFY EXISTING FOOTING AND DEPTH.

2. VERIFY THAT PIER CAN SET ON EXISTING RAMP FOUNDATION, EPOXY SET (4) #6 DOWELS BALANCE SIM. TO DETAIL #4/F2.01.

1. PIER AND FOUNDATION WITH WALL CURB.

FOUNDATION NOTES

1) CONCRETE CONTRACTOR MUST VERIFY LOCATION, SIZES AND PLACEMENT OF ANCHOR BOLTS USING BUILDING MANUFACTURER'S DATA. CONTRACTOR MUST VERIFY IN FIELD.

2) ALL CONCRETE TO BE 4,000 P.S.I.

3) CONTRACTOR TO PROVIDE REINFORCED CONCRETE WORK REQUIRED FOR BRACED BAYS. VERIFY REQUIREMENTS WITH BUILDING MANUFACTURER.

4) CONTRACTOR TO SUPPLY ARCHITECT WITH BUILDING MANUFACTURER'S STAMPED ENGINEERING DRAWINGS AND BASE REACTIONS BEFORE BEGINNING CONSTRUCTION SO THAT ARCHITECT MAY VERIFY FOUNDATION DESIGN.

5) ALL FOOTINGS AND PIERS ARE TO BE CENTERED ON THE BUILDING COLUMNS UNLESS OTHERWISE NOTED.

6) COLUMN PIERS ARE TO BE PLACED INTEGRAL WITH THE GRADE BEAM OR FOUNDATION WALLS WITH REINFORCING TO BE CONTINUOUS THROUGH PIERS.

7) COLUMN PIERS MUST BE MIN. 12" ANY DIRECTION PLUS 1" PAST MANUF. BASE PLATES. GROUT SOLID BETWEEN PIER AND BASE PLATE. CONTRACTOR MUST COORDINATE WITH BUILDING MANUFACTURER AND VERIFY IN FIELD.

8) BUILDING FOUNDATIONS ARE DESIGNED FOR 1,500 P.S.F. SOIL BEARING CAPACITY. VERIFY BEFORE CONSTRUCTION.

9) ALL ANCHOR BOLTS TO BE SET BY TEMPLATE MATCHING BUILDING MANUFACTURER'S LAYOUTS.

10) NO FIELD ALTERING OF BASE PLATES IS ALLOWED.

11) JUNCTURE OF FLOOR SLAB WITH ALL PIERS AND GRADE TO BE 1/2" WIDE EXPANSION JOINT MATERIAL.

12) CONTRACTOR TO SET OVERHEAD DOOR JAMB ANCHORS INTO FLOOR SLAB AS REQUIRED BY BUILDING MANUFACTURER.

13) FLOOR SLAB TO BE POURED THRU AT ALL DOORWAYS, SLOPE 2% TO OUTSIDE

14) BUILDING ANCHOR BOLTS TO BE DIAMETER DESIGNED BY BUILDING MANUFACTURER. LENGTHS TO BE 3" PROJECTION, 15" IMBEDDED W/ 3" HOOK UNLESS OTHERWISE DESIGNED MY MANUFACTURER OR HERE IN

15) FOOTING TO REST ON UNDISTURBED SOIL. (6) VERIFY FOUNDATION SIZE AND DEPTH OF EXISTING

BUILDING BEFORE CONSTRUCTION. NOTIFY ARCHITECT IF THEY ARE NOT AS SHOWN,

PROJECT NO: R22-3645 DRAWN BY:

2022-12-29

AJS/

DATE:

NOTE: GENERAL CONTRACTOR RESPONSIBLE FOR COORDINATION OF ALL SUB TRADES AND REQUIREMENTS BY OWNER

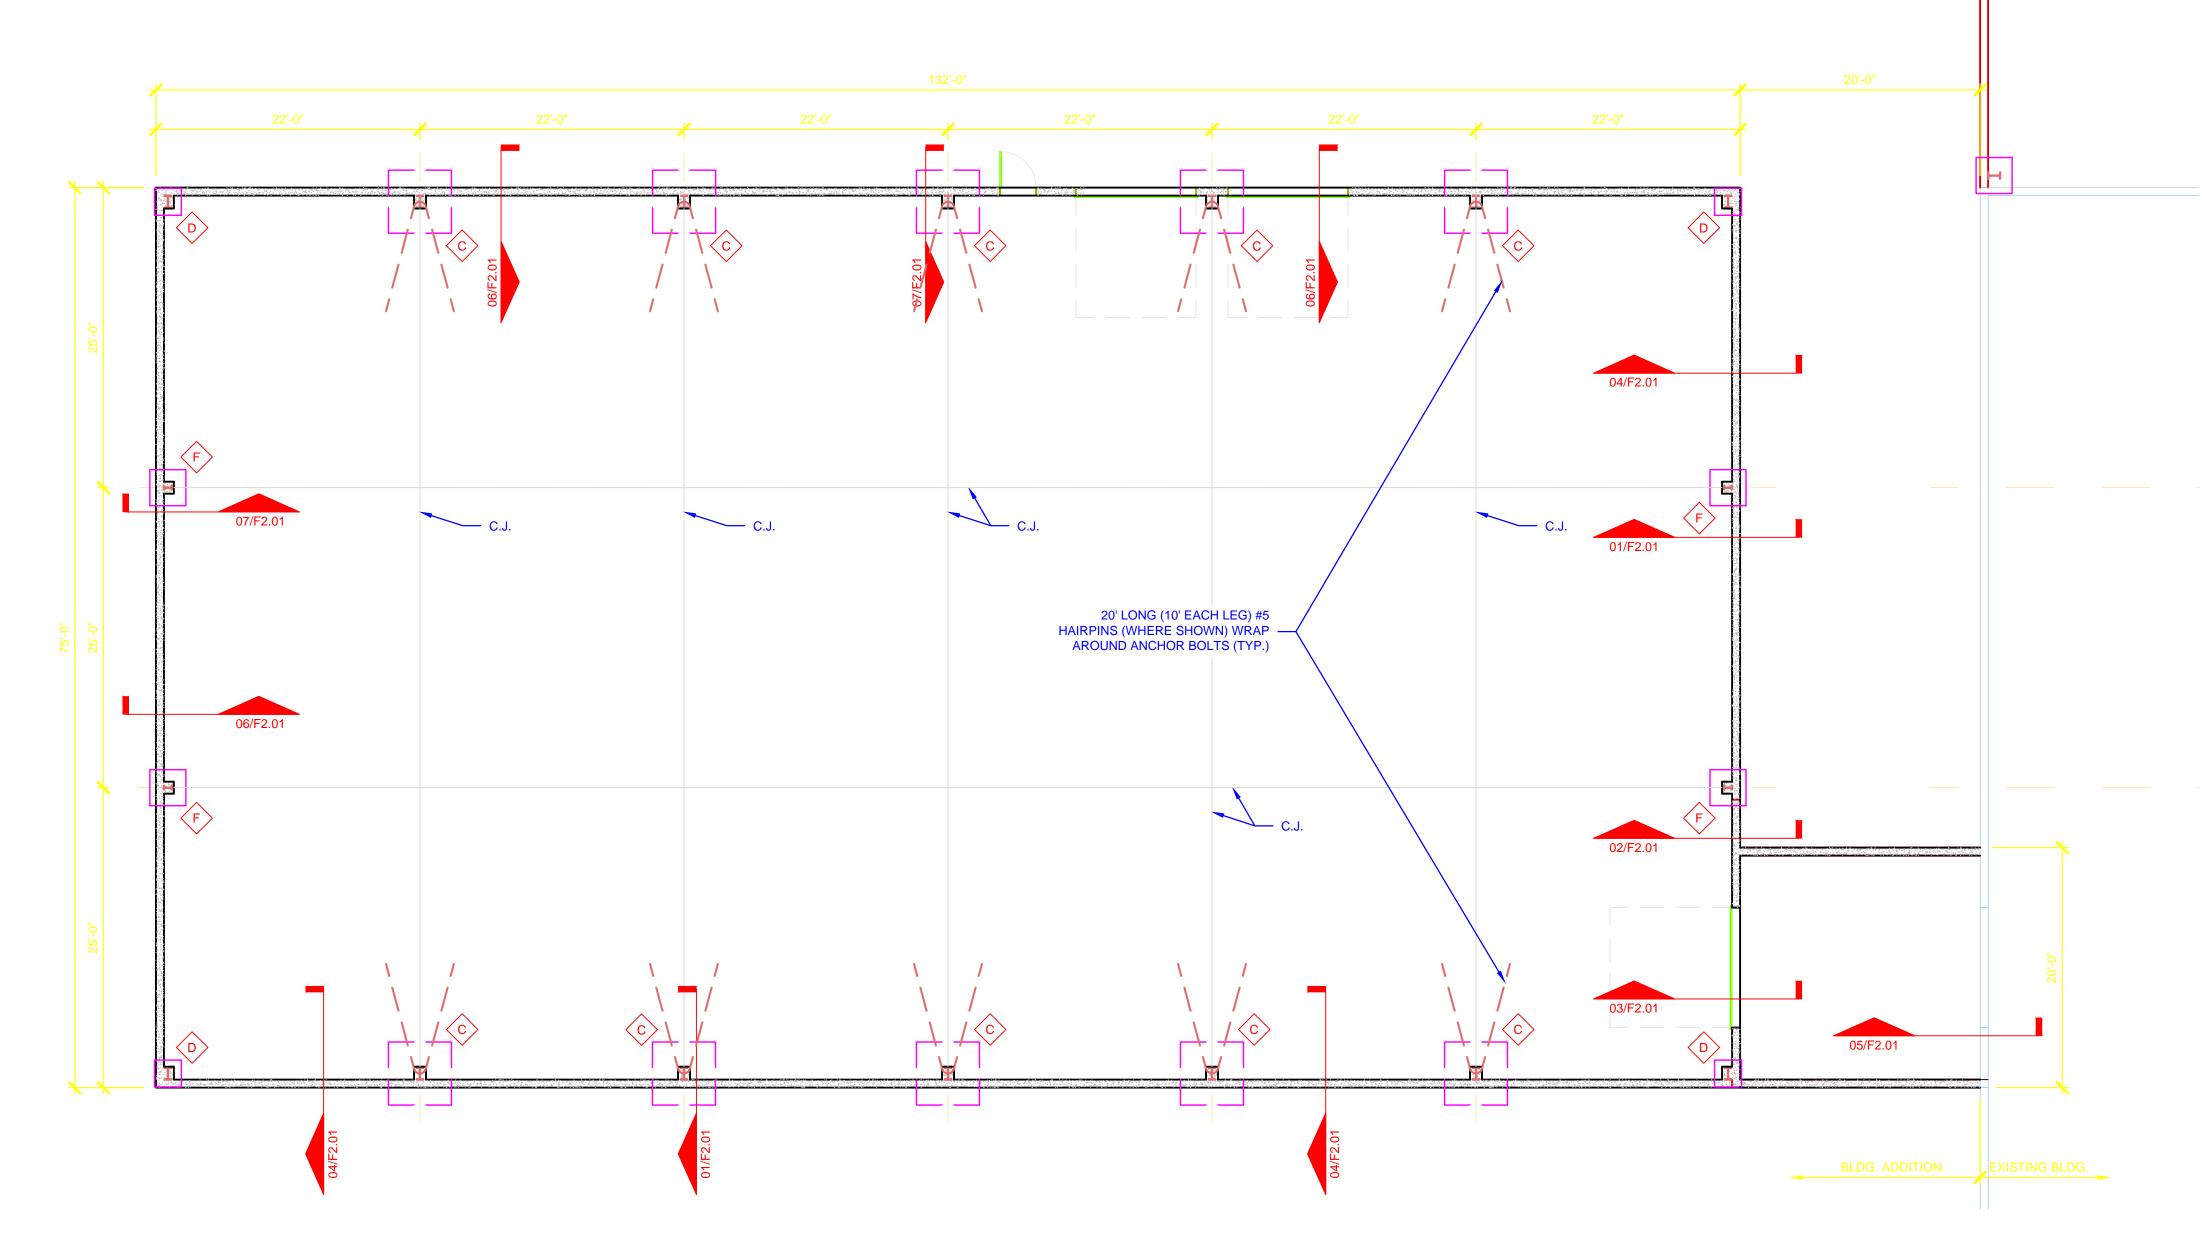
NOTE: ELECTRICAL, HVAC AND PLUMBING TO BE RELOCATED PER FEDERAL, STATE AND LOCAL CODES. GENERAL CONTRACTOR TO COORDINATE.

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F1.01

PROJECT NO: R22-3645 DRAWN BY:

2022-12-29



01 BLDG. 4 FOUNDATION PLAN

SCALE: 1/8" = 1'-0"



FOOTING SCHEDULE								
TYPE	SIZE	REINFORCING	MIN. PIER	DETAILS	REMARKS			
А	3'-9" x 3'-9" x 1'-3"	(5) #5 BARS E.W. BTM.	12" x 24"	##/F#.##	1			
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Е	2'-3" x 2'-3" x 1'-3"	(3) #5 BARS E.W. BTM.	12" x 24"	##/F#.##	5			
F	3'-0" x 3'-0" x 1'-3"	(4) #5 BARS E.W. BTM.	12" x 24"	##/F#.##	6			

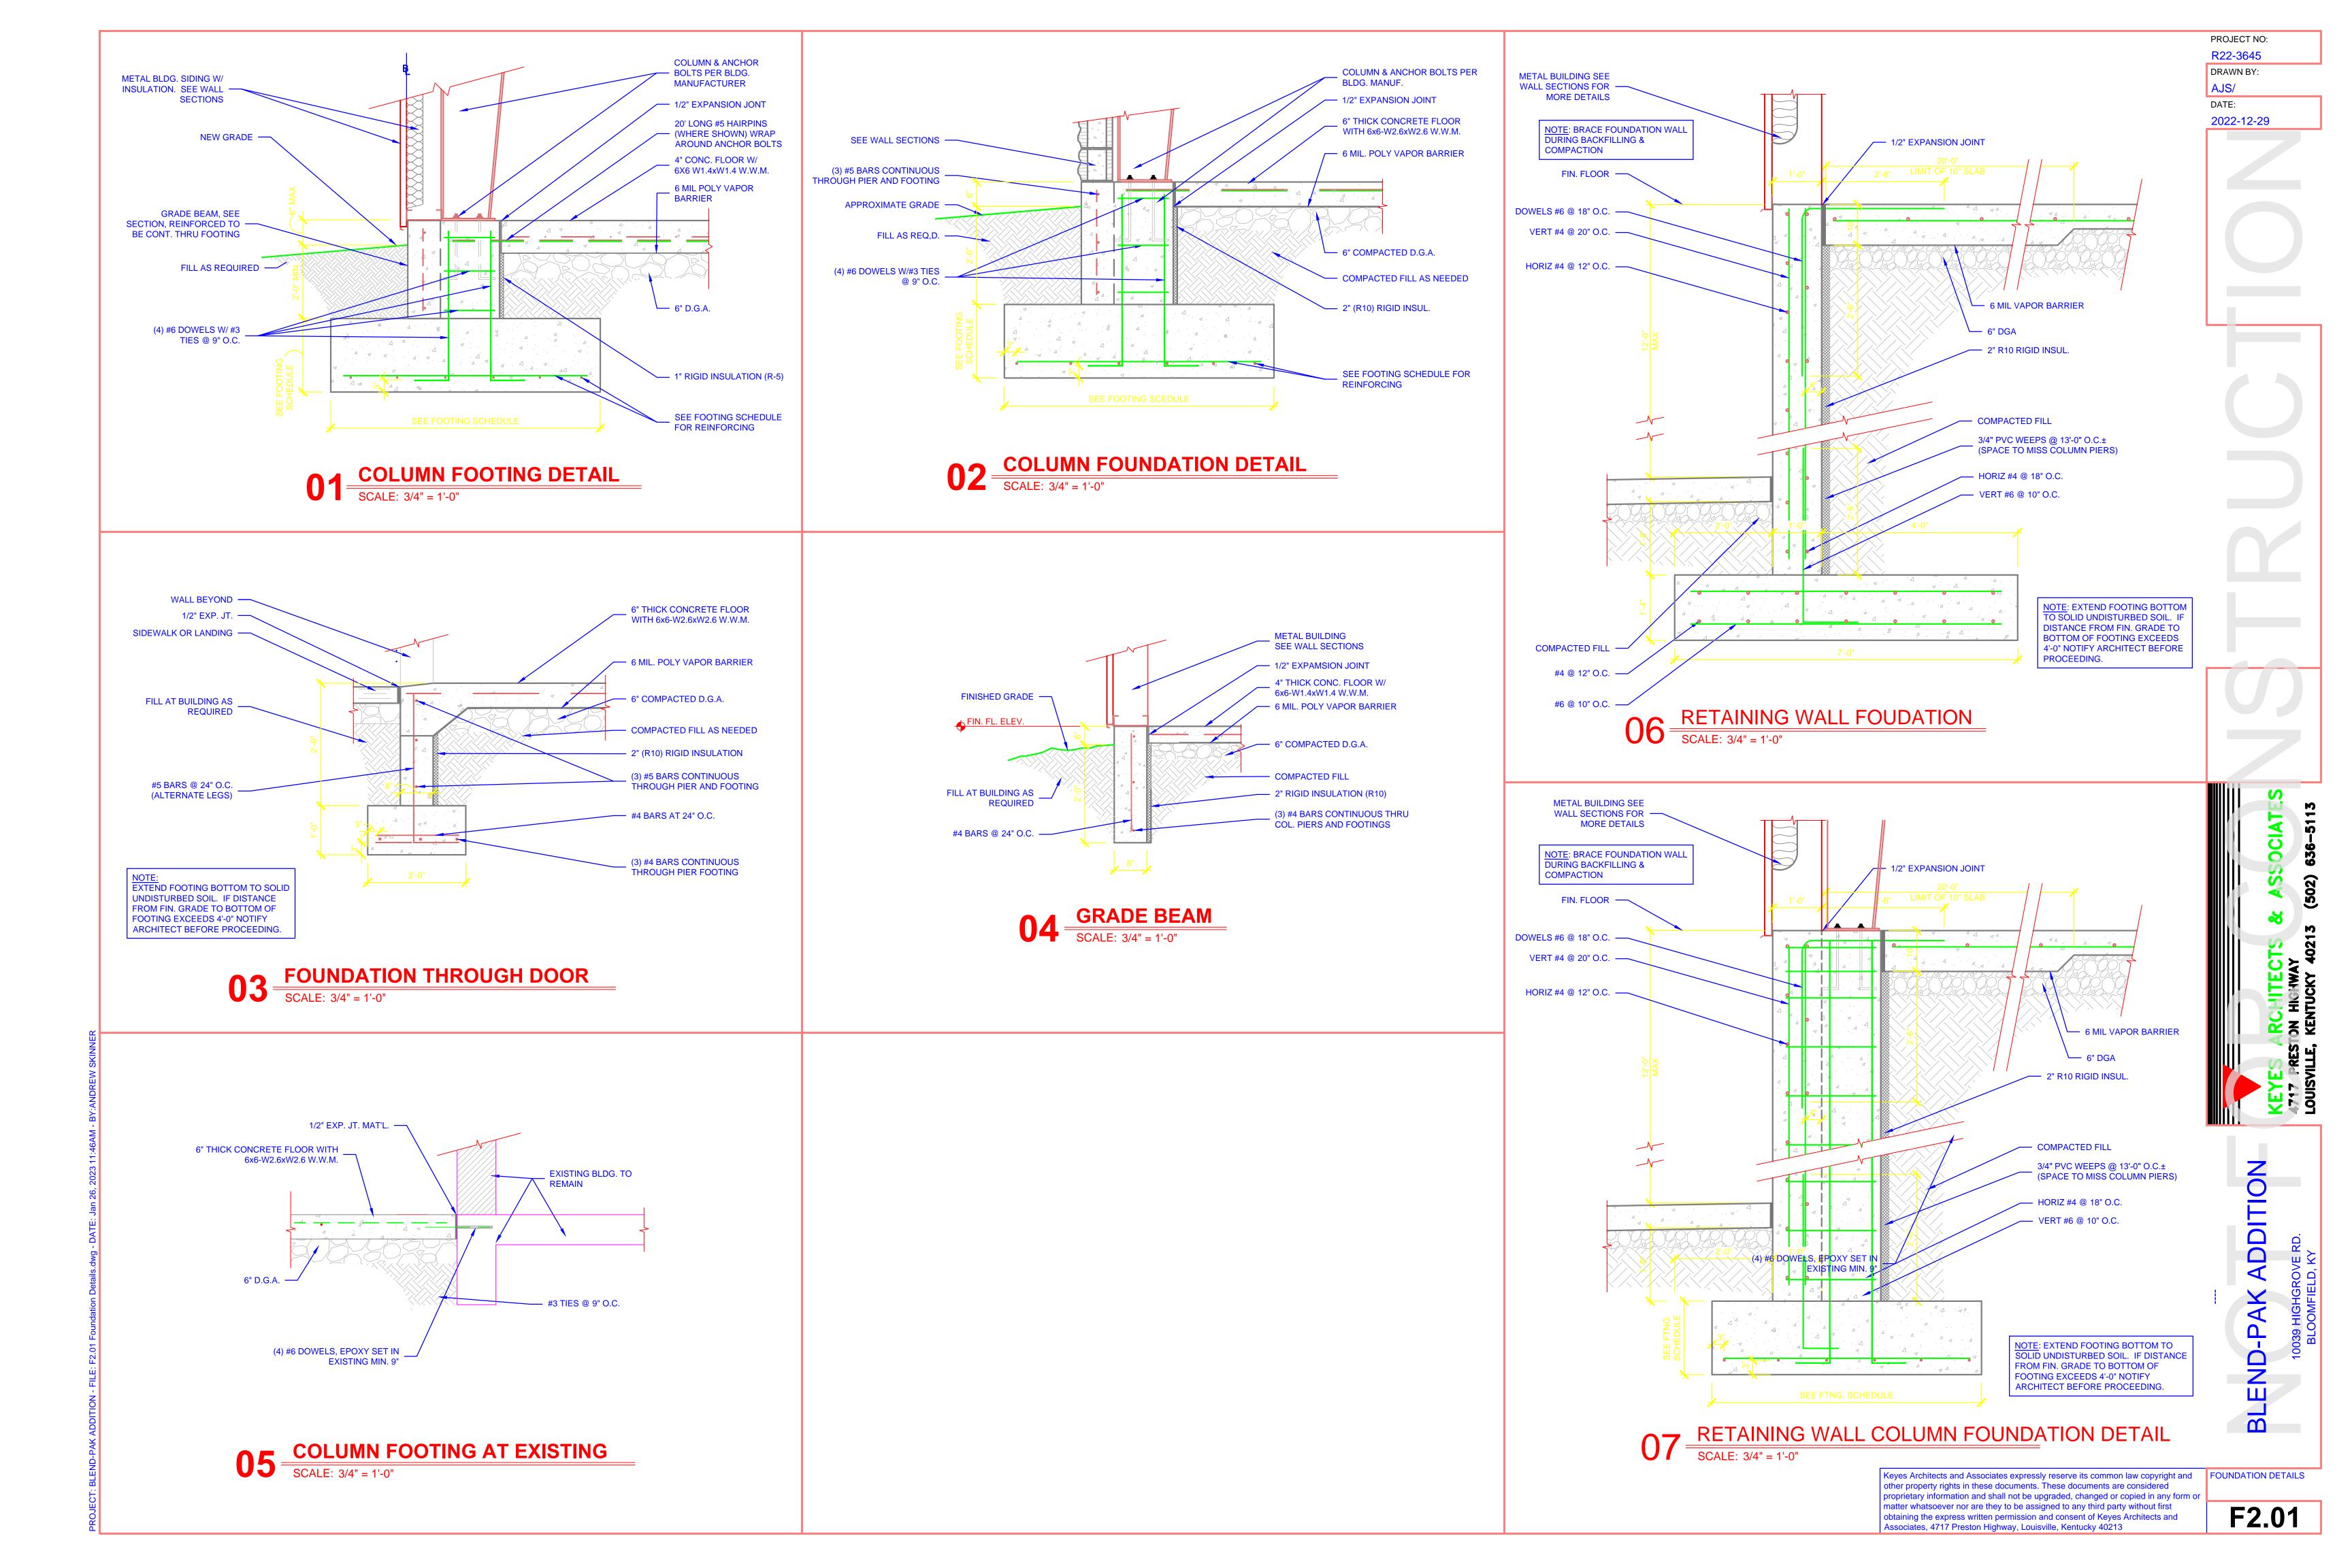
3. COMBINATION FOOTING-MULTIPLE COLUMNS.

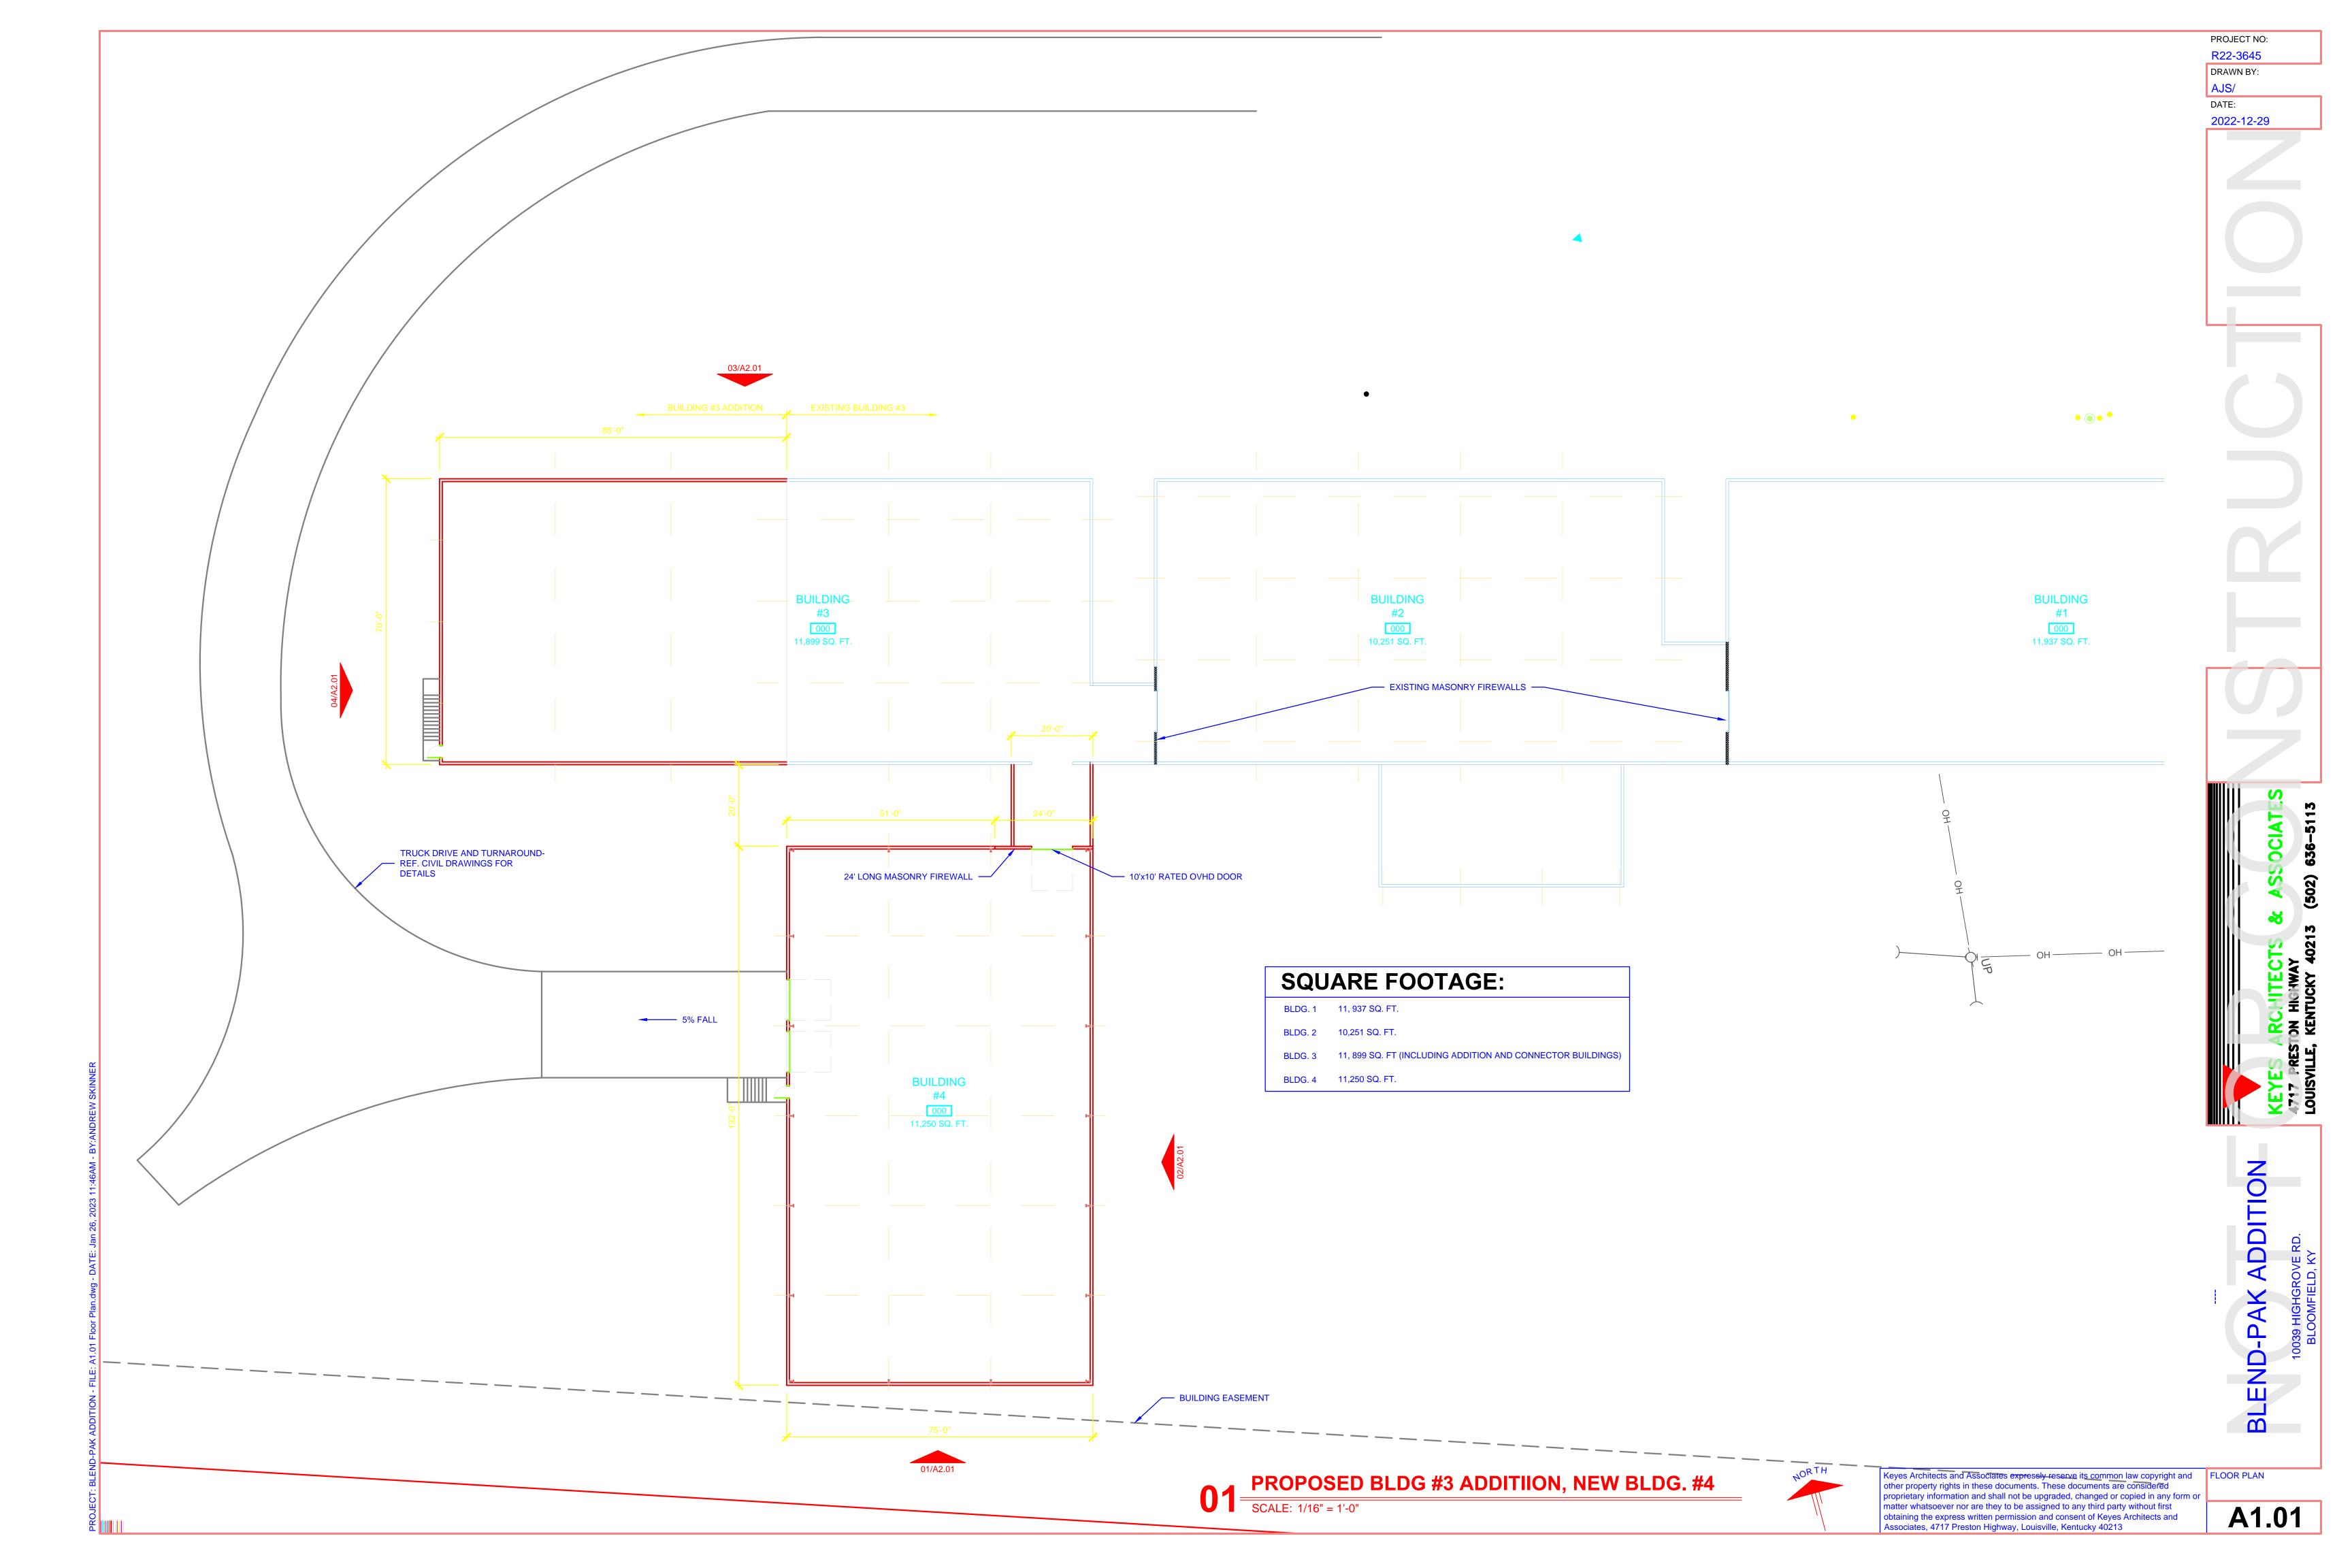
4. VERIFY EXISTING FOOTING AND DEPTH.

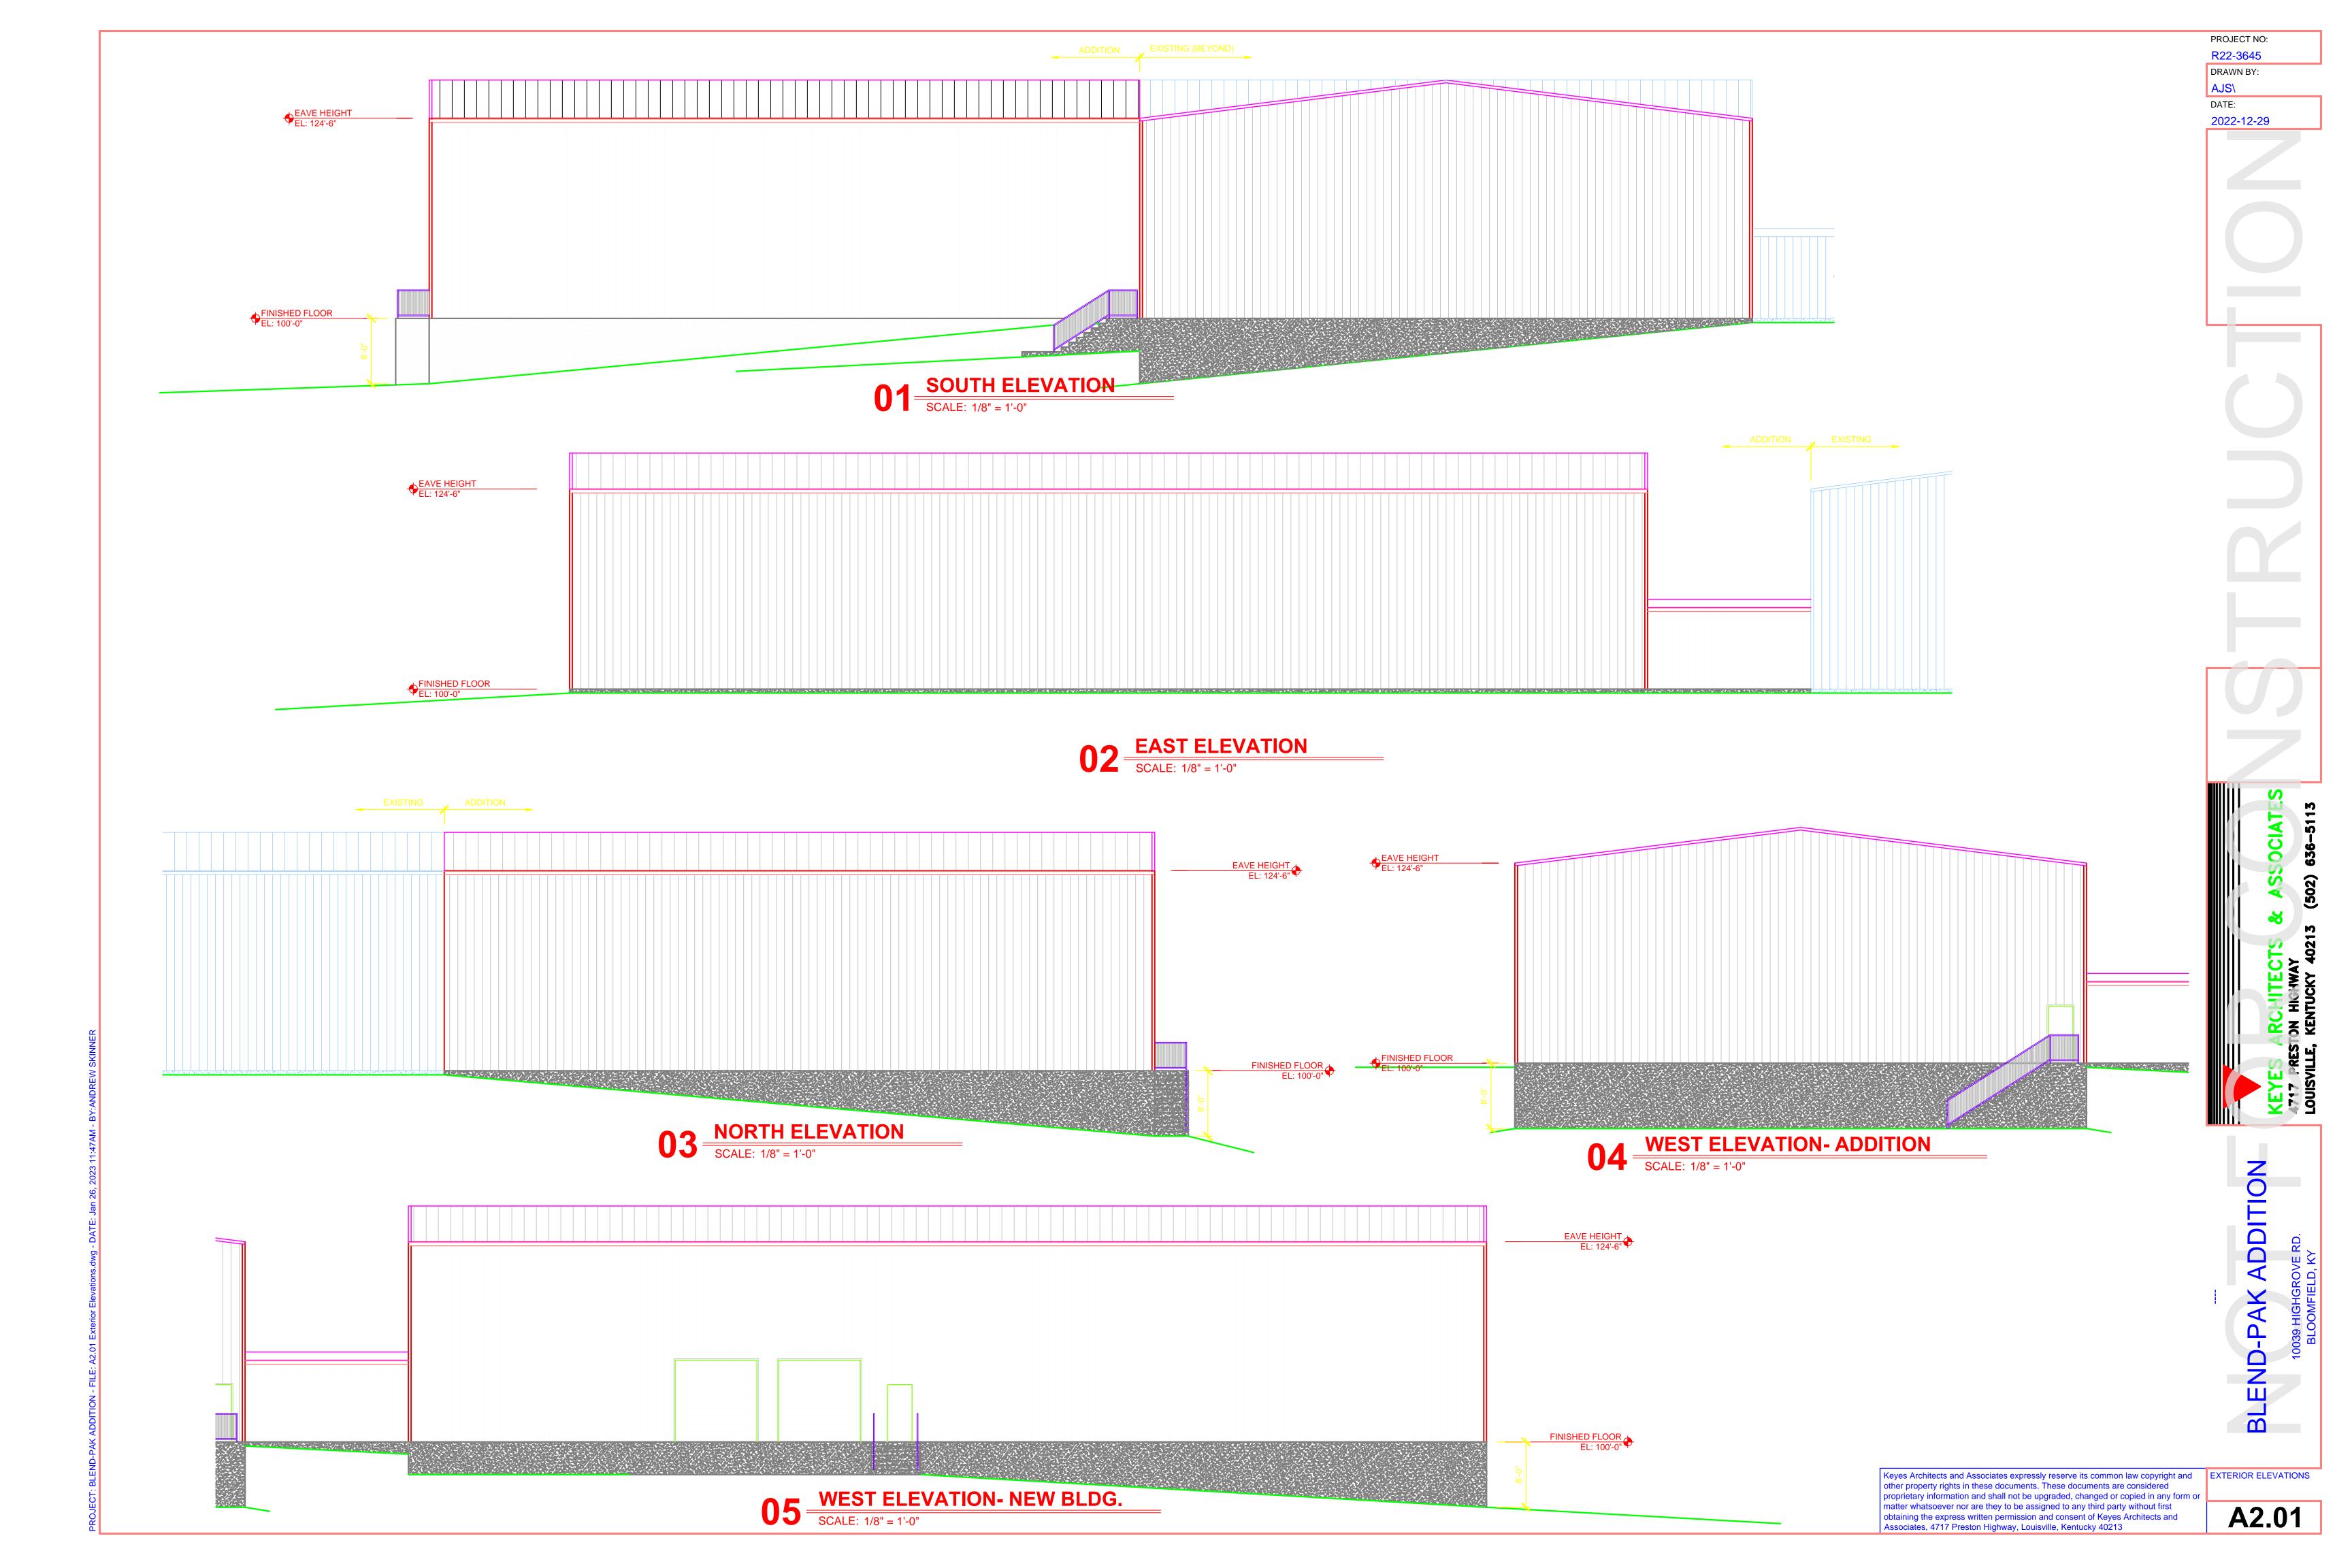
 VERIFY THAT PIER CAN SET ON EXISTING RAMP FOUNDATION, EPOXY SET (4) #6 DOWELS BALANCE SIM. TO DETAIL #4/F2.01.

1. PIER AND FOUNDATION WITH WALL CURB.

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PROJECT NO:

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BLEND-PAK ADDITION
10039 HIGHGROVE RD.